

**City of Lino Lakes
Environmental Board Meeting**

**Wednesday, February 6, 2019
6:30 PM**

AGENDA

1. Call to Order
2. Approval of Agenda
3. Approval of Minutes
4. Open Mike
5. Action Items
 - A. Lyngblomsten Senior Living Community/PUD /Mixed Use/Preliminary Plat Review
6. Discussion Items
 - A. 2019 Goals
 - B. Recycling Updates
 - C. Other Updates: Heron Rookery Maintenance Date, Earth Day, 4-20-2019
7. Adjourn

**CITY OF LINO LAKES
ENVIRONMENTAL BOARD MINUTES Template**

DATE	: November 28, 2018
TIME STARTED	: 6:32 P.M.
TIME ENDED	: 8:24 P.M.
MEMBER PRESENT	: Steve Heiskary (chair), Paula Andrzejewski, Liz Kaufenberg, Nancy Klebba, John Sullivan
MEMBERS ABSENT	: Alex Schwartz, Shawn Holmes
STAFF PRESENT	: Marty Asleson, Sayard Schultz

I. CALL TO ORDER AND ROLL CALL:

Mr. Heiskary called the Lino Lakes Environmental Board meeting to order at 6:32 p.m. on November 28, 2018.

II. APPROVAL OF AGENDA

Mr. Heiskary made a MOTION to approve the Agenda with the added discussion items. Ms. Andrzejewski seconded the motion.

III. APPROVAL OF MINUTES:

Mr. Sullivan made a MOTION to approve the September 26, 2018 Meeting Minutes Ms. Klebba supported motion. Motion carried 5-0.

IV. OPEN MIKE

Mr. Heiskary declared Open Mike at 6:34p.m.
Open Mike closed at 6:35p.m.

V. ACTION ITEMS

A. No Action Items

VI. DISCUSSION ITEMS

A. Rice Creek Watershed, Matt Kocian, Carp Study/Management in the Rice Creek Watershed District

- I. Matt Kocian presented a PowerPoint on the status of the Common Carp in the Rice Creek Watershed District.
- II. Common Carp - an invasive species that has lived in Minnesota for approximately 400 years.
- III. These carp are considered eco-engineers because they uproot aquatic vegetation. This action releases Nitrogen and Phosphorus (N&P) in the atmosphere. In addition, a high-density carp population impacts water quality. The threshold for population density is 100lbs / 1 acre.
 - A need for the study: 35,000 carp were taken out of Long Lake by a professional angler. This very high number of carp highlights the gravity of the carp density problem.

IV. The Carp Study

- The area of the carp study consisted of two separate water systems. Long lake system and the Lino Chain of Lakes system. These two areas are connected by the Rice Creek.
- This study sought to answer (4) questions about carp management:
 - 1) Methods to measure carp in the systems
 - Electro-fishing
 - Netting
 - 2) Carp Migration
 - They researched daily and seasonal migration via radio receivers.
 - Findings:
 - Carp aggregate in the winter into large groups then break apart into smaller groups and travel to deeper water with more oxygen. These deeper areas are considered their winter home.
 - In the summer time, Carp move out of winter homes and spread out among the lakes.
 - This type of migration patterns are called *Partial Migration*
 - Carp spawn in the Chain of Lakes system. This area is considered a Carp Nursery in the summer.
 - 3) How often do juvenile carp recruit
 - Recruitment in fisheries refers to the point of time that juvenile fish join the adult population.

- The study used Passive Integrated Transponder (PIT tags) to determine this time. PIT tags help scientists track individual organisms by providing a reliable lifetime 'barcode' for an individual animal.

4) How should we manage the carp:

- Standard for determining good management: effective, efficient, and reliable.
- Use population modeling to predict what type of management solutions.
- Management Solutions:
 - The removal of 50% of adult carp population (*not reliable*)
 - Suppression of juvenile carp (*not effective or efficient*)
 - Baited boxes and netting (using corn). This was used to remove adult carp. (*Effective & reliable; somewhat efficient*).
 - Low-Voltage Barrier/Guidance System:
 - Removes carp and suppresses recruitment.
 - New system PROCOM NEPTUN
 - This system is mobile, also cheap to employ
 - System repels or guides carp. Debris in water is also able to pass through the electrodes system.
 - Applying the management standards to this system:
 - ✓ Effective- Yes
 - ✓ Efficient- Yes
 - ✓ Reliable- so far it has been reliable. The true test will be if the system can remove 50% of adult carp per year and suppress 50% of juveniles per year.

V. Question from the Board and Environmental Coordinator on Study:

- Marty Asleson: How will the Low-Voltage Barrier/Guidance System affect canoeist and the ability for them to portage to different lakes?
Answer: The interaction between a canoeist and the system is more likely to result in the system's materials being damage and not the injury of the individual.
- Marty Asleson: Do you run the system barriers 24/7?
Answer: No, the system is only on a few months out of the year. There are also signs posted informing the public if the system is on or off.
- Marty Asleson: Is TDL factored into your management plan?
Answer: Yes
- John Sullivan: What is the quality of the water flowing into the north side of Peltier Lake?
Answer: No good. There needs to be improve quality of the two tributaries that flow into Peltier.

B. 2018 Goals Review/Discuss Goals for 2019

- Mr. Heiskary: Suggest that the Environmental Board members be more visible to the public. Such as more community events.
- Mr. Asleson: Work with the Met Council
- Schedule site visits to wetland bank easements and invite the residents to share their thoughts and learn more about these easements. Environmental Board members could send out flyers announcing these upcoming gatherings.
- Circulate more educational material for frequently throughout the year.
- Look at pass meeting notes for information pertaining to goals. Use this information to develop future goals.
 - i. Or keep a running Goal Journal throughout the year where ideas can be readily pulled from to create the upcoming year's set goals.

C. Recycling Updates on Waste Abatement Goal

- The first half of the year (January - June), Lino Lakes diverted **1,046 tons** of recyclables and organic material from the landfill.
- We are currently in the 2nd half of the year (July - December), the City has diverted **1,843 tons** of recyclables and organic material from the landfill.
- **Current Outlook:** *All tonnage data has been not submitted to the City by the various vendors*
 - **Counting Yardwaste towards overall diversion goal: $1,046 + 797 = 1,843$ tons**
 - **315 tons** short of goal
 - **Without Yardwaste tonnage counted towards goal: $1,046 + 547 = 1,593$ tons**
 - **565 tons** short of goal
 - Tonnage not yet captured during this 2nd half of the year (yardwaste included) is projected to be approximately **320 tons**.
 - With this projected additional tonnage, Lino Lakes could exceed its goal by 5 tons.

VII. ADJOURNMENT

Mr. Sullivan made a MOTION to adjourn the meeting at 8:24 p.m.
Ms. Andrzejewski supported motion. Motion carried 5-0

Respectfully submitted,
Sayard Schultz
City Recycling Intern

**ENVIRONMENTAL BOARD
AGENDA ITEM 5A**

STAFF ORIGINATOR: Marty Asleson, Environmental Coordinator

MEETING DATE: February 6, 2019

REQUEST: Preliminary Plat/Lyngblomsten/Senior Living Community/PUD/ Mixed Use/ Preliminary Plat Review

APPLICANT: Lyngblomsten
1415 Almond Avenue
St Paul MN 55108

OWNER: R.L.Co., LLC
7241 Ohms Lane, Suite 275
Edina, Minnesota 55439

PROJECT TIMELINE: Entitlements 03/30/2019
Close on Land Acquisition 04/15/2019
Permit Application 09/01/2019
Construction Commencement 11/01/2019
Construction Completion 02/01/2021

PROPOSED DEVELOPMENT

The proposed project application is for preliminary plat review. Concept plans for Lyngblomsten was discussed at the February 28th, 2018, and June 21st, 2018 Environmental Board meetings. The property is zoned General Business.

This project proposal is located North and East of the corner of Hodgson Road and County Road J. The corner is 2+ acres of vacant land with two older structures to the north that house an insurance business and a liquor store. Immediately north of those buildings is a 17.18 acre site that is mostly wooded with an old single family house located on the property.

Property on the East side of Hodgson road consists mostly of parking lots and used automobile sale lots. There is a landscape business to the north of the used car lots.

Lyngblomsten proposes to purchase the 17.18 acres on the northwest quadrant of the property owned by R.L. CO., LLC located at 6075 Hodgson Road., along with the insurance and liquor store buildings for the purpose of developing a senior living community and facilitating the development of a stand-alone restaurant. The plan is to create a “continuum-of-care” campus offering up to a total of 198 units comprised of a mix of independent living, assisted living, and memory care/enhanced care suiters/skill nursing care plus complementary campus amenities and 20 stand-alone senior living townhomes.

Land/Environmental issues have not changed. The building configurations and locations have changed, or have been defined better per this application

At this time the application proposes to build townhomes to the north and west of the main building. According to narrative provided by the developer, these town homes are setback from the adjacent single family homes and existing wetlands and will preserve a significant amount of the sites mature trees, and minimize wetland impact.

SITE EVALUATION

Surface Water and Wetlands

Water runs to a constructed pond. The Watershed’s requirement is that the proposed rates of runoff cannot exceed 80% of the existing runoff rates, and the site must provide water quality treatment for 1.1 inches of runoff from the new and reconstructed impervious areas. City Engineers must verify the requirements.

The soils in this pond do not infiltrate, at least at a higher rate. Silt formation in the soils slow it down enough to not classify it as infiltration pond. Water leaving the pond goes to a pipe going across private property easement. The pipes need to be joined at the intersection. The Watershed’s requirement is that the proposed rates of runoff cannot exceed 80% of the existing runoff rates, and the site must provide water quality treatment for 1.1 inches of runoff from the new and reconstructed impervious areas. It appears that the developer is proposing to use stormwater for irrigation purposes as part of the volume mitigation.

A wetland exists on the northwest side of the project. This wetland is not in a wetland corridor, therefore a 50 foot buffer is not needed; however the city is asking for a 25 foot buffer around this wetland. City standard wetland buffer signs must be placed on the perimeter of this buffer.

The banks and perimeter of the pond is proposed to be seeded with a prairie pond mix. The mix is a high growth plant mix. Recommend a lower growth planting with enhancement forbes.

The pond would need a maintenance agreement signed. We would also require a plan for the establishment and management of the native prairie for a 5 year period, and managed by a company that is knowledgeable in the establishment and maintenance of native prairie. Usually a plan requires a fire at the end of 3-5 years. There are alternatives to this that do not work as well. If fire is in the plan than trees in the pond should be able to tolerate fire. For the most part this is Oaks.

Some other species of tree should be substituted for the proposed Aspen in the pond. They will also not survive fire, but will eventually take over the entire pond by root regeneration of new trees. That becomes a pond maintenance issue 10 years down the road and will also shade out the shade intolerant native prairie plants.

Soils

Sandy site soils that are layered with silt formations are present on the site.

Land Cover

The land was previously disturbed, non-native grasses with naturally seeded trees, some of them native, some not. There is wetland on the NW side of the project. There are no significant native plants in this wetland.

Tree Preservation

Basic use area trees will be removed as per code standard. Trees and shrubs on the western edge will be left in place and protected from construction. Screening is necessary on the western property line and Northern property line. A tree inventory was completed. Trees to be saved must have a tree preservation plan completed. The plan must show what trees and orange barrier fence around the tree dripline perimeters.

Significant Resources

There are no signature features on this site that would indicate rare plants or animals. There are no NHIS data for this site. It is possible Blanding's Turtle travel through this area, so for Blanding's turtle or any other turtles it is recommended that surmountable curb design be used.

Flood Plain

There is no floodplain on the site.

Stormwater Pollution Prevention Plan

The project will need to have an NPDES/Construction Stormwater permit, and full SWPPP submitted. The applicant must provide the name and the certification of their Construction Stormwater permit inspector, as well as the phone number of the inspector or a means of contact.

The project is within a one mile radius of Baldwin Lake and they have identified this in their plan. The project has plan to monitor discharge water quality, and remediate any issues that for turbid waters. The plan shows required rock construction entrances. The plan identifies perimeter control and catch basin protection. Cover to meet NPDES requirements include the use of temporary seeding, sediment control blankets, stormwater treatment basins, temporary sediment basins, rock dams and rip rap use and sediment logs. The permit holder of the Construction Stormwater Permit, must submit the required weekly site inspection report to the city immediately after each inspection. All corrective action documentation must be emailed to the City upon completion.

Although the developer discusses Concrete washout in the SWPPP, the developer must identify a concrete washout area on the plan.

Wellhead protection and Drinking water Service Management Area

The site is not in a Drinking Water Service Management Area.

Landscape Plan

Boulevard trees are required and escrow money must be obtained for these trees.

A buffer and screening plan should would need to be submitted for the NE corner area, and between the individual townhomes and the property. The NE area has a storm pipe designed under the surface on the property line, so this area should have a fence at least as far as the pipe is installed to the west. The remaining lots could also be fence or landscape materials. The west side of the project has a 50-foot buffer that will be tree-protected, and plantings in the pond to afford screening.

There are two irrigation plans. One excludes the native areas (L1), and the other includes it in CO.04. The developer intends to irrigate with stormwater so reuse of stormwater in the native areas would be ok. Natives need supplemental irrigation to get started, but don't need it after, and if fluorinated water is applied to established native plantings the plants are stressed and replaced with non-native plants. Therefore, the use of stormwater should be inconsequential to the plants after establishment. This is also a great BMP, and way to control volume loss on the site.

There is a wide diversity of plant materials proposed for this site. A few of them are marginally hardy (like boxwood), but it will be interesting to see how they go through a winter here. The plants are under guarantee for a year. Plants on the County road right of way need to be moved back. There are some trees located on the road entry off of Hodgson Road that are located on County Road ROW. In addition, for siting purposes, the City requires that trees and shrubs be located at least 30 feet from a corner.

As stated in the pond discussion, aspen trees must be substituted out to some other species that will not spread through root growth, and perhaps tolerate fire.

A recommendation from the June 21st Environmental Board meeting stated that “Since this is an assisted living and memory care facility area, the use of trails and flower garden plantings should be planned for this development. A small handicap accessible community garden area would also be desirable in this area for programming open space landscaping. Raised garden beds are accessible to disabled residents and would also be a desirable element to consider”. The developers have considered this and positioned a community garden in the NW corner of the project.

All trees planted on the Eastern site boundary must be in compliance with the pole energy company’s policy for tree clearance distances at tree mature heights.

All shrub and Sod areas are irrigated. Tall Prairie is scheduled in for the pond, wetland restoration and surrounding area of the community garden. The existing wetland vegetation is non-native vegetation with invasive Garlic Mustard.

Lighting

Lighting appears to conform to the no property line spill rule, and fixtures are of the low-profile, downward focused cut-off type lens.


RECOMMENDATION

Approve staff and Environmental Board recommendations. Forward on to Planning and Zoning Board and City Council.

ATTACHMENTS

1. Lyngblomsten Location Map
2. Overall Site Plan
3. Site Plan North
4. Site Plan South
5. Site Plan-Arch Plan Set
6. Grading and Drainage
7. Erosion
8. NE Green Planting Plan

9. Tree Preservation
10. Landscape Site Layout Plan
11. Proposed Irrigation
12. Irrigated Areas
13. Boulevard Tree Planting
14. Main Building N Planting
15. Main Building South Planting
16. TC and MC Planting Plans
17. SN Planting Plan
18. Clubhouse Planting Plan
19. SW Green Planting Plan
20. East Townhomes Planting Plan
21. West Townhome Planting Plan
22. Photometric/Light Fixtures
23. Wetland Buffer

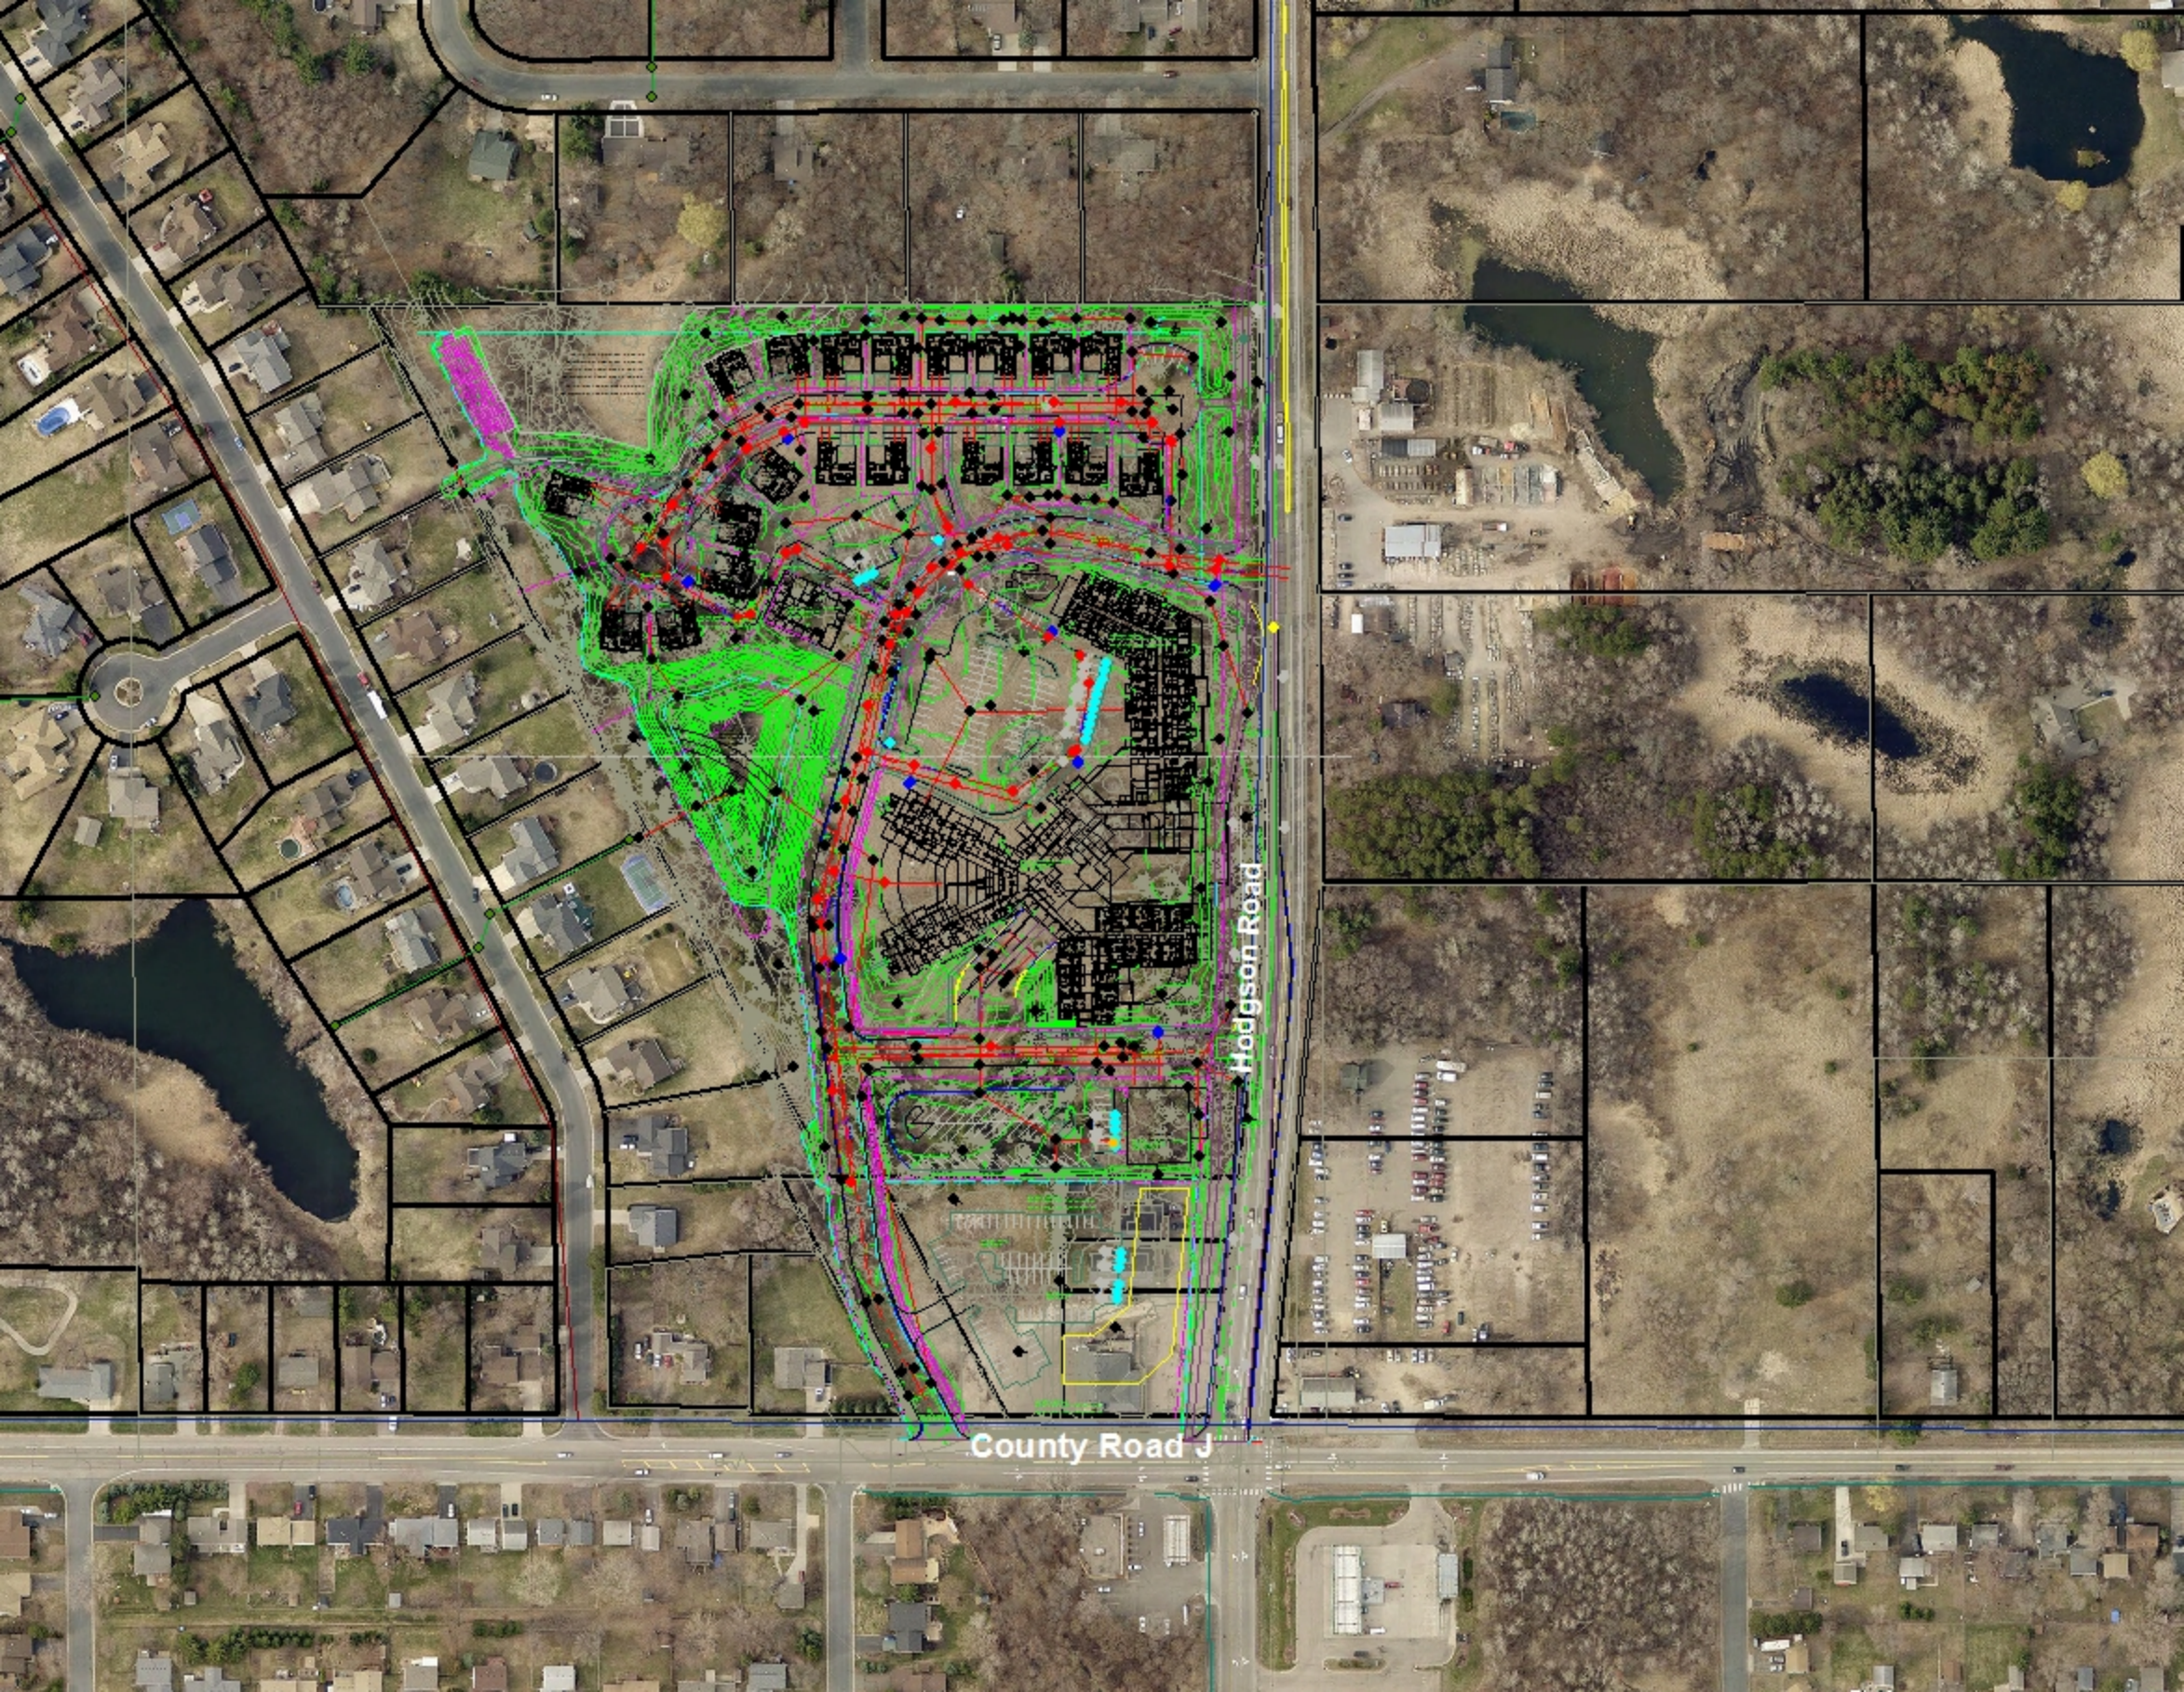

County Road J


Hodgson Road

**LYNGBLOMSTEN
SENIOR
COMMUNITIES**

HODGSON ROAD
LINO LAKES, MN 55014

LYNGBLOMSTEN


1415 ALMOND AVE W
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ASSOCIATES, INC. **AJA**
LANDSCAPE ARCHITECTURE • SITE PLANNING • CIVIL ENGINEERING
700 GRAND AVENUE NORTH SUITE 200 MINNEAPOLIS, MN 55425
PH: (763) 427-7500

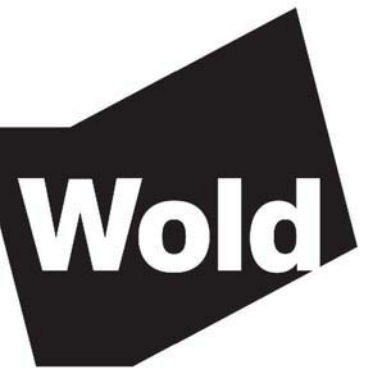

WETLAND 1
EXISTING 2YR HWL = 899.65
PROPOSED 2YR HWL = 899.67
EXISTING 10YR HWL = 900.13
PROPOSED 10YR HWL = 900.09
EXISTING 100YR HWL = 900.52
PROPOSED 100YR HWL = 900.35

NORTHEAST PARKING
6 TOTAL STALLS
ACCESSIBLE STALLS REQUIRED = 1
ACCESSIBLE STALLS PROVIDED = 0

NORTHWEST PARKING
5 TOTAL STALLS
ACCESSIBLE STALLS REQUIRED = 1
ACCESSIBLE STALLS PROVIDED = 0

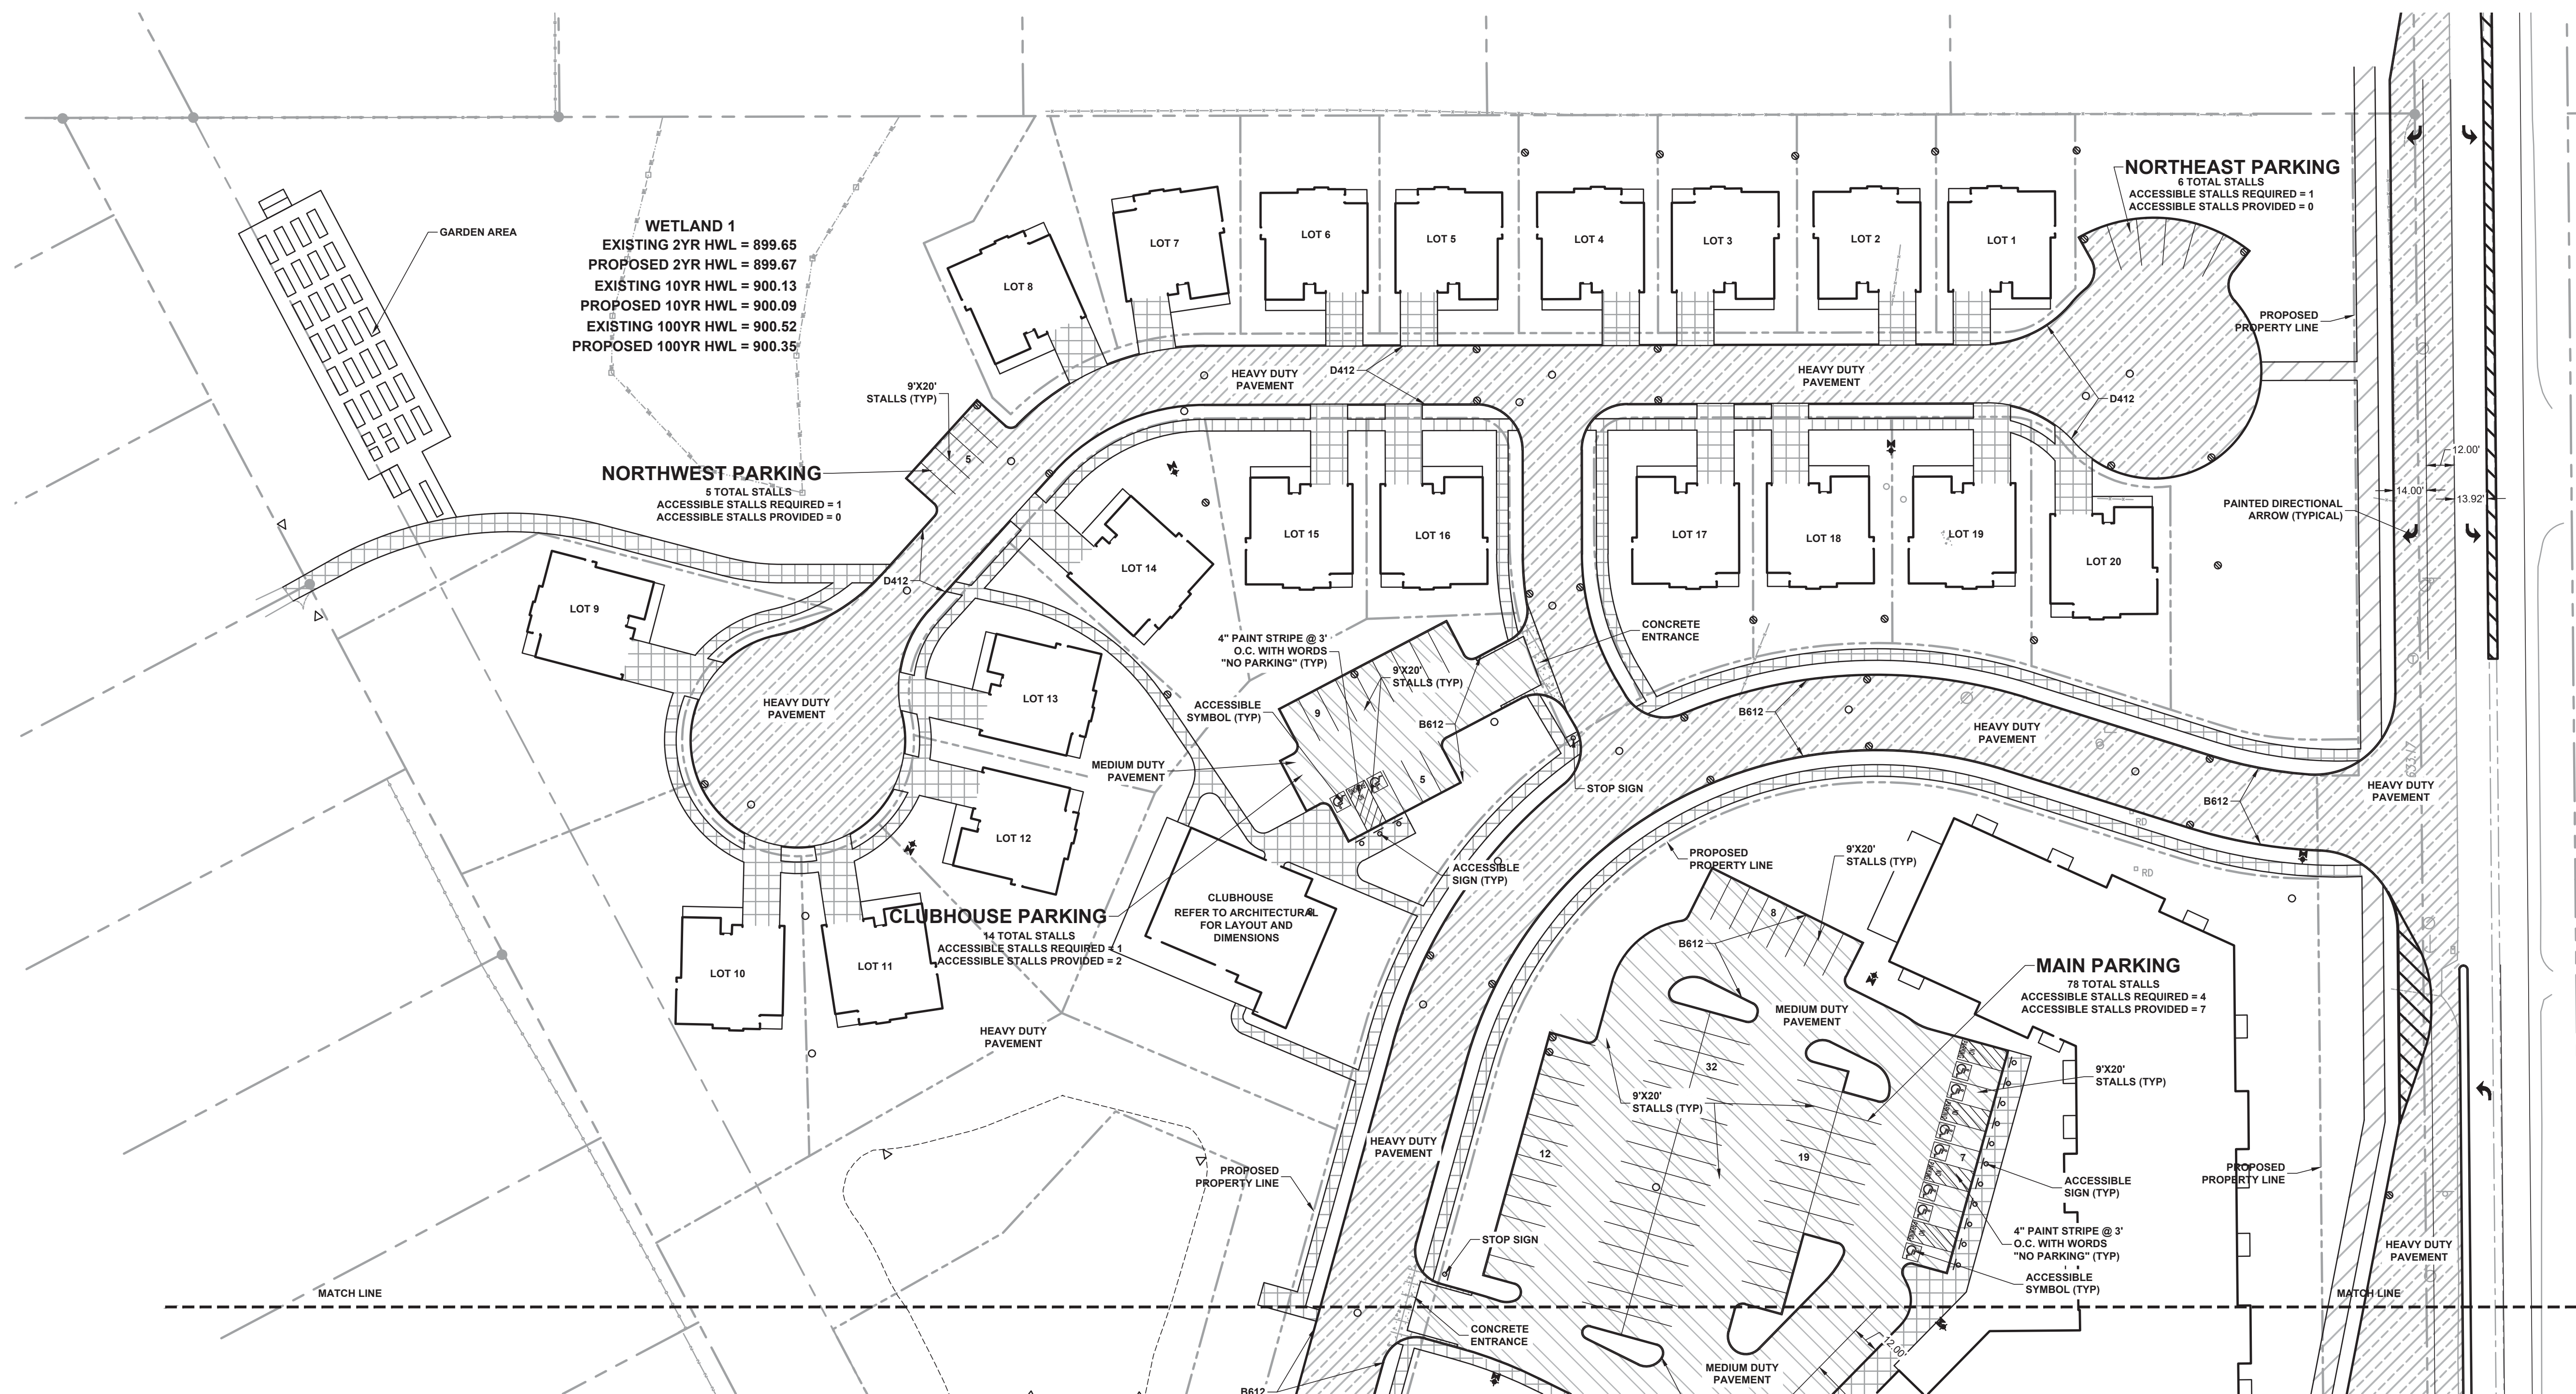CLUBHOUSE PARKING
14 TOTAL STALLS
ACCESSIBLE STALLS REQUIRED = 1
ACCESSIBLE STALLS PROVIDED = 2

MAIN PARKING
78 TOTAL STALLS
ACCESSIBLE STALLS REQUIRED = 4
ACCESSIBLE STALLS PROVIDED = 7

LEGEND

- 1 REFERENCE KEY TO SITE DETAILS
DETAIL I.D NUMBER (TOP)
DETAIL SHEET NUMBER (BOTTOM)
- PROPOSED CONCRETE WALK
- PROPOSED CONCRETE SLAB
- PROPOSED LIGHT DUTY BITUMINOUS PAVEMENT
- PROPOSED MEDIUM DUTY BITUMINOUS PAVEMENT
- PROPOSED HEAVY DUTY BITUMINOUS PAVEMENT
- PROPOSED TRAFFIC CONTROL SIGN
- SIGNAGE KEY NOTE
- PROPOSED BOLLARD
- PAINTED ACCESSIBLE SYMBOL
- PROPOSED MANHOLE (MH)
- PROPOSED CATCH BASIN (CB)
- PROPOSED FLARED END SECTION (FES)
- PROPOSED HYDRANT (HYD)
- PROPOSED GATE VALVE (GV)
- PROPOSED POST INDICATOR VALVE (PIV)
- PROPOSED FLAGPOLE - REFER TO ARCHITECTURAL PLANS
- PROPOSED BUILDING STOOP - REFER TO ARCHITECTURAL PLANS
- PROPOSED LIGHT POLE - REFER TO ELECTRICAL PLANS
- PROPERTY LINE

NOTES:

1. REFER TO SHEET C1.31, GRADING AND DRAINAGE PLAN NORTH, FOR GENERAL NOTES.
2. CHECK ALL PLAN AND DETAIL DIMENSIONS AND VERIFY SAME BEFORE FIELD LAYOUT.
3. SIGNAGE SHALL GENERALLY BE INSTALLED 18" BEHIND THE BACK OF CURB.
4. ALL DISTURBED AREAS OUTSIDE THE BUILDING PAD WHICH ARE NOT DESIGNATED TO BE PAVED SHALL RECEIVE AT LEAST 6" OF TOPSOIL AND SHALL BE SODDED OR SEEDED.
5. WHERE NEW SOD MEETS EXISTING TURF, EXISTING TURF EDGE SHALL BE CUT TO ALLOW FOR A CONSISTENT, UNIFORM STRAIGHT EDGE. JAGGED OR UNEVEN EDGES WILL NOT BE ACCEPTABLE. REMOVE TOPSOIL AT JOINT BETWEEN EXISTING AND NEW AS REQUIRED TO ALLOW NEW SOD SURFACE TO BE FLUSH WITH EXISTING.
6. FAILURE OF TURF DEVELOPMENT: IN THE EVENT THE CONTRACTOR FAILS TO PROVIDE AN ACCEPTABLE TURF, THE CONTRACTOR SHALL RE-SOD OR RE-SEED ALL APPLICABLE AREAS, AT NO ADDITIONAL COST TO THE OWNER, TO THE SATISFACTION OF THE ENGINEER.

SITE STATISTICS:

- NORTHEAST PARKING**
TOTAL STALLS = 6
ACCESSIBLE STALLS REQUIRED = 1
ACCESSIBLE STALLS PROVIDED = 0
- NORTHWEST PARKING**
TOTAL STALLS = 5
ACCESSIBLE STALLS REQUIRED = 1
ACCESSIBLE STALLS PROVIDED = 0
- CLUBHOUSE PARKING**
TOTAL STALLS = 14
ACCESSIBLE STALLS REQUIRED = 1
ACCESSIBLE STALLS PROVIDED = 2
- RESTAURANT PARKING**
TOTAL STALLS = 47
ACCESSIBLE STALLS REQUIRED = 2
ACCESSIBLE STALLS PROVIDED = 3
- SOUTH PARKING**
TOTAL STALLS = 76
ACCESSIBLE STALLS REQUIRED = 4
ACCESSIBLE STALLS PROVIDED = 4
- MAIN PARKING**
TOTAL STALLS = 78
ACCESSIBLE STALLS REQUIRED = 4
ACCESSIBLE STALLS PROVIDED = 7

SIGNAGE KEY NOTES

- (A) STOP MmMUTCD R1-1 (30"x30")
- (B) DO NOT ENTER MmMUTCD R5-1 (30"x30")
- (C) ERROR PARKING SIMILAR TO MmMUTCD R7-5 (12"x18")

I hereby certify that this plan, specification or report was prepared by me or under my direct supervision and that I am a duly Licensed PROFESSIONAL ENGINEER under the laws of the State of MINNESOTA


DAVID A. REY
Registration Number 40180 Date C1.21

Description	Revisions	
	Date	Num

Comm: XXX
Date: XXXX
Drawn: BJD
Check: DAR

SITE PLAN NORTH

Scale: 1" = 40'
C1.21

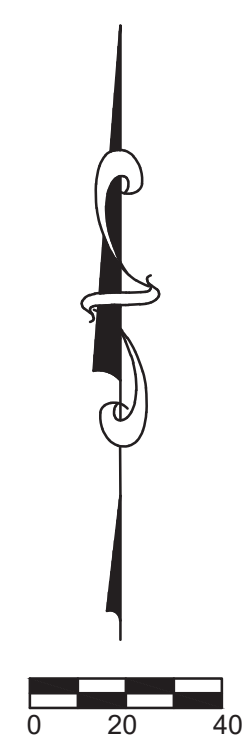


**LYNGBLOMSTEN
SENIOR
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HODGSON ROAD
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LYNGBLOMSTEN

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ST. PAUL, MN 55108




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MN

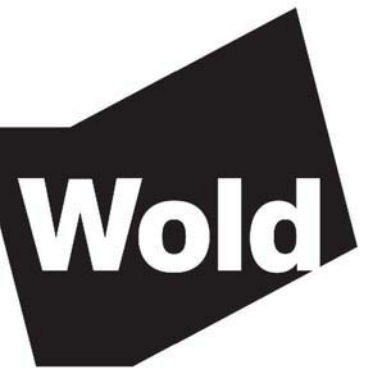

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LEGEND

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- PROPOSED BUILDING STOOP - REFER TO ARCHITECTURAL PLANS
- PROPOSED LIGHT POLE - REFER TO ELECTRICAL PLANS
- PROPERTY LINE

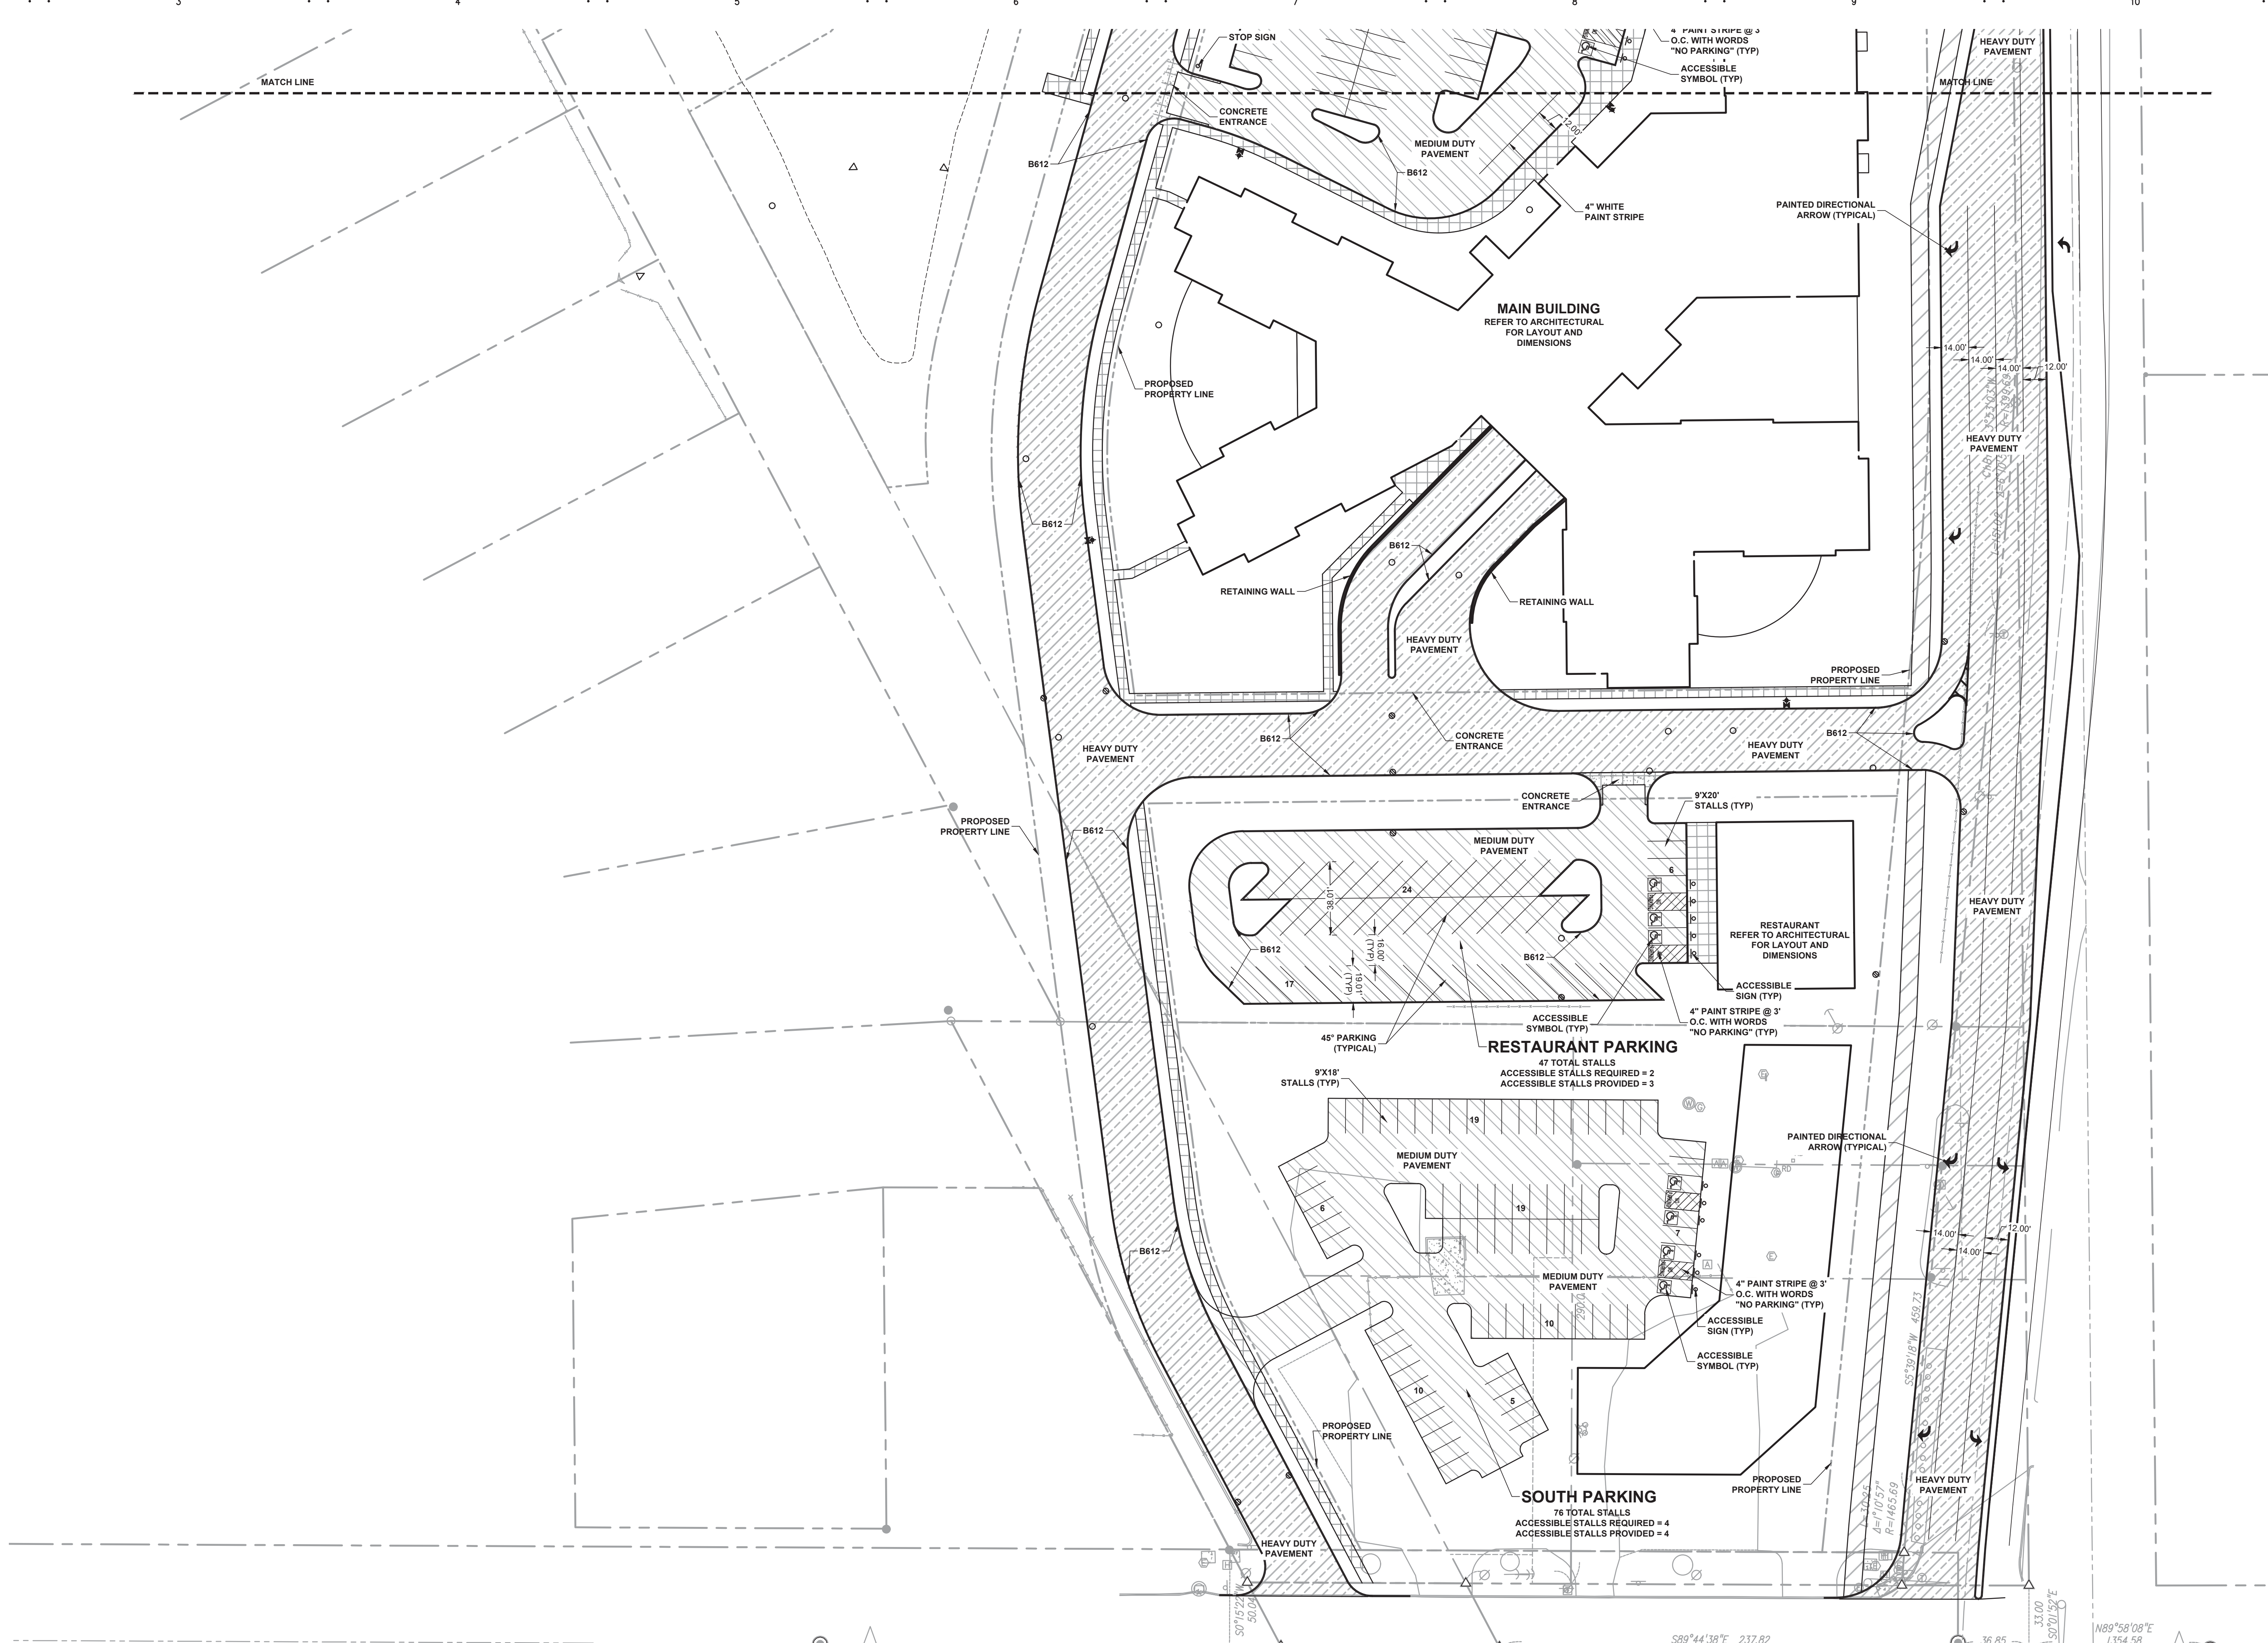NOTES:

1. REFER TO SHEET C1.21, SITE PLAN NORTH, FOR NOTES.
2. REFER TO SHEET C1.31, GRADING AND DRAINAGE PLAN NORTH, FOR GENERAL NOTES.

SIGNAGE KEY NOTES


- STOP** MmMUTCD R1-1
(30"x30")
- DO NOT ENTER** MmMUTCD R5-1
(30"x30")
- VERTICAL PARKING** SIMILAR TO MmMUTCD R7-5
(12"x18")

I hereby certify that this plan, specification or report was prepared by me or under my direct supervision and that I am a duly Licensed PROFESSIONAL ENGINEER under the laws of the State of MINNESOTA

DAVID A. REY
Registration Number 40180 Date XXXX

Description	Revisions	
	Date	Num


Comm: XXX
Date: XXXX
Drawn: BJD
Check: DAR

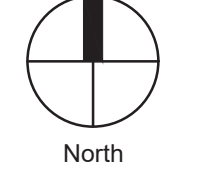

SITE PLAN SOUTH

Scale: 1" = 40'


C1.22

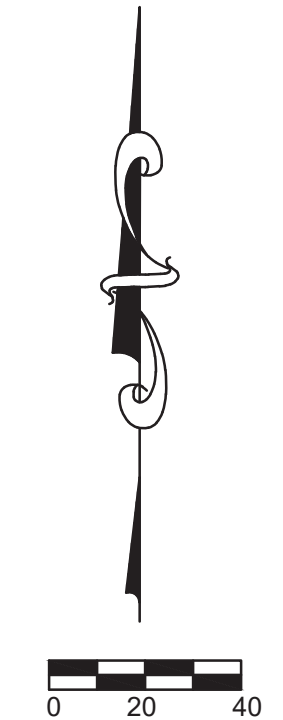

**LYNGBLOMSTEN
SENIOR
COMMUNITIES**

Hodgson Road,
Lino Lakes, MN 55014

Lyngblomsten
1415 Almond Ave W, St Paul, MN
55108

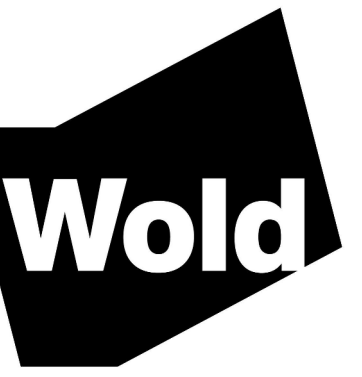

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Saint Paul, MN 55101

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UNIT COUNT

IL: 4-STORY
100 UNITS

AL: 3-STORY
50 UNITS

SNF: 2-STORY
48 UNITS

DETACHED TOWNHOMES:
20 UNITS


PARKING SUMMARY

UNDERGROUND: 102
CLUB HOUSE: 17
MAIN BUILDING: 83
RESTURANT: 47
TOWNHOME DRIVE: 40
ON STREET: 11

TOTAL: 300

Description	Revisions	
	Date	Num

Comm: 186024
Date: 01-14-2019
Drawn: G. Berens
Check: P. Schmelzer

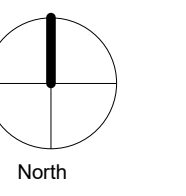

SITE PLAN


Scale: As indicated

A2



MN

A

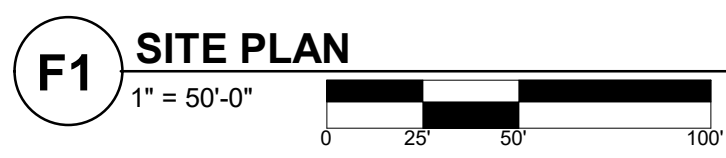

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 01/14/2019 10:00:00 AM
 G. Berens
 P. Schmelzer

MN

B

C

D


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NOTES

1. REFER TO SHEET C1.31, GRADING AND DRAINAGE PLAN NORTH, FOR GENERAL NOTES.

BENCHMARKS (FIELD VERIFY BEFORE USING)

BENCHMARK: MNDOT MONUMENT LOCATED AT THE SOUTHEAST QUADRANT OF SUNSET AVENUE OVER 35W
 Elevation = 929.283 (NGVD29)

SITE BENCHMARK: TOP NUT OF HYDRANT LOCATED AT THE SOUTHWEST QUADRANT OF ASH STREET AND HODGSON ROAD.
 Elevation = 906.81 (NGVD29)

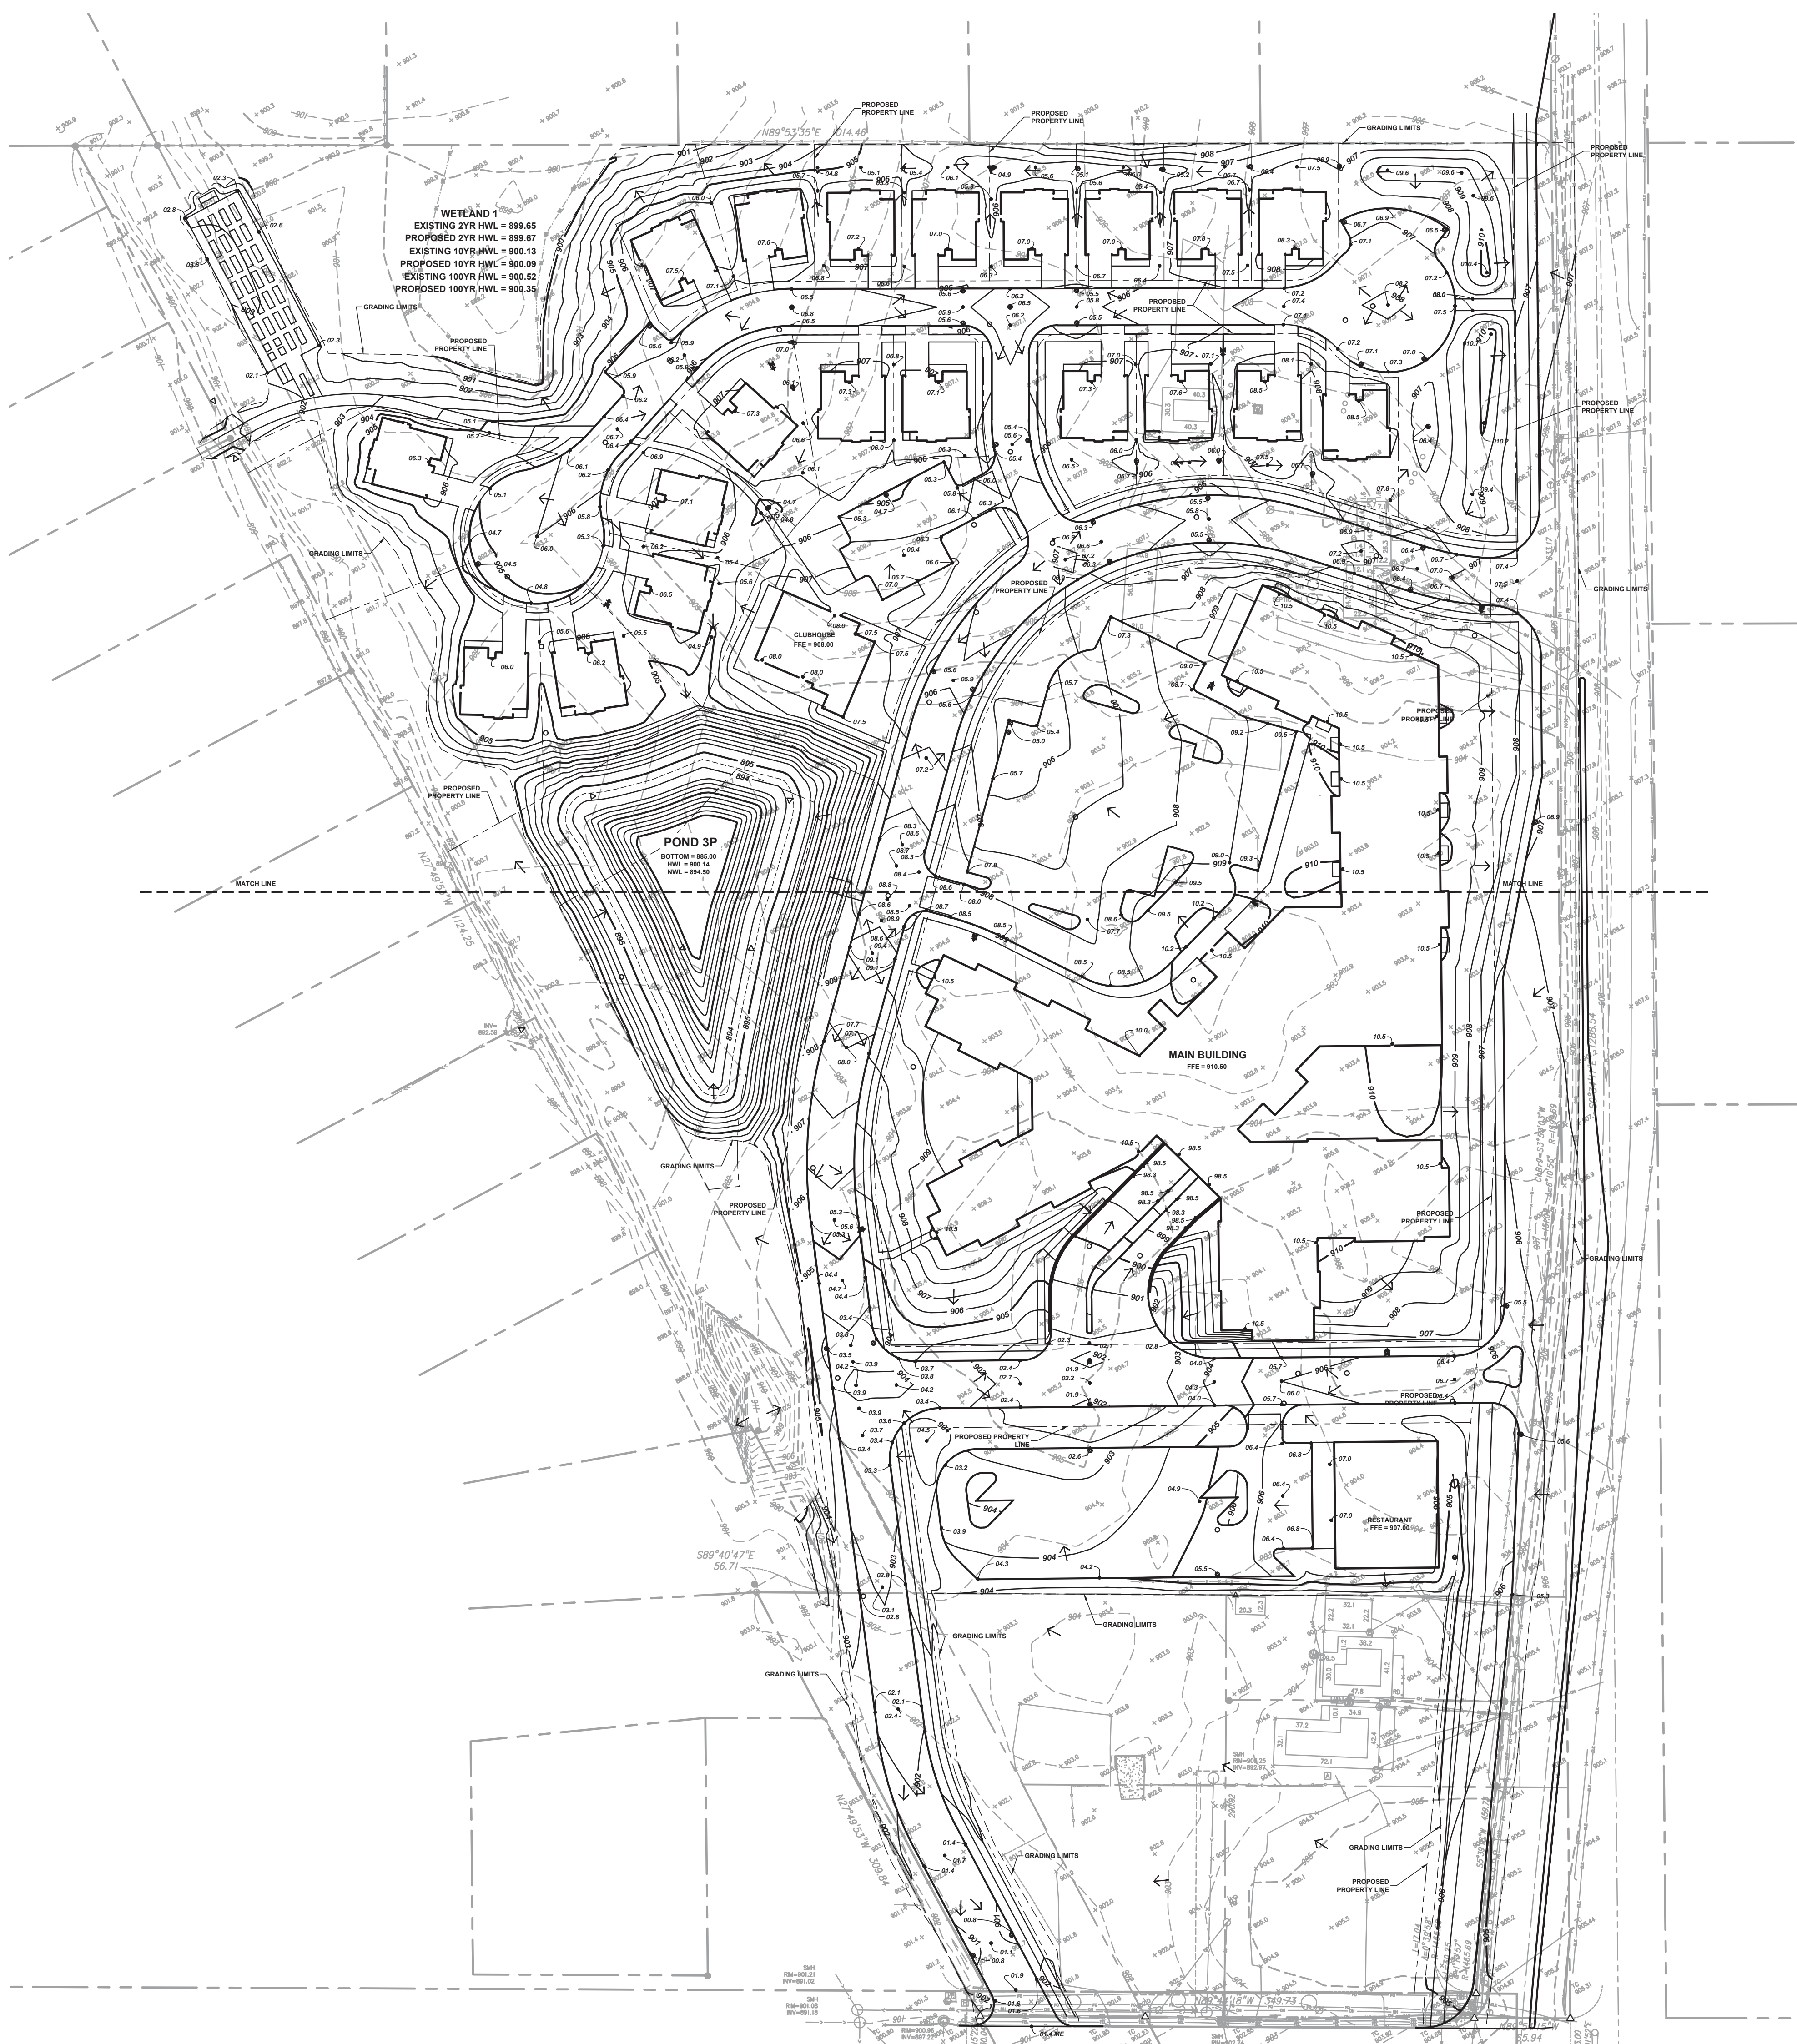SITE BENCHMARK: TOP NUT OF HYDRANT LOCATED AT THE SOUTHEAST QUADRANT OF ASH STREET AND HODGSON ROAD.
 Elevation = 903.48 (NGVD29)

SITE BENCHMARK: THRESHOLD ELEVATION ON EAST SIDE OF BUILDING LOCATED AT 6011 HODGSON ROAD.
 Elevation = 905.36 (NGVD29)

GEOTECHNICAL TABLE

REFER TO SPEC 31 00 00 EARTHWORK AND UNIT PRICES
 NOTE: DEPTHS LISTED IN TABLE BELOW DO NOT INCLUDE REMOVAL OF SUITABLE SOIL REQUIRED TO MEET PROPOSED GRADES.

Boring	Estimated Cut (FT)
G-6	9.50
G-7	7

LEGEND


- REFERENCE KEY TO SITE DETAILS
 DETAIL I.D NUMBER (TOP)
 DETAIL SHEET NUMBER (BOTTOM)
- EXISTING CONTOUR
- EXISTING SPOT ELEVATION
- PROPOSED CONTOUR
- PROPOSED SPOT ELEVATION
 ME = MATCH EXISTING
- PROPOSED GRADING LIMITS
- PROPOSED SAND SUBBASE AT FROST FOOTED STOOPS
- APPROXIMATE SOIL BORING LOCATION
- PROPOSED MANHOLE (MH)
- PROPOSED CATCH BASIN (CB)
- PROPOSED FLARED END SECTION (FES)
- PROPOSED HYDRANT (HYD)
- PROPOSED GATE VALVE (GV)
- PROPOSED POST INDICATOR VALVE (PIV)
- PROPOSED BUILDING STOOP - REFER TO ARCHITECTURAL PLANS
- PROPERTY LINE

LYNGBLOMSTEN SENIOR COMMUNITIES

HODGSON ROAD
 LINO LAKES, MN 55014

LYNGBLOMSTEN

1415 ALMOND AVE W
 ST. PAUL, MN 55108

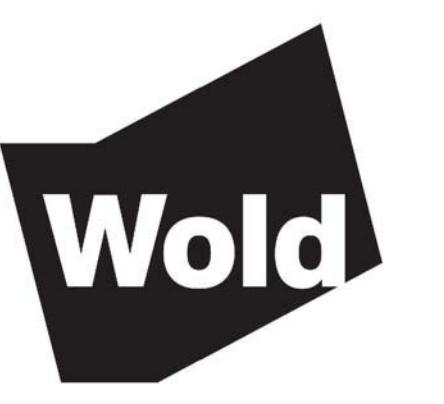

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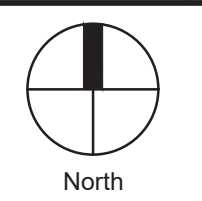
ANDERSON - JOHNSON ASSOCIATES, INC. **AJA**
 LANDSCAPE ARCHITECTURE • SITE PLANNING • CIVIL ENGINEERING
 775 HENRI AVENUE NORTH, SUITE 200 • MINNEAPOLIS, MN 55412
 PH: 763.427.2000

I hereby certify that this plan, specification or report was prepared by me or under my direct supervision and that I am a duly Licensed PROFESSIONAL ENGINEER under the laws of the State of MINNESOTA

DAVID A. REY
 Registration Number 40180 Date XXXX

Description	Revisions	
	Date	Num


Comm: XXX
 Date: XXXX
 Drawn: BJD
 Check: DAR



GRADING AND DRAINAGE PLAN OVERALL

Scale: 1" = 60'

C1.30

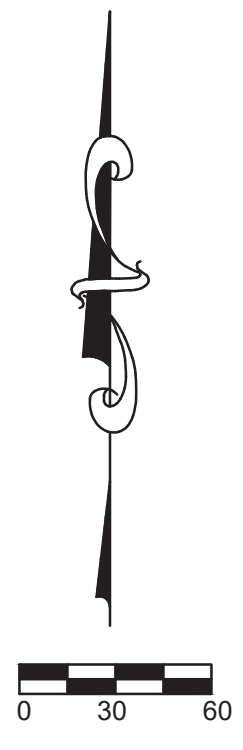


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NOTES


1. REFER TO SHEET C1.31, GRADING AND DRAINAGE PLAN NORTH, FOR GENERAL NOTES.
2. REFER TO SHEET C1.51, EROSION PREVENTION AND SEDIMENT CONTROL PLAN NORTH, FOR NOTES.

**APPROXIMATE EROSION CONTROL DEVICE
QUANTITIES**

SILT FENCE = 7091 L.F.
SEDIMENT CONTROL LOG = 141 L.F.
ROCK CONSTRUCTION ENTRANCE = 75 C.Y.
EROSION CONTROL BLANKET = 2242 S.Y.
SEDIMENT CONTROL DEVICE AT STORM SEWER INLET = 44

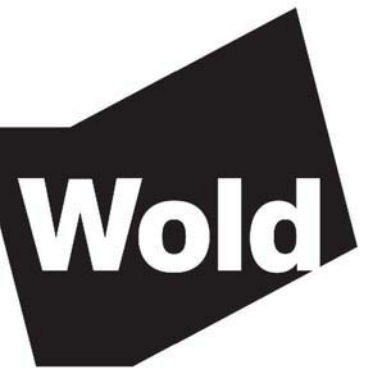LEGEND

- ① REFERENCE KEY TO SITE DETAILS
DETAIL ID NUMBER (TOP)
DETAIL SHEET NUMBER (BOTTOM)
- - - EXISTING CONTOUR
- - - PROPOSED CONTOUR
- 54.6 PROPOSED SPOT ELEVATION
ME = MATCH EXISTING
- - - PROPOSED GRADING LIMITS
- - - PROPOSED STORM SEWER
- PROPOSED MANHOLE (MH)
- ⊙ PROPOSED CATCH BASIN (CB)
- ◁ PROPOSED FLARED END SECTION (FES)
- - - PROPOSED SILT FENCE
- PROPOSED SEDIMENT CONTROL LOG
- ▨ PROPOSED ROCK CONSTRUCTION ENTRANCE
- ▨ PROPOSED EROSION CONTROL BLANKET
- ⊙ SEDIMENT CONTROL DEVICE AT STORM SEWER INLET
- ⊙ PROPOSED BUILDING STOOP - REFER TO ARCHITECTURAL PLANS
- - - PROPERTY LINE

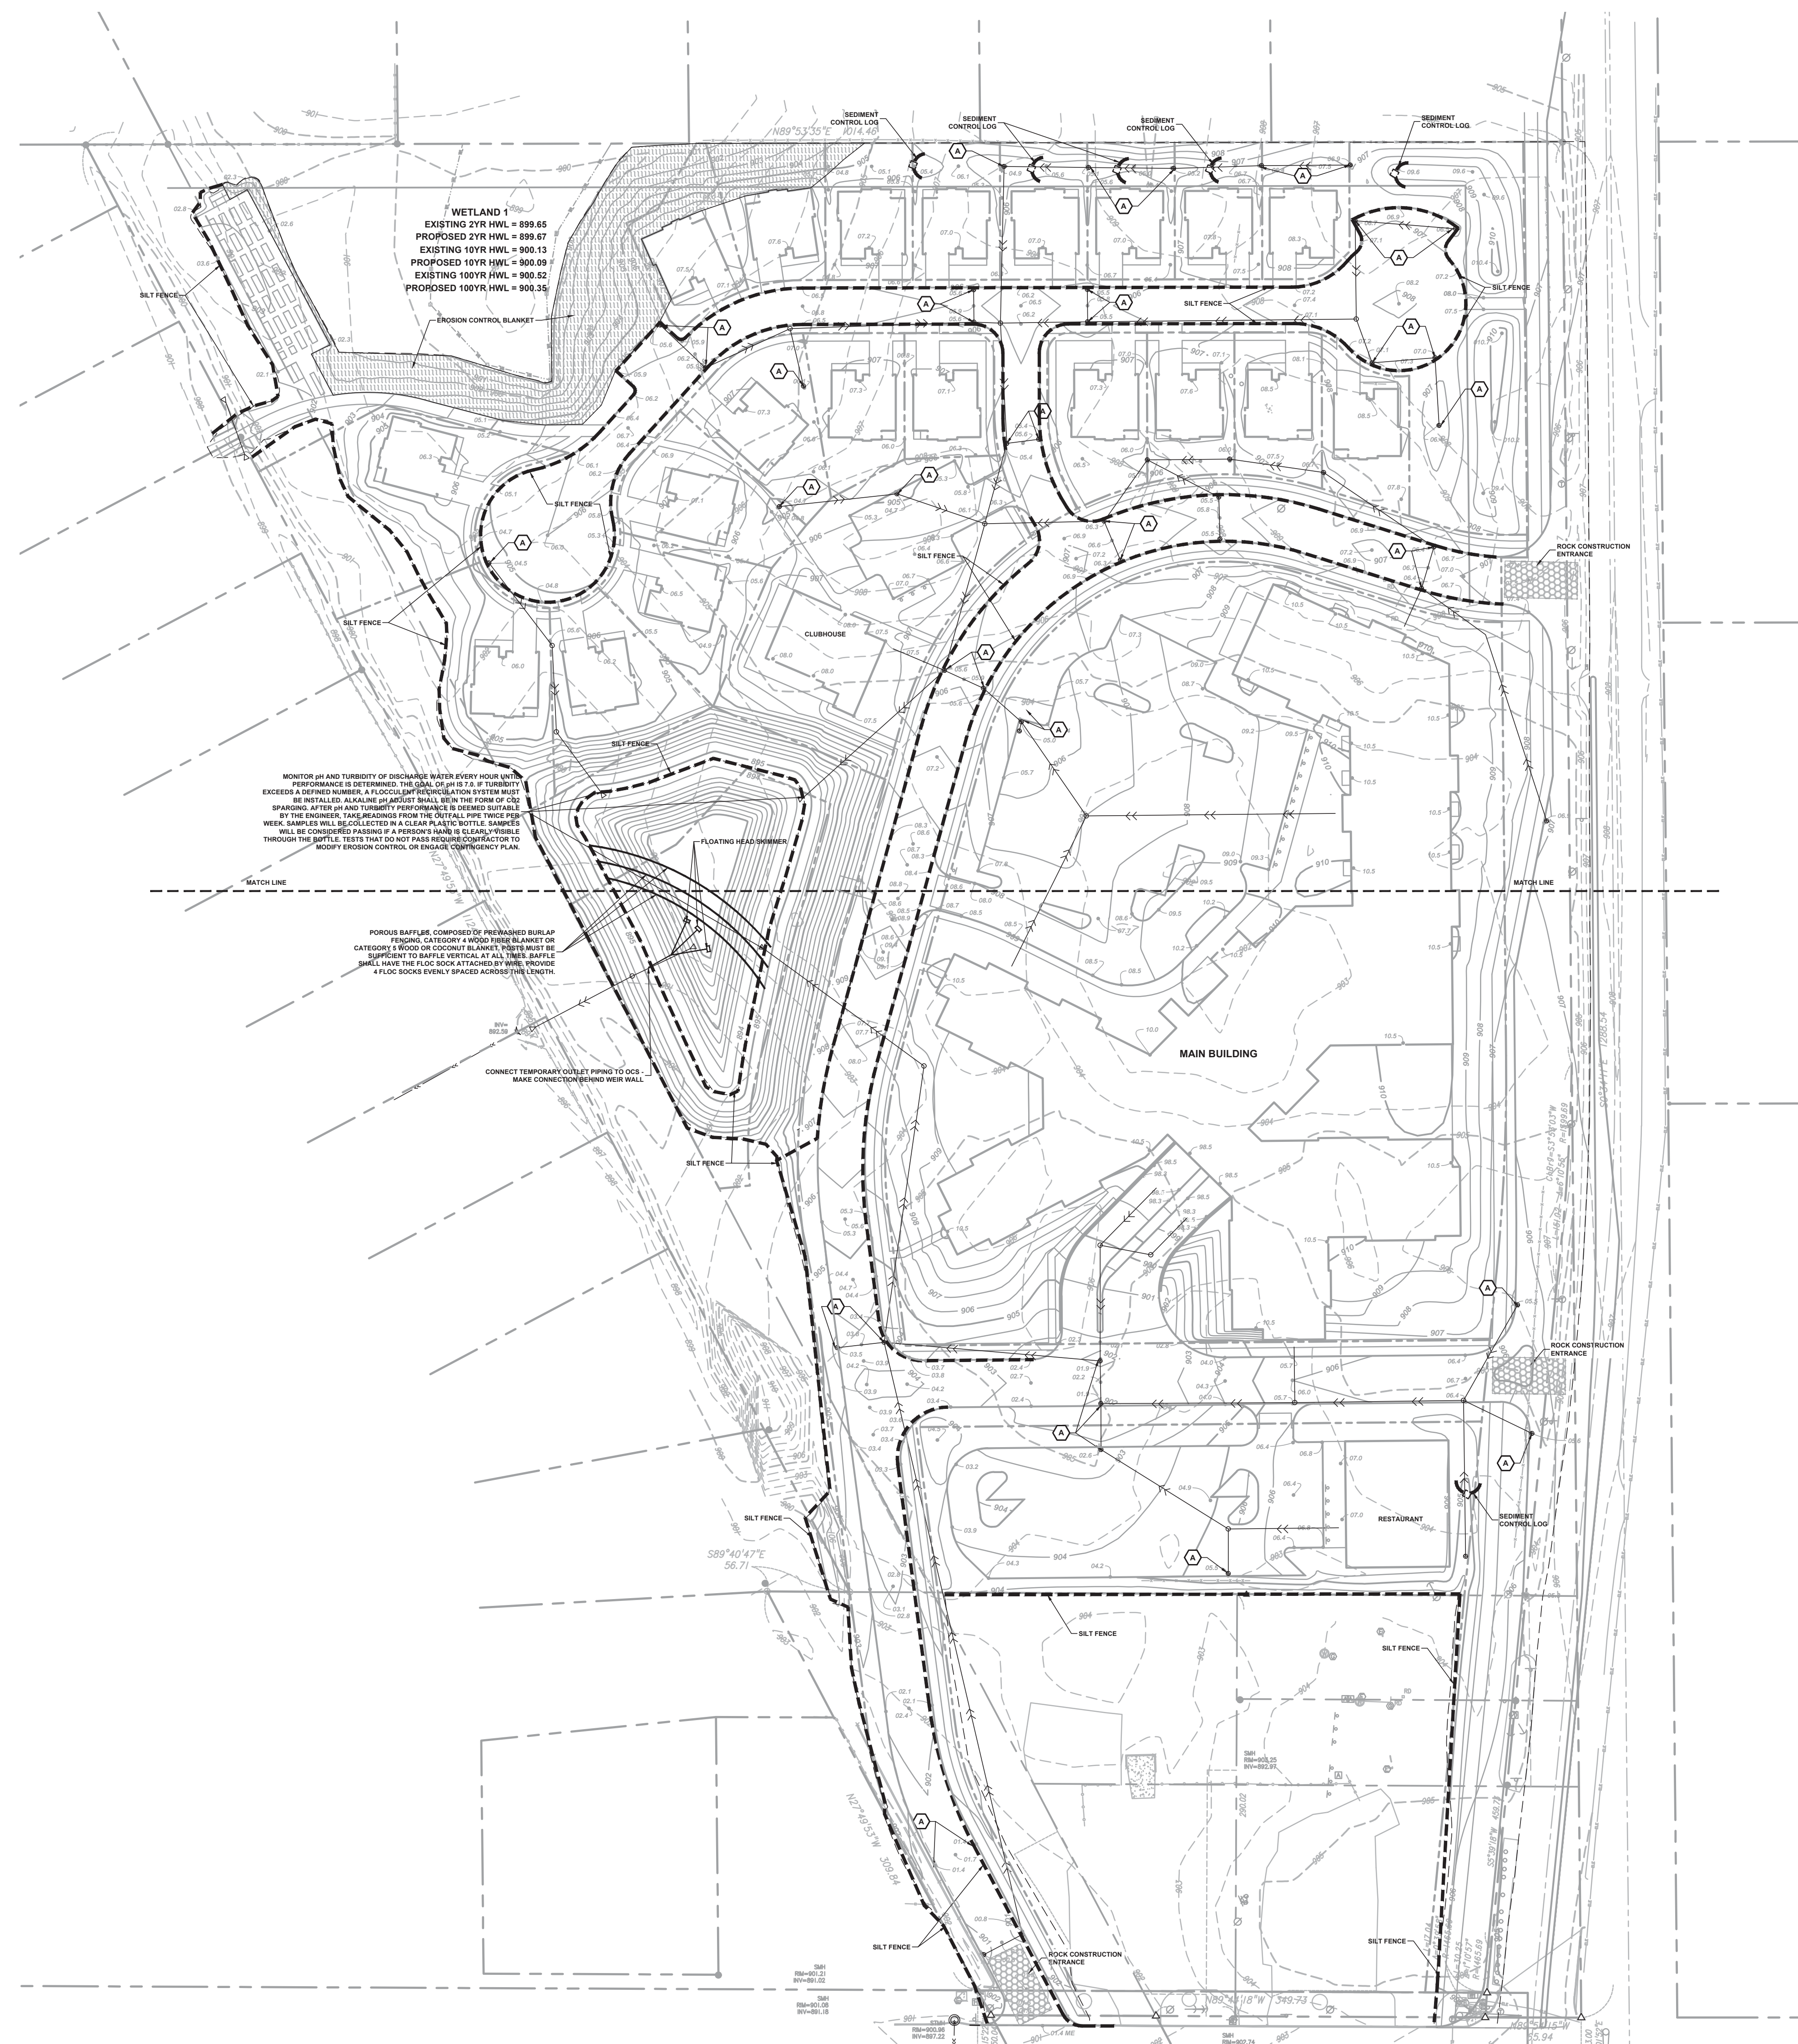

WETLAND 1
EXISTING 2YR HWL = 899.65
PROPOSED 2YR HWL = 899.67
EXISTING 10YR HWL = 900.13
PROPOSED 10YR HWL = 900.09
EXISTING 100YR HWL = 900.52
PROPOSED 100YR HWL = 900.36

MONITOR pH AND TURBIDITY OF DISCHARGE WATER EVERY HOUR UNTIL PERFORMANCE IS DETERMINED. THE USE OF 100 µm FILTERS IF TURBIDITY EXCEEDS A DEFINED NUMBER. A FLOCCULANT PRECIPITATION SYSTEM MUST BE INSTALLED. AVOIDANCE OF ACUTE BIRDS IN THE FORM OF COW SPREADING, AT FES AND TURBIDITY PERFORMANCE IS DETERMINED. BY THE ENGINEER. DETERMINATION FROM THE INITIAL AND FINAL TESTS. WATER WILL BE CONSIDERED PASSING IF A PERSON'S HAND IS CLEARLY VISIBLE THROUGH THE BOTTLE. TESTS THAT DO NOT PASS REQUIRE CORRECTIVE TO MOOPLY EROSION CONTROL OR ENHANCE CORRECTIVE PLAN.

POREOUS BATTLE-CONCRETE OR PRECASTED BUILT-UP CATEGORY 4 WOOD OR COCONUT BLANKET. PILES MUST BE SUFFICIENT TO BURY THE FLOOR JOIST ATTACHED BY WIRE. BATTLE MUST HAVE THE FLOOR JOIST ATTACHED BY WIRE. PILES MUST HAVE 4 FLOOR SOCKS EVENLY SPACED ACROSS THE LENGTH.

CONNECT TEMPORARY OUTLET PIPING TO OGS - MAKE CONNECTIONS PER PER WALL.

I hereby certify that this plan, specification or report was prepared by me or under my direct supervision and that I am a duly Licensed PROFESSIONAL ENGINEER under the laws of the State of MINNESOTA

DAVID A. REY
Registration Number 40180 Date XXXX


Description	Revisions	
	Date	Num

Comm: XXX
Date: XXXX
Drawn: BJD
Check: DAR

**EROSION
PREVENTION AND
SEDIMENT
CONTROL
PLAN
OVERALL**

Scale: 1" = 60'

C1.50

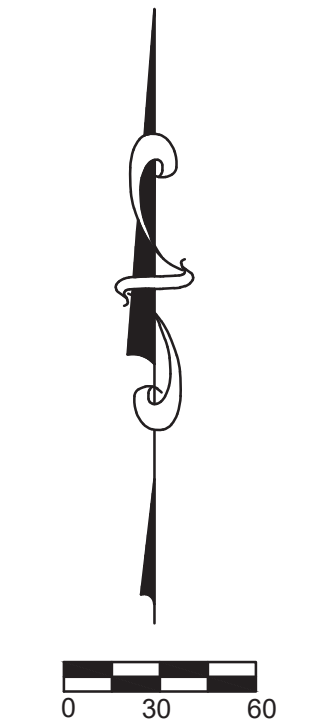



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L2.6 PLANTING PLAN NOTES

- REFER TO THE GENERAL NOTES.
- SEE ARCHITECTURAL AND ELECTRICAL DRAWINGS FOR LIGHTING SELECTIONS AND ELECTRICAL INFORMATION.
- SEE CIVIL FOR GRADING INFORMATION.
- SEE SHEET L300 FOR PLANTING NOTES AND DETAILS.
- SEE SPECIFICATIONS FOR SOILS AND INSTALLATION REQUIREMENTS.
- SEE CIVIL EXISTING CONDITIONS PLAN FOR BENCHMARKS AND BOUNDARY INFORMATION.
- SEE ARCHITECTURAL DRAWINGS FOR BUILDING INFORMATION.
- DO NOT SCALE THE DRAWINGS. WRITTEN DIMENSIONS ARE TO BE USED FOR ALL LAYOUT WORK. IF A NECESSARY DIMENSION IS NOT SHOWN CONTRACTOR SHALL NOTIFY THE LANDSCAPE ARCHITECT AND REQUEST THE INFORMATION PRIOR TO RELATED WORK.
- AT THE DISCRETION OF THE LANDSCAPE ARCHITECT, ELECTRONIC FILES OR COORDINATES WILL BE PROVIDED TO THE CONTRACTOR FOR SITE LAYOUT/STAKING.
- FIELD VERIFY ALL MEASUREMENTS AND NOTIFY LANDSCAPE ARCHITECT OF ANY DISCREPANCIES WITH SITE CONDITIONS.
- CONTRACTOR SHALL IMMEDIATELY NOTIFY THE LANDSCAPE ARCHITECT OF ANY LAYOUT DISCREPANCIES.

PLANT SCHEDULE - L2.6

TAG	QTY	COMMON NAME	BOTANICAL NAME	SIZE	NOTES
TREES					
AF	6	SIENNA GLEN MAPLE	ACER X FREEMANII 'AUTUMN GLEN'	3" B+B	STRAIGHT LEADER
GT	6	SKYLINE HONEYLOCUST	GLEDITSIA TRIACANTHOS VAR INERMIS 'SKYCOLE'	3" B+B	STRAIGHT LEADER
JV	6	EASTERN RED CEDAR	JUNIPERUS VIRGINIANA	6" B+B	
PG	5	BLACK HILLS SPRUCE	PICEA GLAUCA VAR. DENSATA	6" B+B	
PC	5	PRAIRIE STATESMAN SWISS STONE PINE	PINUS CEMBRA 'HERMAN'	6" B+B	STRAIGHT LEADER
SHRUBS					
CS	3	ARCTIC FIRE DOGWOOD	CORNUS STOLONIFERA 'FARROW'	#5 CONT	SPACING PER PLAN, 4' O.C. TYP.
HA	3	ANNABELLE HYDRANGEA	HYDRANGEA ARBORESCENS 'ANNABELLE'	#5 CONT	SPACING PER PLAN, 4' O.C. TYP.
JC	34	SEA GREEN JUNIPER	JUNIPERUS CHINENSIS 'SEA GREEN'	#5 CONT.	SPACING PER PLAN.
JS	6	ARCADIA JUNIPER	JUNIPERUS SABINA 'ARCADIA'	#5 CONT.	SPACING PER PLAN, 4' O.C. TYP.
SV	80	COMMON WHITE LILAC	SYRINGA VULGARIS VAR. ALBA	#5 CONT.	SPACING PER PLAN.

L2.6 SOD / SEEDING NOTES:

TOTAL SODDED AREA FOR NE GREENSPACE:	9,647 SF
TOTAL SEEDED AREA FOR NE GREENSPACE:	10,248 SF
TOTAL SODDED AREA FOR COMMUNITY GARDENS:	2,239 SF
TOTAL SEEDED AREA FOR COMMUNITY GARDENS:	33,972 SF

- AREAS TO BE SODDED
- AREAS TO BE SEEDED W/ MNDOT 35-241 - MESIC PRAIRIE SEED MIX

OPEN SPACE PLANTINGS - NE GREENSPACE

NE GREENSPACE OPEN SPACE	19,895 SF
TREES REQUIRED (LARGE)	10
SHRUBS REQUIRED (LARGE)	30
TREES PROVIDED: 23 LARGE + 5 MEDIUM	26 LG.
SHRUBS PROVIDED: 34 LARGE + 12 MEDIUM	42 LG.

OPEN SPACE PLANTINGS - COMMUNITY GARDEN

OPEN SPACE	54,073 SF
TREES REQUIRED (LARGE)	27
SHRUBS REQUIRED (LARGE)	80
TREES PROVIDED: 127 LG (PRESERVED EQUIVALENTS)	127 LG.
SHRUBS PROVIDED:	80 LG.


Description	Revision	Date	Num
PUD Submittal		10/08/2018	
PUD Resubmittal		01/14/2019	

Comm: 186024
Date: 01/14/2019
Drawn: _____
Check: _____
North


NE Greenspace & Community Garden Area Planting Plans

Scale: SEE DRAWING

L2.6

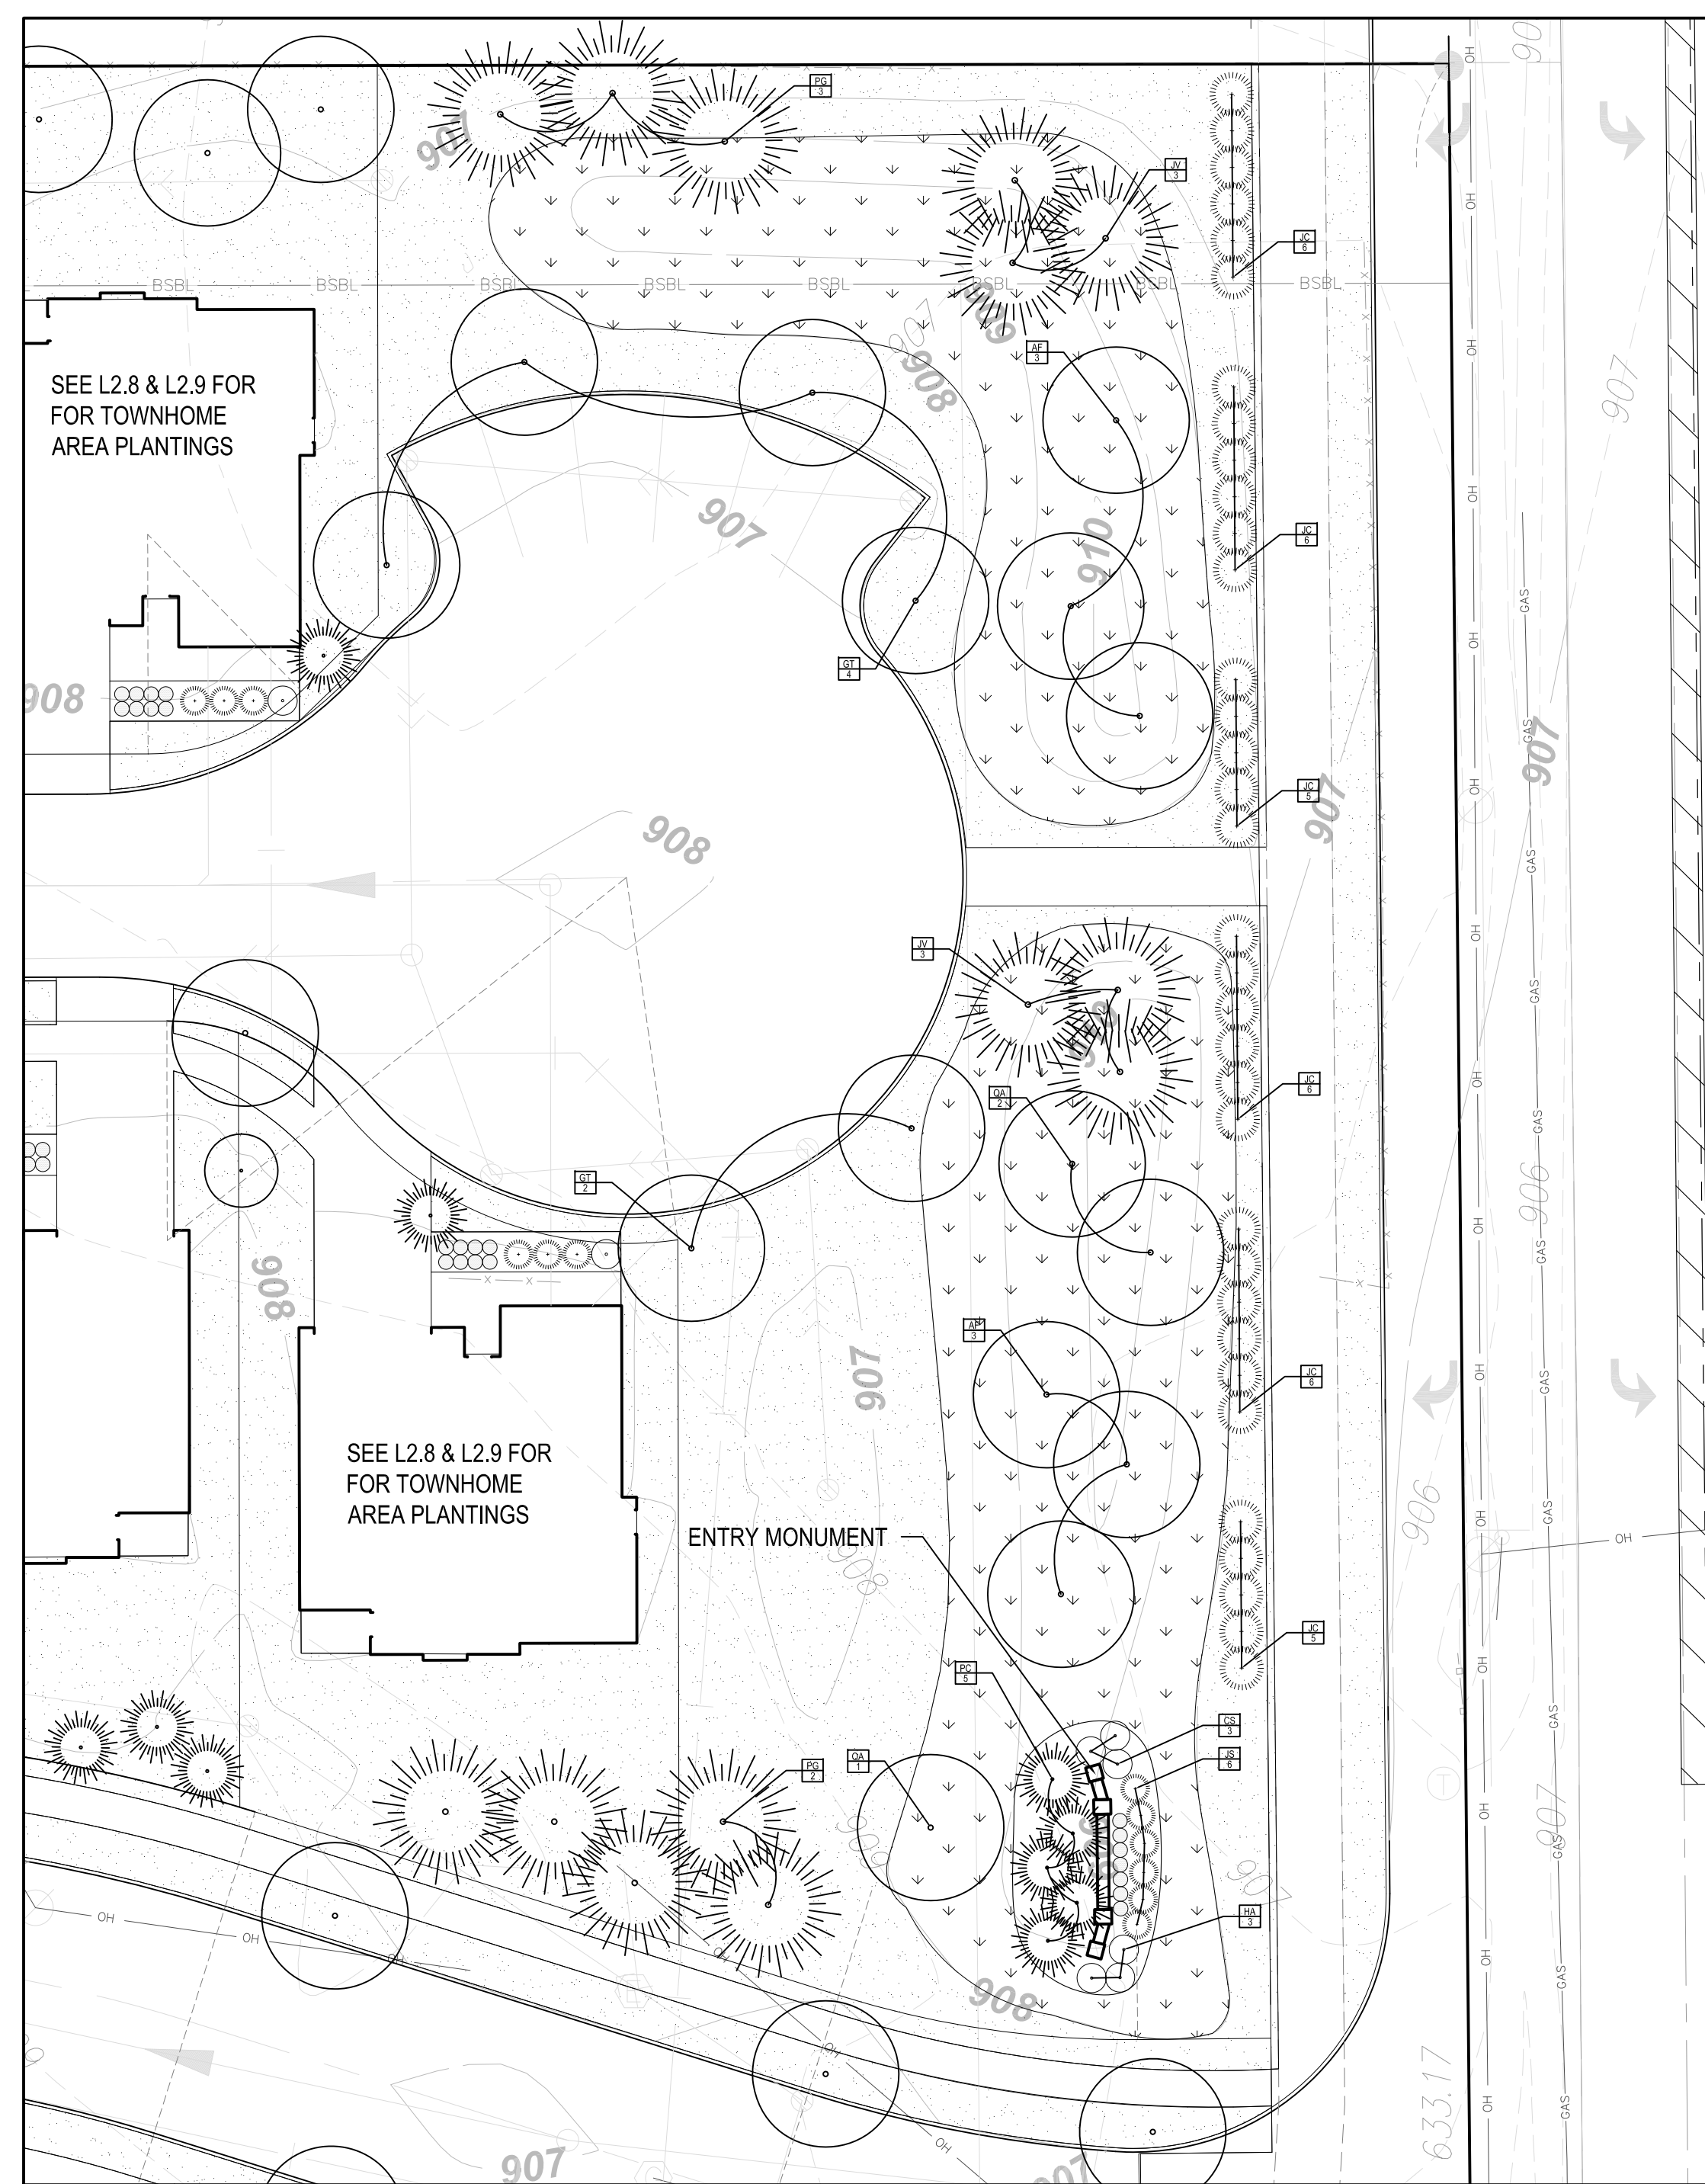

1 NE GREENSPACE PLANTING PLAN
1" = 20'

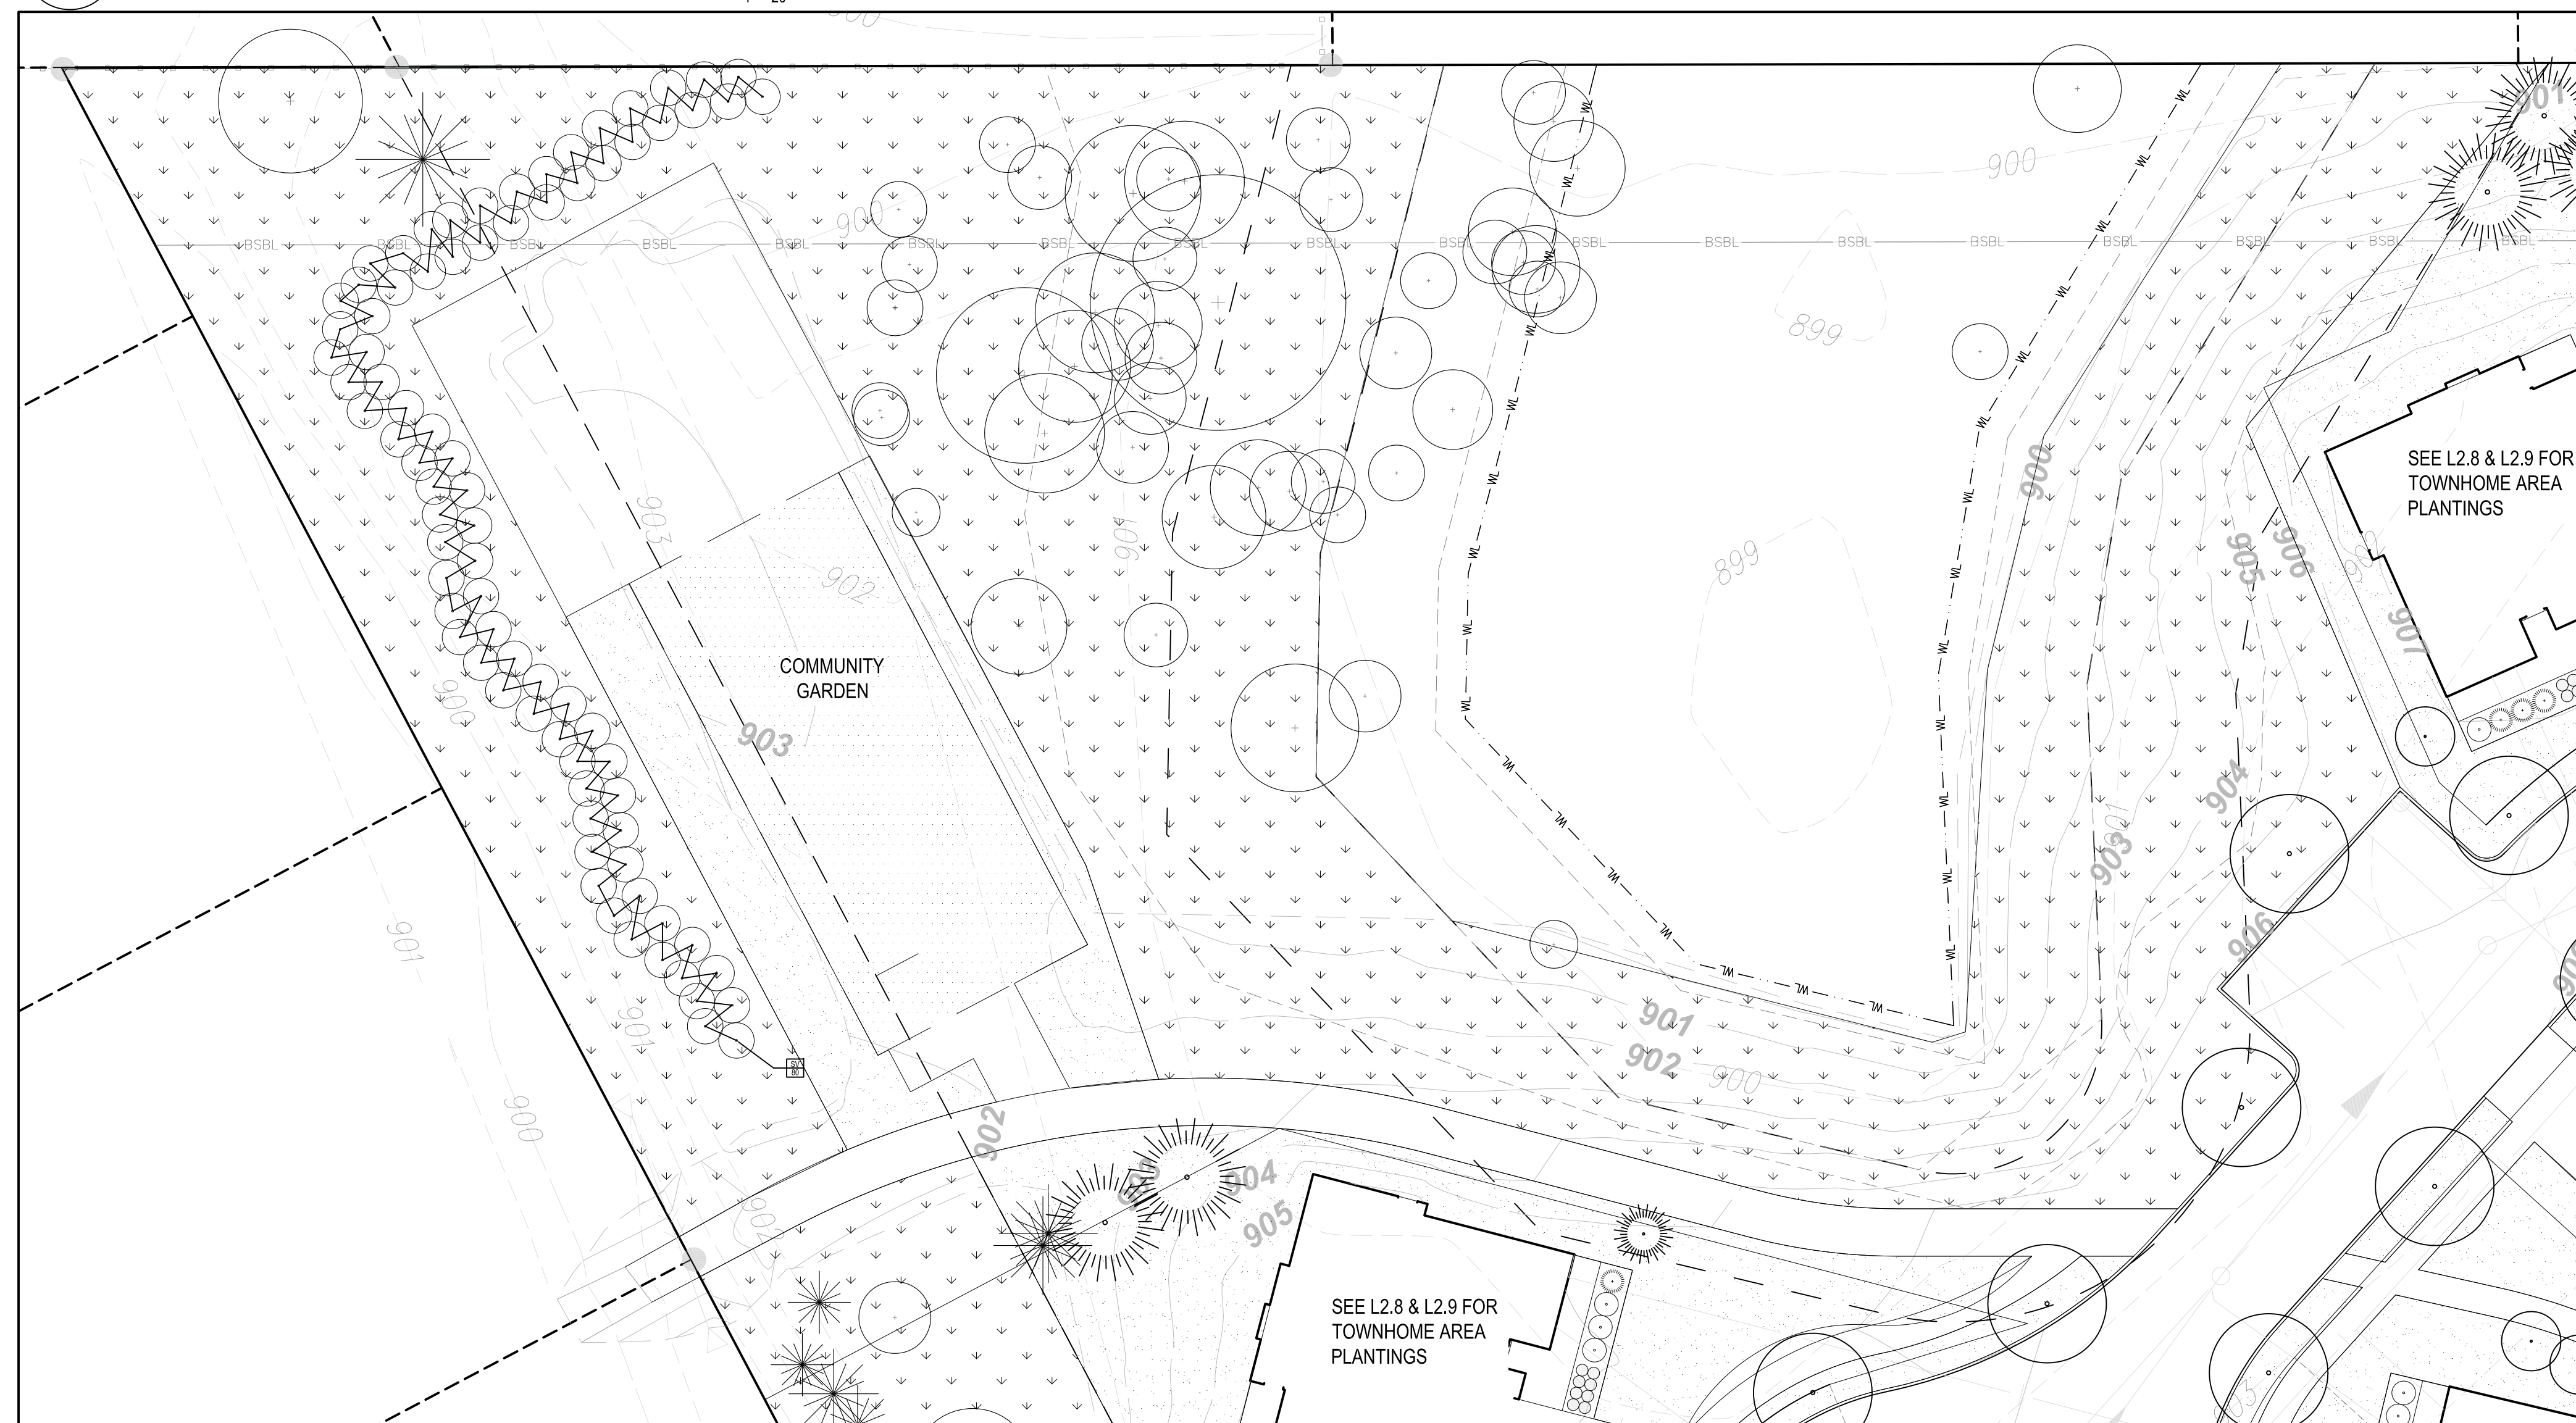


2 COMMUNITY GARDEN AREA PLANTING PLAN
1" = 20'

1" = 20'

MN

A

CONSULT: BENTON & BOWLES, ARCHITECTS, INC., 1000 W. WASHINGTON AVENUE, SUITE 200, MINNEAPOLIS, MN 55401
 CONSULT: HOK, INC., 1000 W. WASHINGTON AVENUE, SUITE 200, MINNEAPOLIS, MN 55401
 CONSULT: MNDOT, 35-241 - MESIC PRAIRIE SEED MIX



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L0.1 TREE PRESERVATION PLAN NOTES

- REFER TO THE GENERAL NOTES.
- SEE CIVIL FOR GRADING INFORMATION.
- SEE SHEET L200 FOR PLANTING NOTES AND DETAILS.
- SEE CIVIL EXISTING CONDITIONS PLAN FOR BENCHMARKS AND BOUNDARY INFORMATION.
- SEE ARCHITECTURAL DRAWINGS FOR BUILDING INFORMATION.
- THIS TREE PRESERVATION PLAN IS BASED ON A SITE AND TREE SURVEY PROVIDED TO THE LANDSCAPE ARCHITECT BY OTHERS. SEE SURVEY AND TREE SURVEY FOR ORIGINAL INFORMATION, TREE INVENTORY, AND BENCHMARKS.
- ALL ROOT PROTECTION ZONES (5' OUTSIDE DRILLLINE) OF PRESERVED TREES MUST BE PROTECTED WITH MIN. 4 HT. ORANGE SNOW FENCE WITH POSTS MAX. 6" O.C. PRIOR TO AND THROUGHOUT CONSTRUCTION. STAGING, STORAGE OF MATERIALS, PARKING OF VEHICLES, FOOT TRAFFIC, CONSTRUCTION OR OTHER ACCESS ROUTES, AND ANY FORM OF DISTURBANCE OR ACTIVITIES THAT MAY CAUSE COMPACTION ARE PROHIBITED WITHIN ROOT PROTECTION ZONES AT ALL TIMES.
- DO NOT SCALE THE DRAWINGS. WRITTEN DIMENSIONS ARE TO BE USED FOR ALL LAYOUT WORK. IF A NECESSARY DIMENSION IS NOT SHOWN CONTRACTOR SHALL NOTIFY THE LANDSCAPE ARCHITECT AND REQUEST THE INFORMATION PRIOR TO RELATED WORK.
- AT THE DISCRETION OF THE LANDSCAPE ARCHITECT, ELECTRONIC FILES OR COORDINATES WILL BE PROVIDED TO THE CONTRACTOR FOR SITE LAYOUT/STAKING.
- FIELD VERIFY ALL MEASUREMENTS AND NOTIFY LANDSCAPE ARCHITECT OF ANY DISCREPANCIES WITH SITE CONDITIONS.
- CONTRACTOR SHALL IMMEDIATELY NOTIFY THE LANDSCAPE ARCHITECT OF ANY LAYOUT DISCREPANCIES.

PRESERVED TREES


Tree #	Species	DBH	Condition	Stems
1	Oak, red	18.0	Good	1
2	Aspen	15.0	Good	1
3	Aspen	6.0	Good	1
4	Aspen	6.5	Fair	1
5	Aspen	7.0	Good	1
6	Aspen	6.5	Good	1
7	Oak, red	21.5	Good	1
8	Oak, red	15.0	Good	1
9	Oak, red	14.0	Good	1
10	Oak, red	15.0	Good	1
11	Oak, red	15.0	Good	1
12	Oak, red	15.0	Good	1
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19	Oak, red	15.0	Good	1
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193	Oak, red	15.0	Good	1
194	Oak, red	15.0	Good	1
195	Oak, red	15.0	Good	1
196	Oak, red	15.0	Good	1
197	Oak, red	15.0	Good	1
198	Oak, red	15.0	Good	1
199	Oak, red	15.0	Good	1
200	Oak, red	15.0	Good	1
201	Oak, red	15.0	Good	1
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203	Oak, red	15.0	Good	1
204	Oak, red	15.0	Good	1
205	Oak, red	15.0	Good	1
206	Oak, red	15.0	Good	1
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214	Oak, red	15.0	Good	1
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270	Oak, red	15.0	Good	1
271	Oak, red	15.0	Good	1
272	Oak, red	15.0	Good	1
273	Oak, red	15.0	Good	1



L1.1 IRRIGATION PLAN NOTES

1. REFER TO THE GENERAL NOTES.
2. SEE ARCHITECTURAL AND ELECTRICAL DRAWINGS FOR LIGHTING SELECTIONS AND ELECTRICAL INFORMATION.
3. SEE CIVIL FOR GRADING INFORMATION.
4. SEE SHEET L200 FOR PLANTING NOTES AND DETAILS.
5. SEE SPECIFICATIONS FOR SOILS AND INSTALLATION REQUIREMENTS.
6. SEE CIVIL EXISTING CONDITIONS PLAN FOR BENCHMARKS AND BOUNDARY INFORMATION.
7. SEE ARCHITECTURAL DRAWINGS FOR BUILDING INFORMATION.
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10. FIELD VERIFY ALL MEASUREMENTS AND NOTIFY LANDSCAPE ARCHITECT OF ANY DISCREPANCIES WITH SITE CONDITIONS.
11. CONTRACTOR SHALL IMMEDIATELY NOTIFY THE LANDSCAPE ARCHITECT OF ANY LAYOUT DISCREPANCIES.

KEY

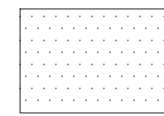 AREAS TO BE IRRIGATED


IRRIGATION NOTES

1. ALL SHRUB AND PERENNIAL BEDS SHALL BE IRRIGATED WITH DRIP IRRIGATION
2. ALL TURF AREAS SHALL BE IRRIGATED WITH SPRAY HEADS OR ROTORS

Lyngblomsten Senior Communities

Hodgson Road,
Lino Lakes, MN 55014

Lyngblomsten
1415 Almond Ave W, St Paul, MN 55108




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Saint Paul, MN 55101
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101 East Franklin Avenue | Minneapolis MN 55408
colbergtews.com

Revisions		
Description	Date	Num
PLUD Submittal	10/08/2018	
PLUD Resubmittal	01/01/2019	

Comm: 186024
Date: 01/14/2019
Drawn: _____
Check: _____

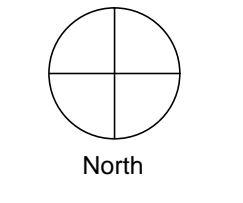

North

Irrigated Areas Plan

MN

A

1 IRRIGATED AREAS PLAN
1" = 40'

Scale: 1" = 40'

L1.1

MN



L2.0 PLANTING PLAN NOTES

1. REFER TO THE GENERAL NOTES.
2. SEE ARCHITECTURAL AND ELECTRICAL DRAWINGS FOR LIGHTING SELECTIONS AND ELECTRICAL INFORMATION.
3. SEE CIVIL FOR GRADING INFORMATION.
4. SEE SHEET L3.00 FOR PLANTING NOTES AND DETAILS.
5. SEE SPECIFICATIONS FOR SOILS AND INSTALLATION REQUIREMENTS.
6. SEE CIVIL EXISTING CONDITIONS PLAN FOR BENCHMARKS AND BOUNDARY INFORMATION.
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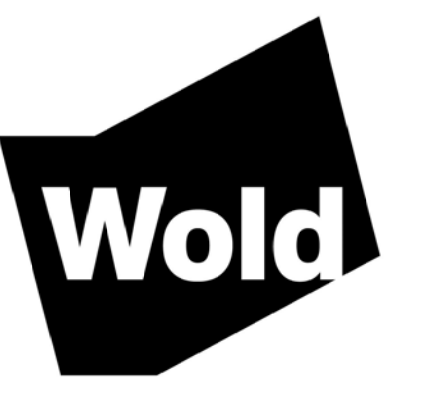
PLANT SCHEDULE - L2.0

TAG	QTY	COMMON NAME	BOTANICAL NAME	SIZE	NOTES
TREES					
AF	21	SIENNA GLEN MAPLE	ACER X FREEMANII 'AUTUMN GLEN'	3" B+B	STRAIGHT LEADER
GD	7	ESPRESSO KENTUCKY COFFEETREE	GYMNOCLADUS DIOICUS 'ESPRESSO - JFS'	3" B+B	STRAIGHT LEADER
QE	19	NORTHERN PIN OAK	QUERCUS ELLIPSOIDALIS	3" B+B	STRAIGHT LEADER

Lyngblomsten Senior Communities

Hodgson Road, Lino Lakes, MN 55014

Lyngblomsten 1415 Almond Ave W, St Paul, MN 55108



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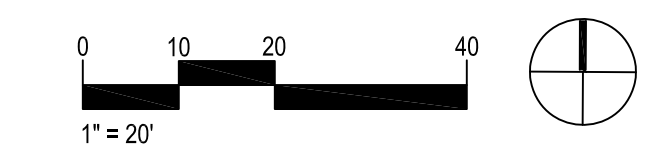
Description	Revisions		Num
	Date	Num	
PUD Submittal	10/08/2018		
PUD Resubmittal	01/14/2019		

Comm: 186024 Date: 01/14/2019 Drawn: Check: North

Boulevard Tree Planting Plan

A

1 BOULEVARD TREE PLANTING PLAN 1" = 20'




Scale: 1" = 40'

L2.0



L2.1 PLANTING PLAN NOTES

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2. SEE ARCHITECTURAL AND ELECTRICAL DRAWINGS FOR LIGHTING SELECTIONS AND ELECTRICAL INFORMATION.
3. SEE CIVIL FOR GRADING INFORMATION.
4. SEE SHEET L300 FOR PLANTING NOTES AND DETAILS.
5. SEE SPECIFICATIONS FOR SOILS AND INSTALLATION REQUIREMENTS.
6. SEE CIVIL EXISTING CONDITIONS PLAN FOR BENCHMARKS AND BOUNDARY INFORMATION.
7. SEE ARCHITECTURAL DRAWINGS FOR BUILDING INFORMATION.
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1 MAIN BUILDING NORTH PLANTING PLAN
1" = 20'

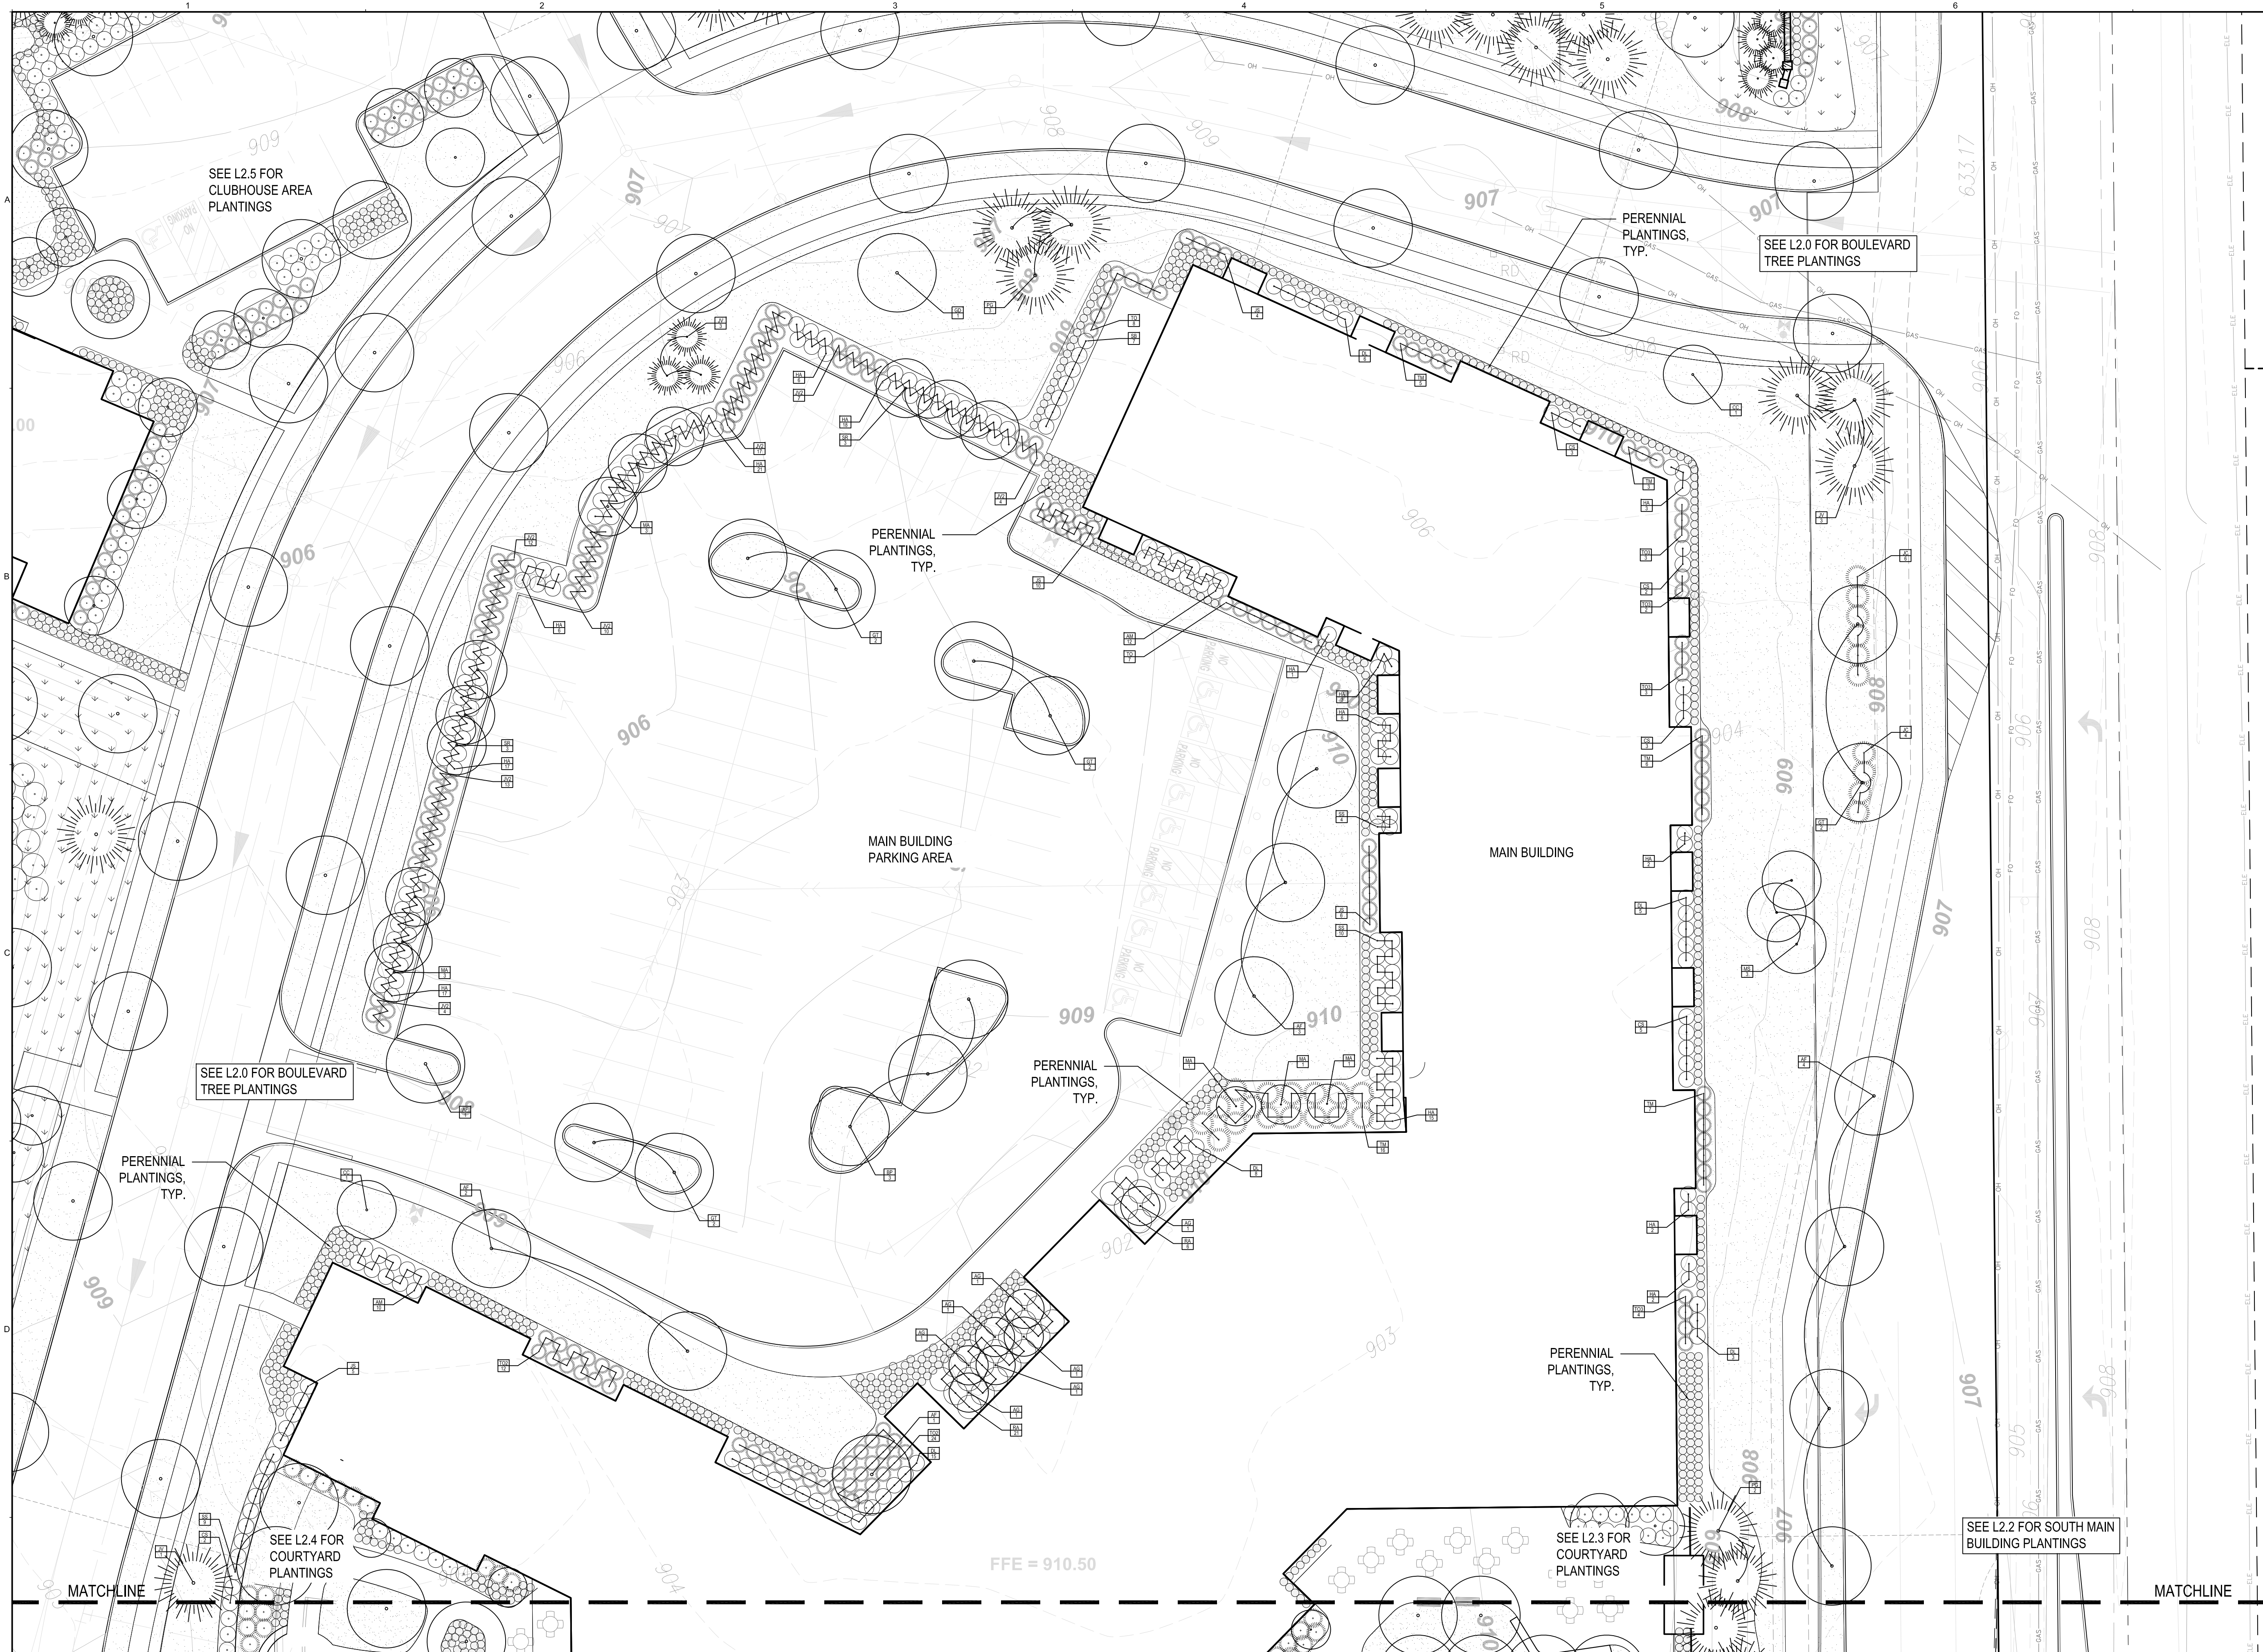PLANT SCHEDULE - L2.1

TAG	QTY	COMMON NAME	BOTANICAL NAME	SIZE	NOTES
TREES					
AF	11	SIENNA GLEN MAPLE	ACER X FREEMANII 'AUTUMN GLEN'	3" B+B	STRAIGHT LEADER
AG	7	AUTUMN BRILLIANCE SERVICEBERRY	AMELANCHIER X GRANDIFLORA 'AUTUMN BRILLIANCE'	8' CLUMP	CLUMP FORM
BP	3	WHITESPIRE BIRCH	BETULA PLATYPHYLLA 'WHITESPIRE'	2.5" B+B	STRAIGHT LEADER
CC	2	THORNLESS COCKSPUR HAWTHORN	CRETAEGUS CRUS GALLI VAR. INERMIS	1.5" B+B	TREE FORM
GD	1	ESPRESSO KENTUCKY COFFEETREE	GYMNOCLADUS DIOICIS 'ESPRESSO - JFS'	3" B+B	STRAIGHT LEADER
GT	8	SKYLINE HONEYLOCUST	GLEDITSIA TRIACANTHOS VAR INERMIS 'SKYCCLE'	3" B+B	STRAIGHT LEADER
JV	7	EASTERN RED CEDAR	JUNIPERUS VIRGINIANA	6" B+B	
MA	9	ADAMS CRABAPPLE	MALUS 'ADAMS'	1.5" B+B	TREE FORM
MA2	3	SPRING SNOW CRABAPPLE	MALUS 'SPRING SNOW'	1.5" B+B	TREE FORM
PG	5	BLACK HILLS SPRUCE	PICEA GLAUCA VAR. DENSATATA	6" B+B	

SR	QTY	COMMON NAME	BOTANICAL NAME	SIZE	TREE FORM
SHRUBS					
AM	22	IROQUOIS BEAUTY CHOKEBERRY	ARONIA MELANOCARPA 'MORTON'	#5 CONT.	SPACING PER PLAN, 4' O.C. TYP.
CS	15	ARCTIC FIRE DOGWOOD	CORNUS STOLONIFERA 'FARROW'	#5 CONT.	SPACING PER PLAN, 4' O.C. TYP.
DL	41	DWARF BUSH HONEYSUCKLE	DIERVILLA LONICERA	#5 CONT.	SPACING PER PLAN, 4' O.C. TYP.
HA	119	ANNABELLE HYDRANGEA	HYDRANGEA ARBORESCENS 'ANNABELLE'	#5 CONT.	SPACING PER PLAN, 4' O.C. TYP.
JC	10	SEA GREEN JUNIPER	JUNIPERUS CHINENSIS 'SEA GREEN'	#5 CONT.	SPACING PER PLAN.
JS	29	ARCADIA JUNIPER	JUNIPERUS SABINA 'ARCADIA'	#5 CONT.	SPACING PER PLAN, 4' O.C. TYP.
JS2	0	BLUE ARROW JUNIPER	JUNIPERUS SCOPULORUM 'BLUE ARROW'	#20 CONT.	SPACING PER PLAN, 4' O.C. TYP.
JV2	67	GREY OWL JUNIPER	JUNIPERUS VIRGINIANA 'GREY OWL'	#5 CONT.	SPACING PER PLAN, 4' O.C. TYP.
PF	0	ABBOTSWOOD POTENTILLA	POTENTILLA FRUTICOSA 'ABBOTSWOOD'	#5 CONT.	SPACING PER PLAN, 4' O.C. TYP.
RA	25	GRO LOW SUMAC	RHUS AROMATICA 'GRO-LOW'	#5 CONT.	SPACING PER PLAN, 4' O.C. TYP.
SS	23	ASH LEAF SPIREA	SORBARIA SORBIFOLIA	#5 CONT.	SPACING PER PLAN, 4' O.C. TYP.
SB	7	GOLDFLAME SPIREA	SPIREAEA X BUMALDA 'GOLDFLAME'	#5 CONT.	SPACING PER PLAN, 4' O.C. TYP.

TM	QTY	COMMON NAME	BOTANICAL NAME	SIZE	TREE FORM
TREES					
TO	15	MR. BOWLING BALL ARBORVITAE	THUJA OCCIDENTALIS 'BOBAZAM'	#5 CONT.	SPACING PER PLAN, 4' O.C. TYP.
TO2	36	GOLDEN GLOBE ARBORVITAE	THUJA OCCIDENTALIS 'GOLDEN GLOBE'	#5 CONT.	SPACING PER PLAN, 4' O.C. TYP.
TO3	12	RUSHMORE ARBORVITAE	THUJA OCCIDENTALIS 'RUSHMORE'	#20 CONT.	SPACING PER PLAN, 4' O.C. TYP.

L2.1 SOD / SEEDING NOTES:

TOTAL SODDED AREA FOR MAIN BUILDING PARCEL (L2.1+L2.2 COMBINED): 44,981 SF

AREAS TO BE SODDED

CANOPY COVERAGE CALCULATIONS

MAIN PARKING LOT	42,956 SF
CANOPY COVERAGE REQUIRED	17,182 SF
ISLAND W/ 3 LARGE TREES	3,600 SF
7 LG ISLAND TREES	6,650 SF
2 LG. TREES WITHIN 7'	1,200 SF
12 MED. TREES WITHIN 7'	6,000 SF
TOTAL CANOPY COVERAGE PROVIDED	17,450 SF

TOTAL FOUNDATION PLANTINGS - MAIN BUILDING (L2.1+L2.2 COMBINED)

MAIN BUILDING FOUNDATION- FRONT AND STREET FACING	1,981 LF
TREES REQUIRED (LARGE)	40
SHRUBS REQUIRED (LARGE)	119
TREES PROVIDED: 45 LG + 23 MED + 7 SM	63 LG.
SHRUBS PROVIDED: 455 MED. x .67=	304 LG.

TOTAL OPEN SPACE PLANTINGS - MAIN BUILDING (L2.1+L2.2 COMBINED)


MAIN BUILDING OPEN SPACE	45,374
TREES REQUIRED (LARGE)	23
SHRUBS REQUIRED (LARGE)	68
TREES PROVIDED: 23 LG + 3 MED	25 LG.
SHRUBS PROVIDED: 131 MED X .67=	87 LG.

Description	Revision	Date	Num
PUD Submittal		10/08/2018	
PUD Resubmittal		01/14/2019	

Comm: 186624
Date: 01/14/2019
Drawn: [Signature]
Check: [Signature]

Main Building North Planting Plan

MN

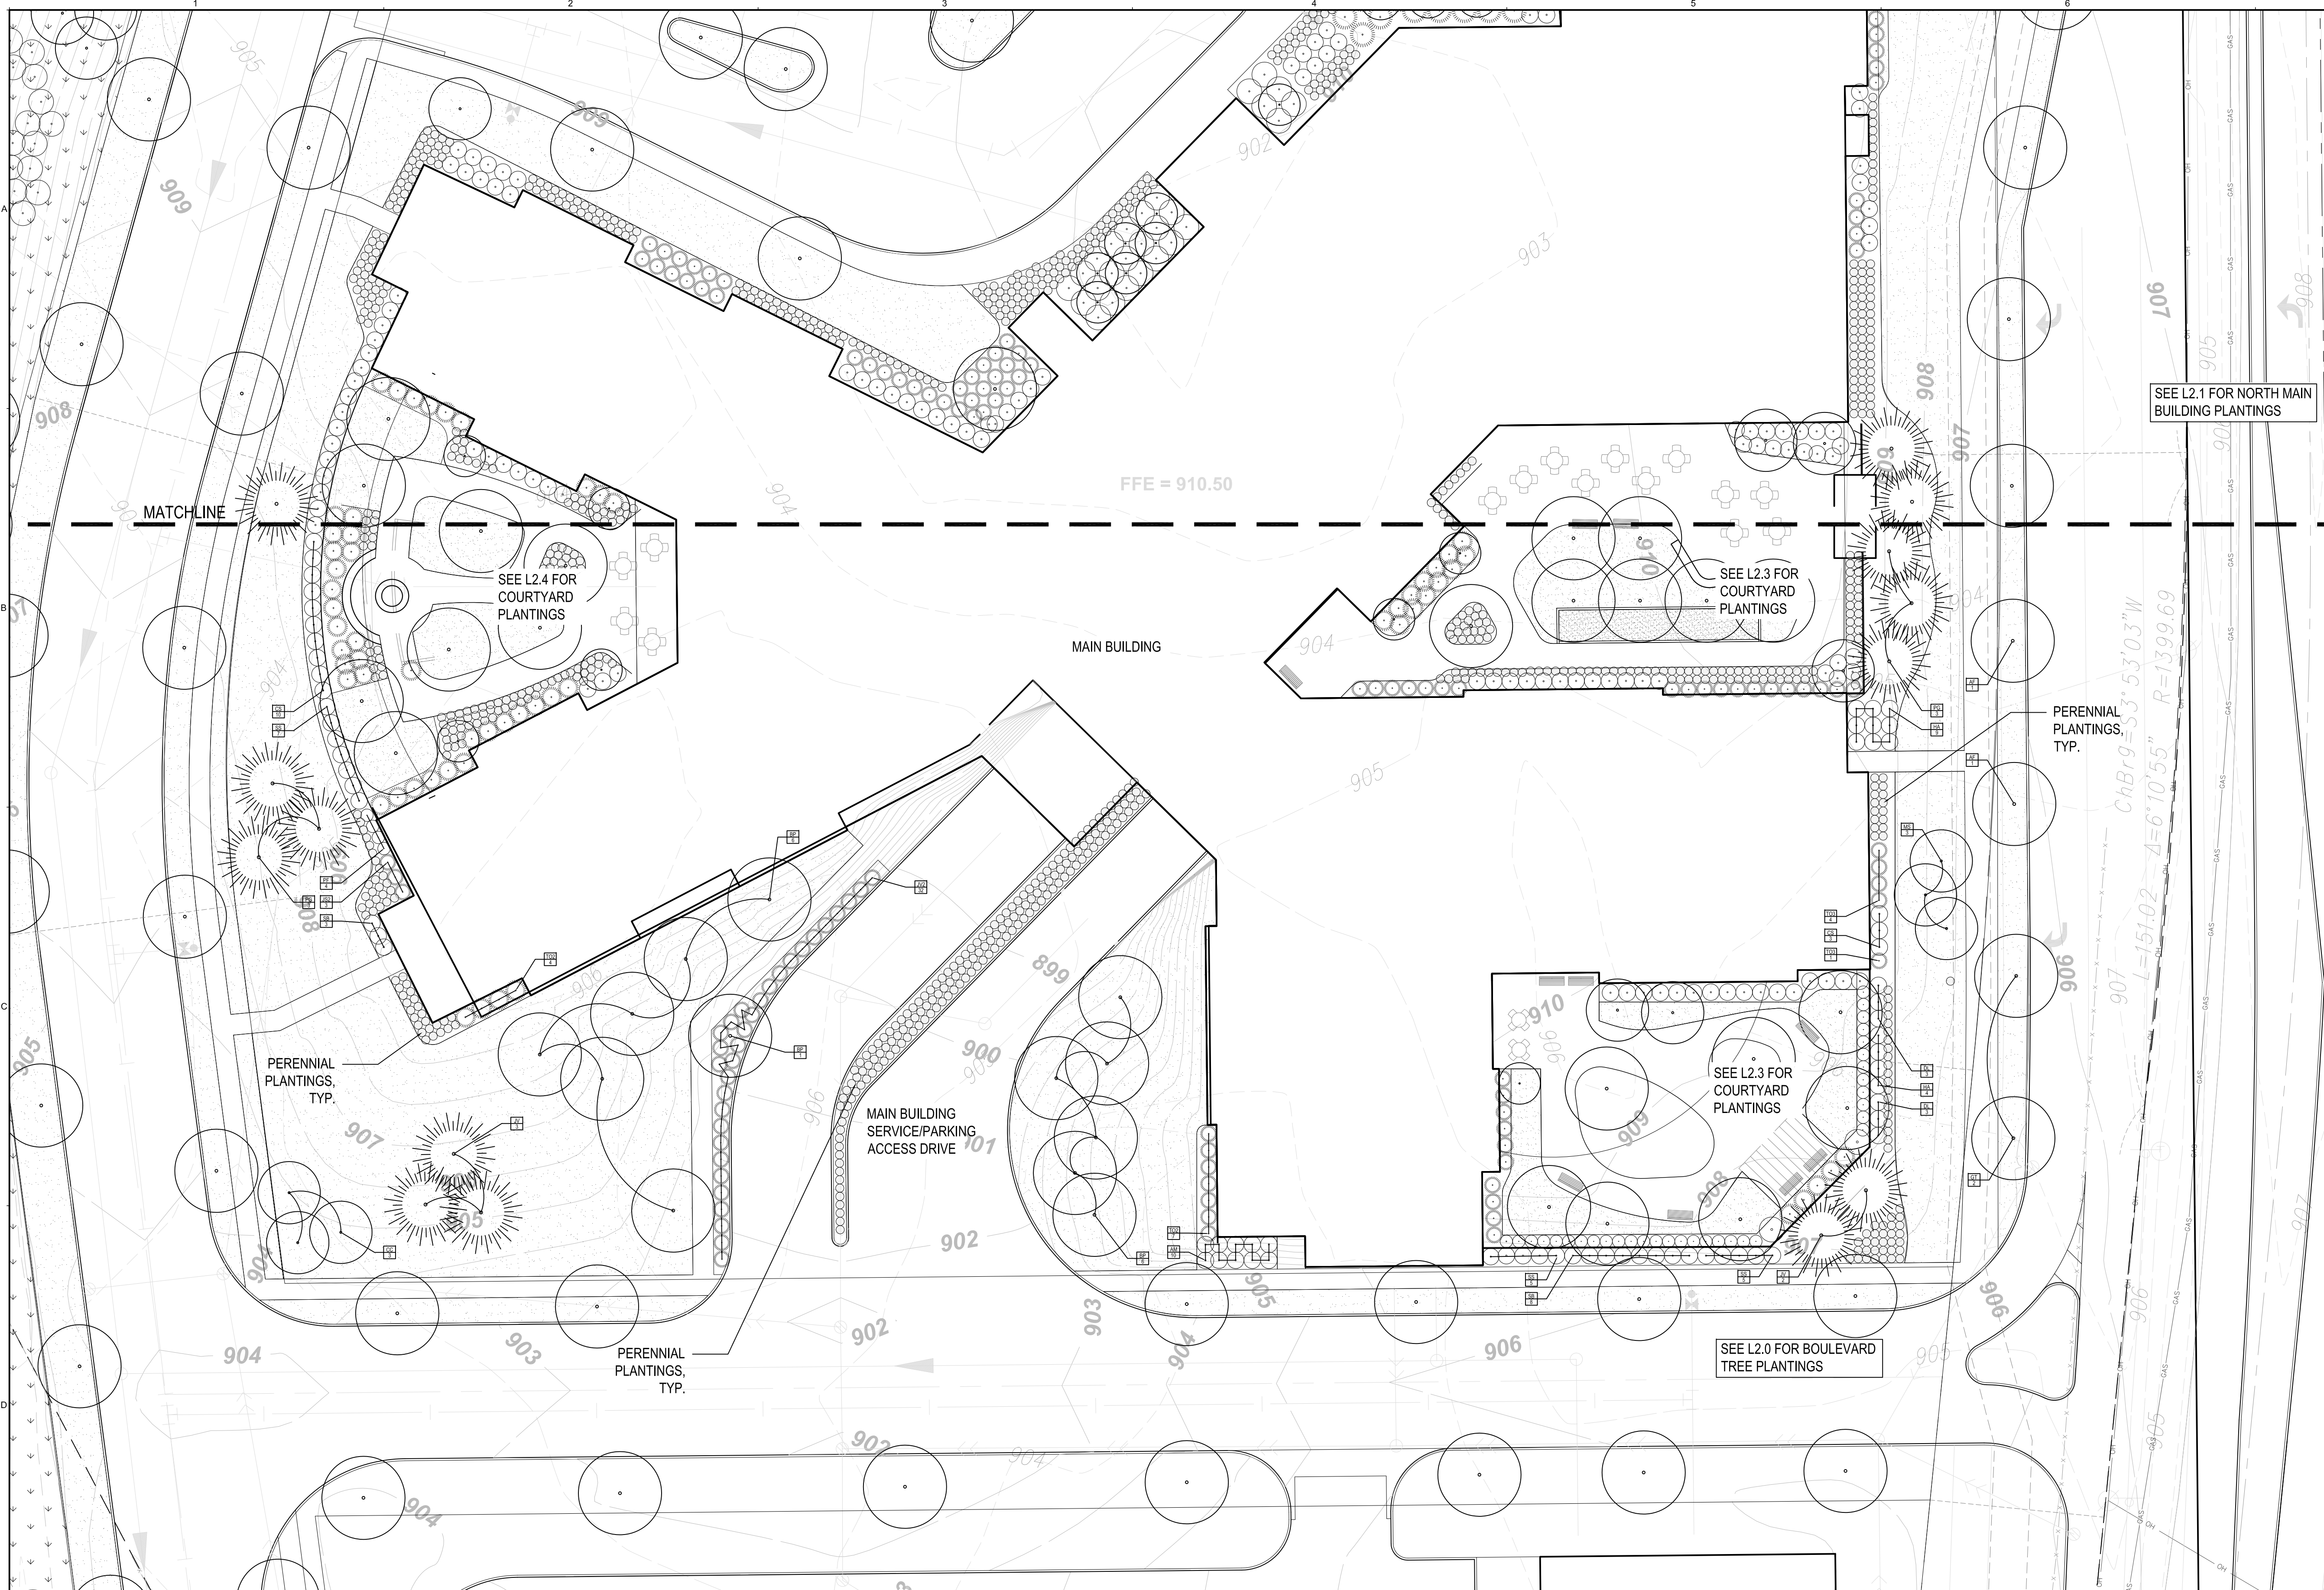

1 MAIN BUILDING SOUTH PLANTING PLAN
1" = 20'

L2.2 PLANTING PLAN NOTES

1. REFER TO THE GENERAL NOTES.
2. SEE ARCHITECTURAL AND ELECTRICAL DRAWINGS FOR LIGHTING SELECTIONS AND ELECTRICAL INFORMATION.
3. SEE CIVIL FOR GRADING INFORMATION.
4. SEE SHEET L300 FOR PLANTING NOTES AND DETAILS.
5. SEE SPECIFICATIONS FOR SOILS AND INSTALLATION REQUIREMENTS.
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7. SEE ARCHITECTURAL DRAWINGS FOR BUILDING INFORMATION.
8. DO NOT SCALE THE DRAWINGS. WRITTEN DIMENSIONS ARE TO BE USED FOR ALL LAYOUT WORK. IF A NECESSARY DIMENSION IS NOT SHOWN CONTRACTOR SHALL NOTIFY THE LANDSCAPE ARCHITECT AND REQUEST THE INFORMATION PRIOR TO RELATED WORK.
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Lyngblomsten Senior Communities

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Lino Lakes, MN 55014

Lyngblomsten
1415 Almond Ave W, St Paul, MN 55108

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Saint Paul, MN 55101
woldae.com | 651 227 7773

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landscape architecture
3111 East Franklin Avenue | Minneapolis, MN 55406
colberg.com

PLANT SCHEDULE - L2.2

TAG	QTY	COMMON NAME	BOTANICAL NAME	SIZE	NOTES
TREES					
AF	2	SIENNA GLEN MAPLE	ACER X FREEMANII 'AUTUMN GLEN'	3" B+B	STRAIGHT LEADER
AG	0	AUTUMN BRILLIANCE SERVICEBERRY	AMELANCHIER X GRANDIFLORA 'AUTUMN BRILLIANCE'	8' CLUMP	CLUMP FORM
BP	13	WHITESPIRE BIRCH	BETULA PLATYPHYLLA 'WHITESPIRE'	2.5" B+B	STRAIGHT LEADER
CC	3	THORNLESS COCKSPUR HAWTHORN	CRETAEGUS CRUS GALLI VAR. INERMIS	1.5" B+B	TREE FORM
GT	2	SKYLINE HONEYLOCUST	GLEDITSIA TRIACANTHOS VAR INERMIS 'SKYCOLE'	3" B+B	STRAIGHT LEADER
JV	5	EASTERN RED CEDAR	JUNIPERUS VIRGINIANA	6" B+B	
MA2	3	SPRING SNOW CRABAPPLE	MALUS 'SPRING SNOW'	1.5" B+B	TREE FORM
PG	6	BLACK HILLS SPRUCE	PICEA GLAUCA VAR. DENSATA	6" B+B	
SHRUBS					
AM	10	IROQUOIS BEAUTY CHOKEBERRY	ARONIA MELANOCARPA 'MORTON'	#5 CONT	SPACING PER PLAN, 4' O.C. TYP.

CS	13	ARCTIC FIRE DOGWOOD	CORNUS STOLONIFERA 'FARROW'	#5 CONT	SPACING PER PLAN, 4' O.C. TYP.
DL	6	DWARF BUSH HONEYSUCKLE	DIERVILLA LONICERA	#5 CONT.	SPACING PER PLAN, 4' O.C. TYP.
HA	13	ANNABELLE HYDRANGEA	HYDRANGEA ARBORESCENS 'ANNABELLE'	#5 CONT	SPACING PER PLAN, 4' O.C. TYP.
JC	0	SEA GREEN JUNIPER	JUNIPERUS CHINENSIS 'SEA GREEN'	#5 CONT.	SPACING PER PLAN.
JS	0	ARCADIA JUNIPER	JUNIPERUS SABINA 'ARCADIA'	#5 CONT	SPACING PER PLAN, 4' O.C. TYP.
JS2	3	BLUE ARROW JUNIPER	JUNIPERUS SCOPULORUM 'BLUE ARROW'	#20 CONT	SPACING PER PLAN, 4' O.C. TYP.
JV2	32	GREY OWL JUNIPER	JUNIPERUS VIRGINIANA 'GREY OWL'	#5 CONT	SPACING PER PLAN, 4' O.C. TYP.
PF	4	ABBOTSWOOD POTENTILLA	POTENTILLA FRUTICOSA 'ABBOTSWOOD'	#5 CONT.	SPACING PER PLAN, 4' O.C. TYP.
SS	17	ASH LEAF SPIREA	SORBARIA SORBIFOLIA	#5 CONT	SPACING PER PLAN, 4' O.C. TYP.
SB	11	GOLDFLAME SPIREA	SPIREAEA X BUMALDA 'GOLDFLAME'	#5 CONT.	SPACING PER PLAN, 4' O.C. TYP.
TO2	11	GOLDEN GLOBE ARBORVITAE	THUJA OCCIDENTALIS 'GOLDEN GLOBE'	#5 CONT	SPACING PER PLAN, 4' O.C. TYP.
TO3	5	RUSHMORE ARBORVITAE	THUJA OCCIDENTALIS 'RUSHMORE'	#20 CONT	SPACING PER PLAN, 4' O.C. TYP.

L2.1 SOD / SEEDING NOTES:

TOTAL SODDED AREA FOR MAIN BUILDING PARCEL (L2.1+L2.2 COMBINED): 44,981 SF



CANOPY COVERAGE CALCULATIONS

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CANOPY COVERAGE REQUIRED	17,182 SF
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SHRUBS REQUIRED (LARGE)	68
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Description	Revision	Date	Num
PUD Submittal		10/06/2018	
PUD Resubmittal		01/14/2019	

Comm: 186624
Date: 01/14/2019
Drawn: [Signature]
Check: [Signature]

Main Building South Planting Plan

Scale: 1" = 20'

L2.2



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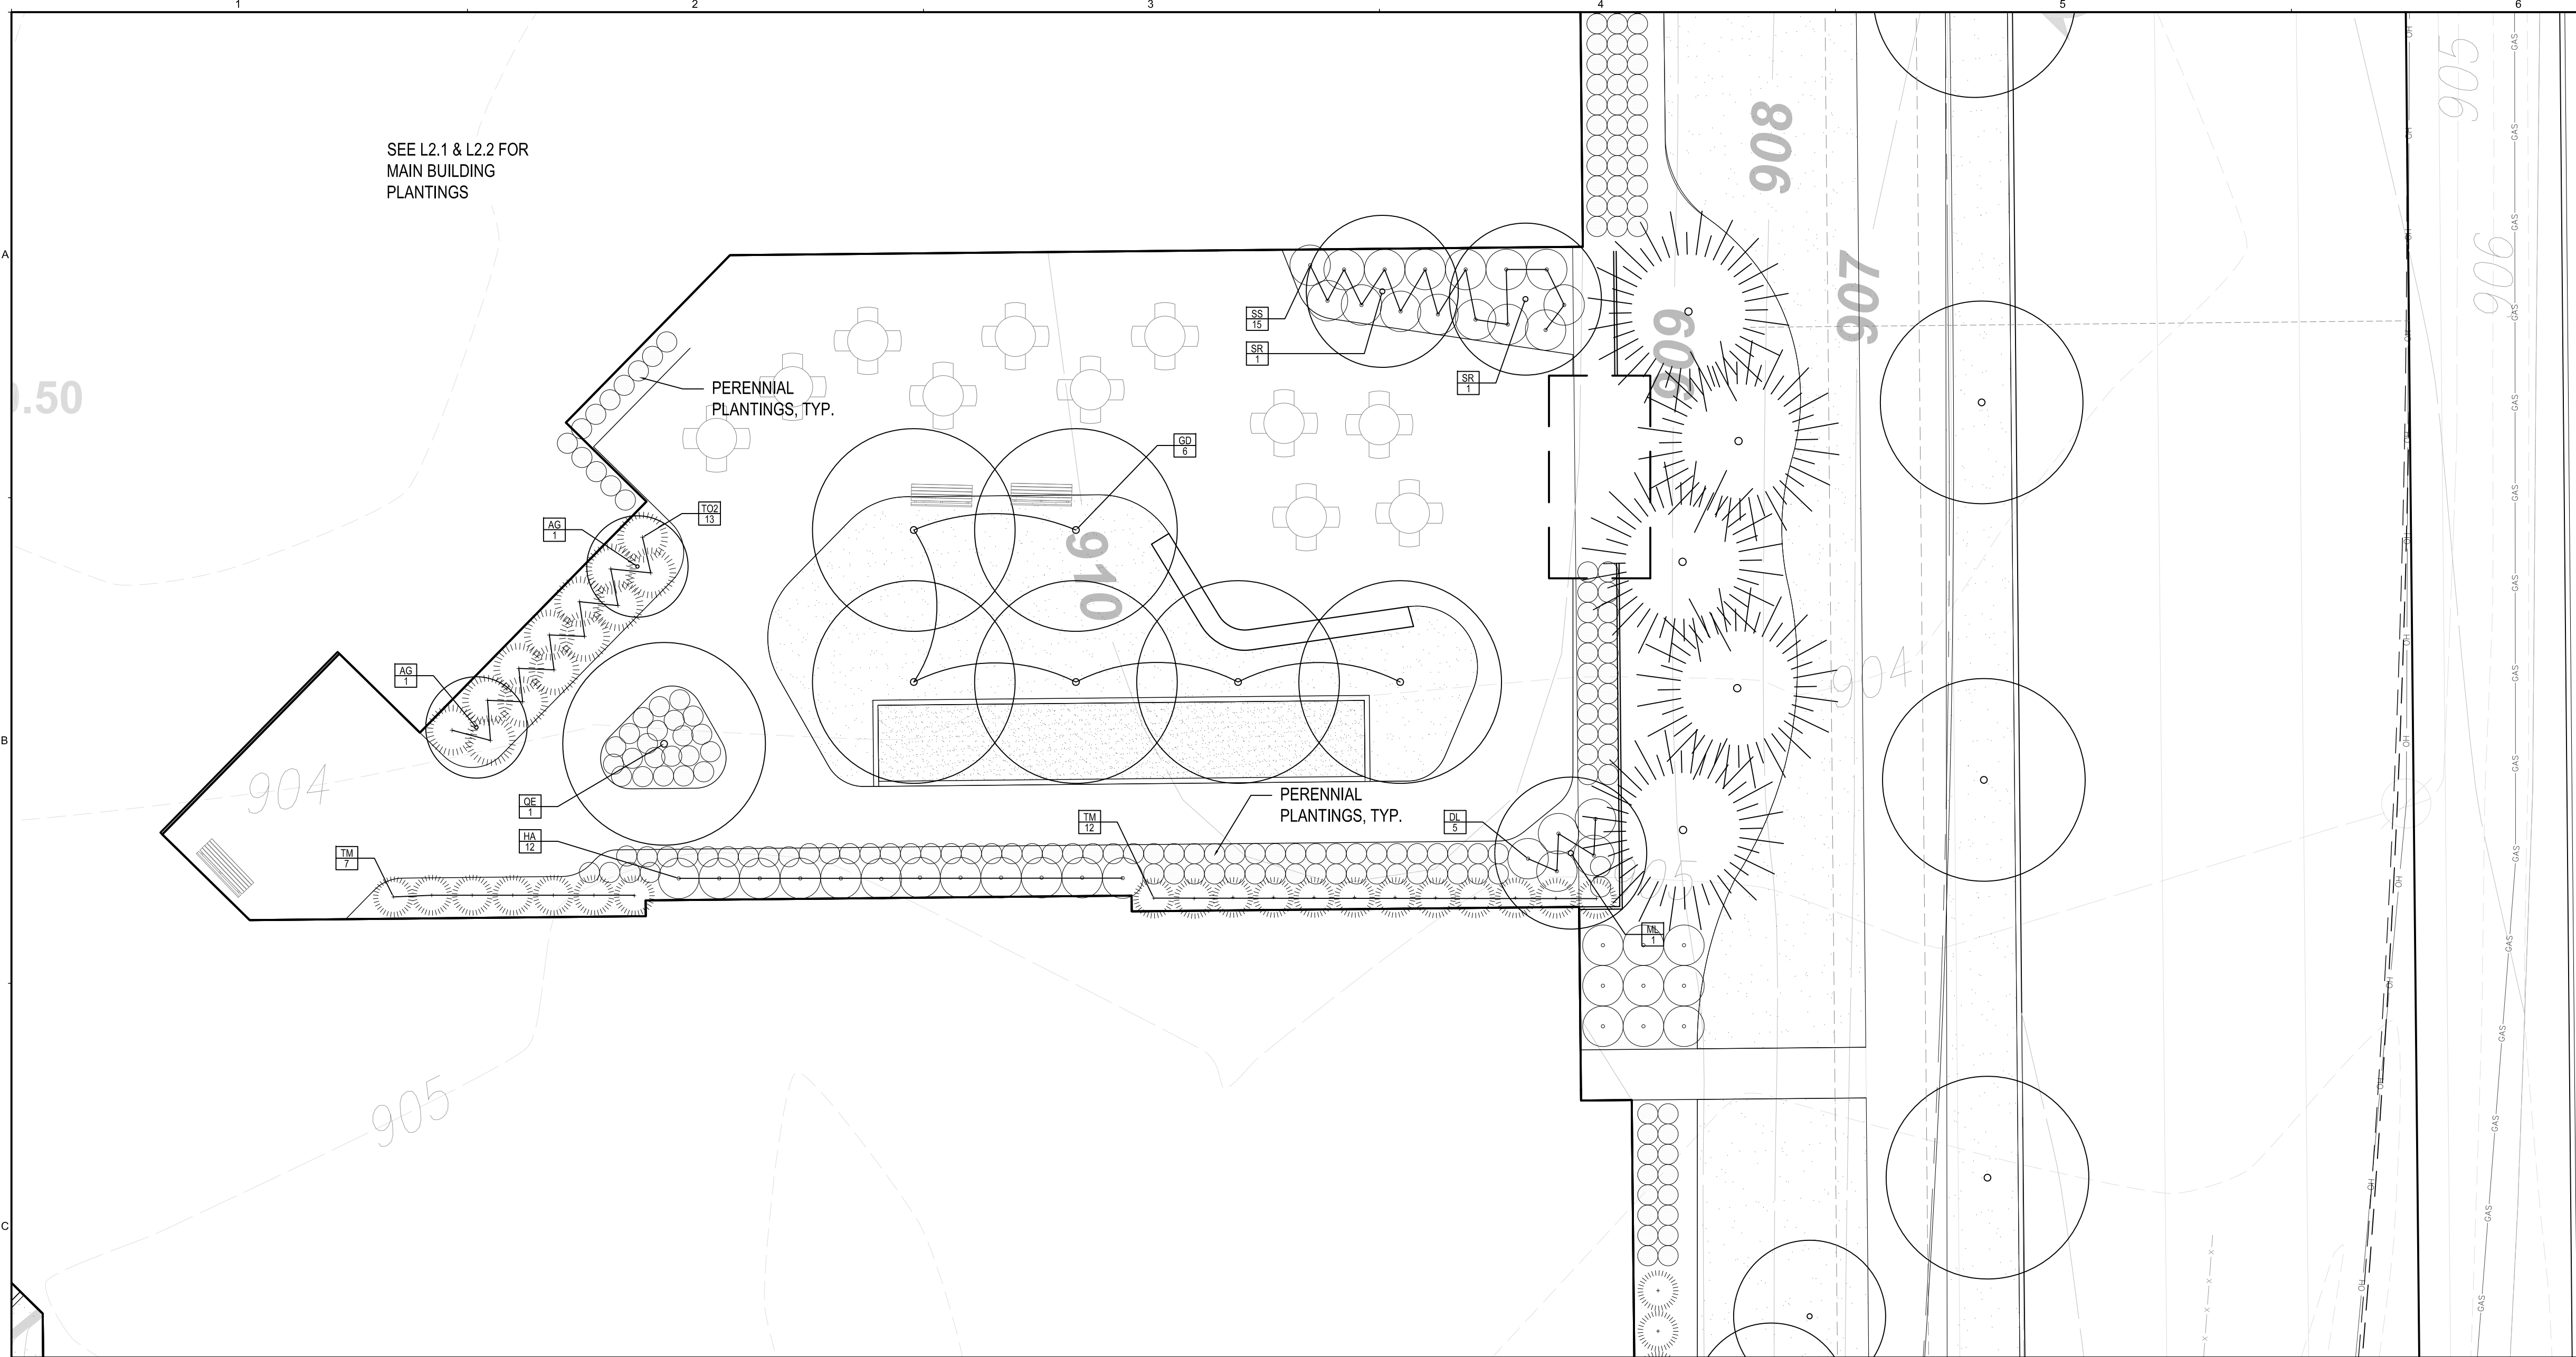
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landscape architecture
3101 East Franklin Avenue | Minneapolis, MN 55406
colberg.com

L2.3 PLANTING PLAN NOTES


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PLANT SCHEDULE - L2.3

TAG	QTY	COMMON NAME	BOTANICAL NAME	SIZE	NOTES
TREES					
AF	3	SIENNA GLEN MAPLE	ACER X FREEMANII 'AUTUMN GLEN'	3" B+B	STRAIGHT LEADER
AG	2	AUTUMN BRILLIANCE SERVICEBERRY	AMELANCHIER X GRANDIFLORA 'AUTUMN BRILLIANCE'	8' CLUMP	CLUMP FORM
GD	6	ESPRESSO KENTUCKY COFFEETREE	GYMNOCLADUS DIOICUS 'ESPRESSO - JFS'	3" B+B	STRAIGHT LEADER
GT	3	SKYLINE HONEYLOCUST	GLEDITSIA TRIACANTHOS VAR INERMIS 'SKYCOLE'	3" B+B	STRAIGHT LEADER
ML	2	LEONARD MESSEL MAGNOLIA	MAGNOLIA X LOEBNERI 'LEONARD MESSEL'	#10 CLUMP	CLUMP FORM
MA2	2	SPRING SNOW CRABAPPLE	MALUS 'SPRING SNOW'	1.5" B+B	TREE FORM
QA	1	WHITE OAK	QUERCUS ALBA	3" B+B	STRAIGHT LEADER
QE	1	NORTHERN PIN OAK	QUERCUS ELLIPSOIDALIS	3" B+B	STRAIGHT LEADER
SR	2	IVORY SILK TREE LILAC	SYRINGA RETICULATA 'IVORY SILK'	2" B+B	TREE FORM
SHRUBS					
AM	8	IROQUOIS BEAUTY CHOKEBERRY	ARONIA MELANOCARPA 'MORTON'	#5 CONT	SPACING PER PLAN, 4' O.C. TYP.
BU	4	CHICAGOLAND GREEN BOXWOOD	BUXUS 'GLENCOE'	#5 CONT.	SPACING PER PLAN, 4' O.C. TYP.
CS	12	ARCTIC FIRE DOGWOOD	CORNUS STOLONIFERA 'FARROW'	#5 CONT	SPACING PER PLAN, 4' O.C. TYP.
DL	5	DWARF BUSH HONEYSUCKLE	DIERVILLA LONICERA	#5 CONT.	SPACING PER PLAN, 4' O.C. TYP.
HA	21	ANNABELLE HYDRANGEA	HYDRANGEA ARBORESCENS 'ANNABELLE'	#5 CONT	SPACING PER PLAN, 4' O.C. TYP.
PO	2	SUMMER WINE NINEBARK	PHYSOCARPUS OPULIFOLIUS 'SEWARD'	#5 CONT.	SPACING PER PLAN, 4' O.C. TYP.
SS	19	ASH LEAF SPIREA	SORBARIA SORBIFOLIA	#5 CONT	SPACING PER PLAN, 4' O.C. TYP.
SB	12	GOLDFLAME SPIREA	SPIRAEA X BUMALDA 'GOLDFLAME'	#5 CONT.	SPACING PER PLAN, 4' O.C. TYP.
TM	23	TAUNTON YEW	TAXUS X MEDIA 'TAUNTONII'	#5 CONT.	SPACING PER PLAN, 4' O.C. TYP.
TO	6	MR. BOWLING BALL ARBORVITAE	THUJA OCCIDENTALIS 'BOBAZAM'	#5 CONT	SPACING PER PLAN, 4' O.C. TYP.
TO2	13	GOLDEN GLOBE ARBORVITAE	THUJA OCCIDENTALIS 'GOLDEN GLOBE'	#5 CONT	SPACING PER PLAN, 4' O.C. TYP.
TO3	5	RUSHMORE ARBORVITAE	THUJA OCCIDENTALIS 'RUSHMORE'	#20 CONT	SPACING PER PLAN, 4' O.C. TYP.



1 TOWN SQUARE COURTYARD PLANTING PLAN
1" = 10'

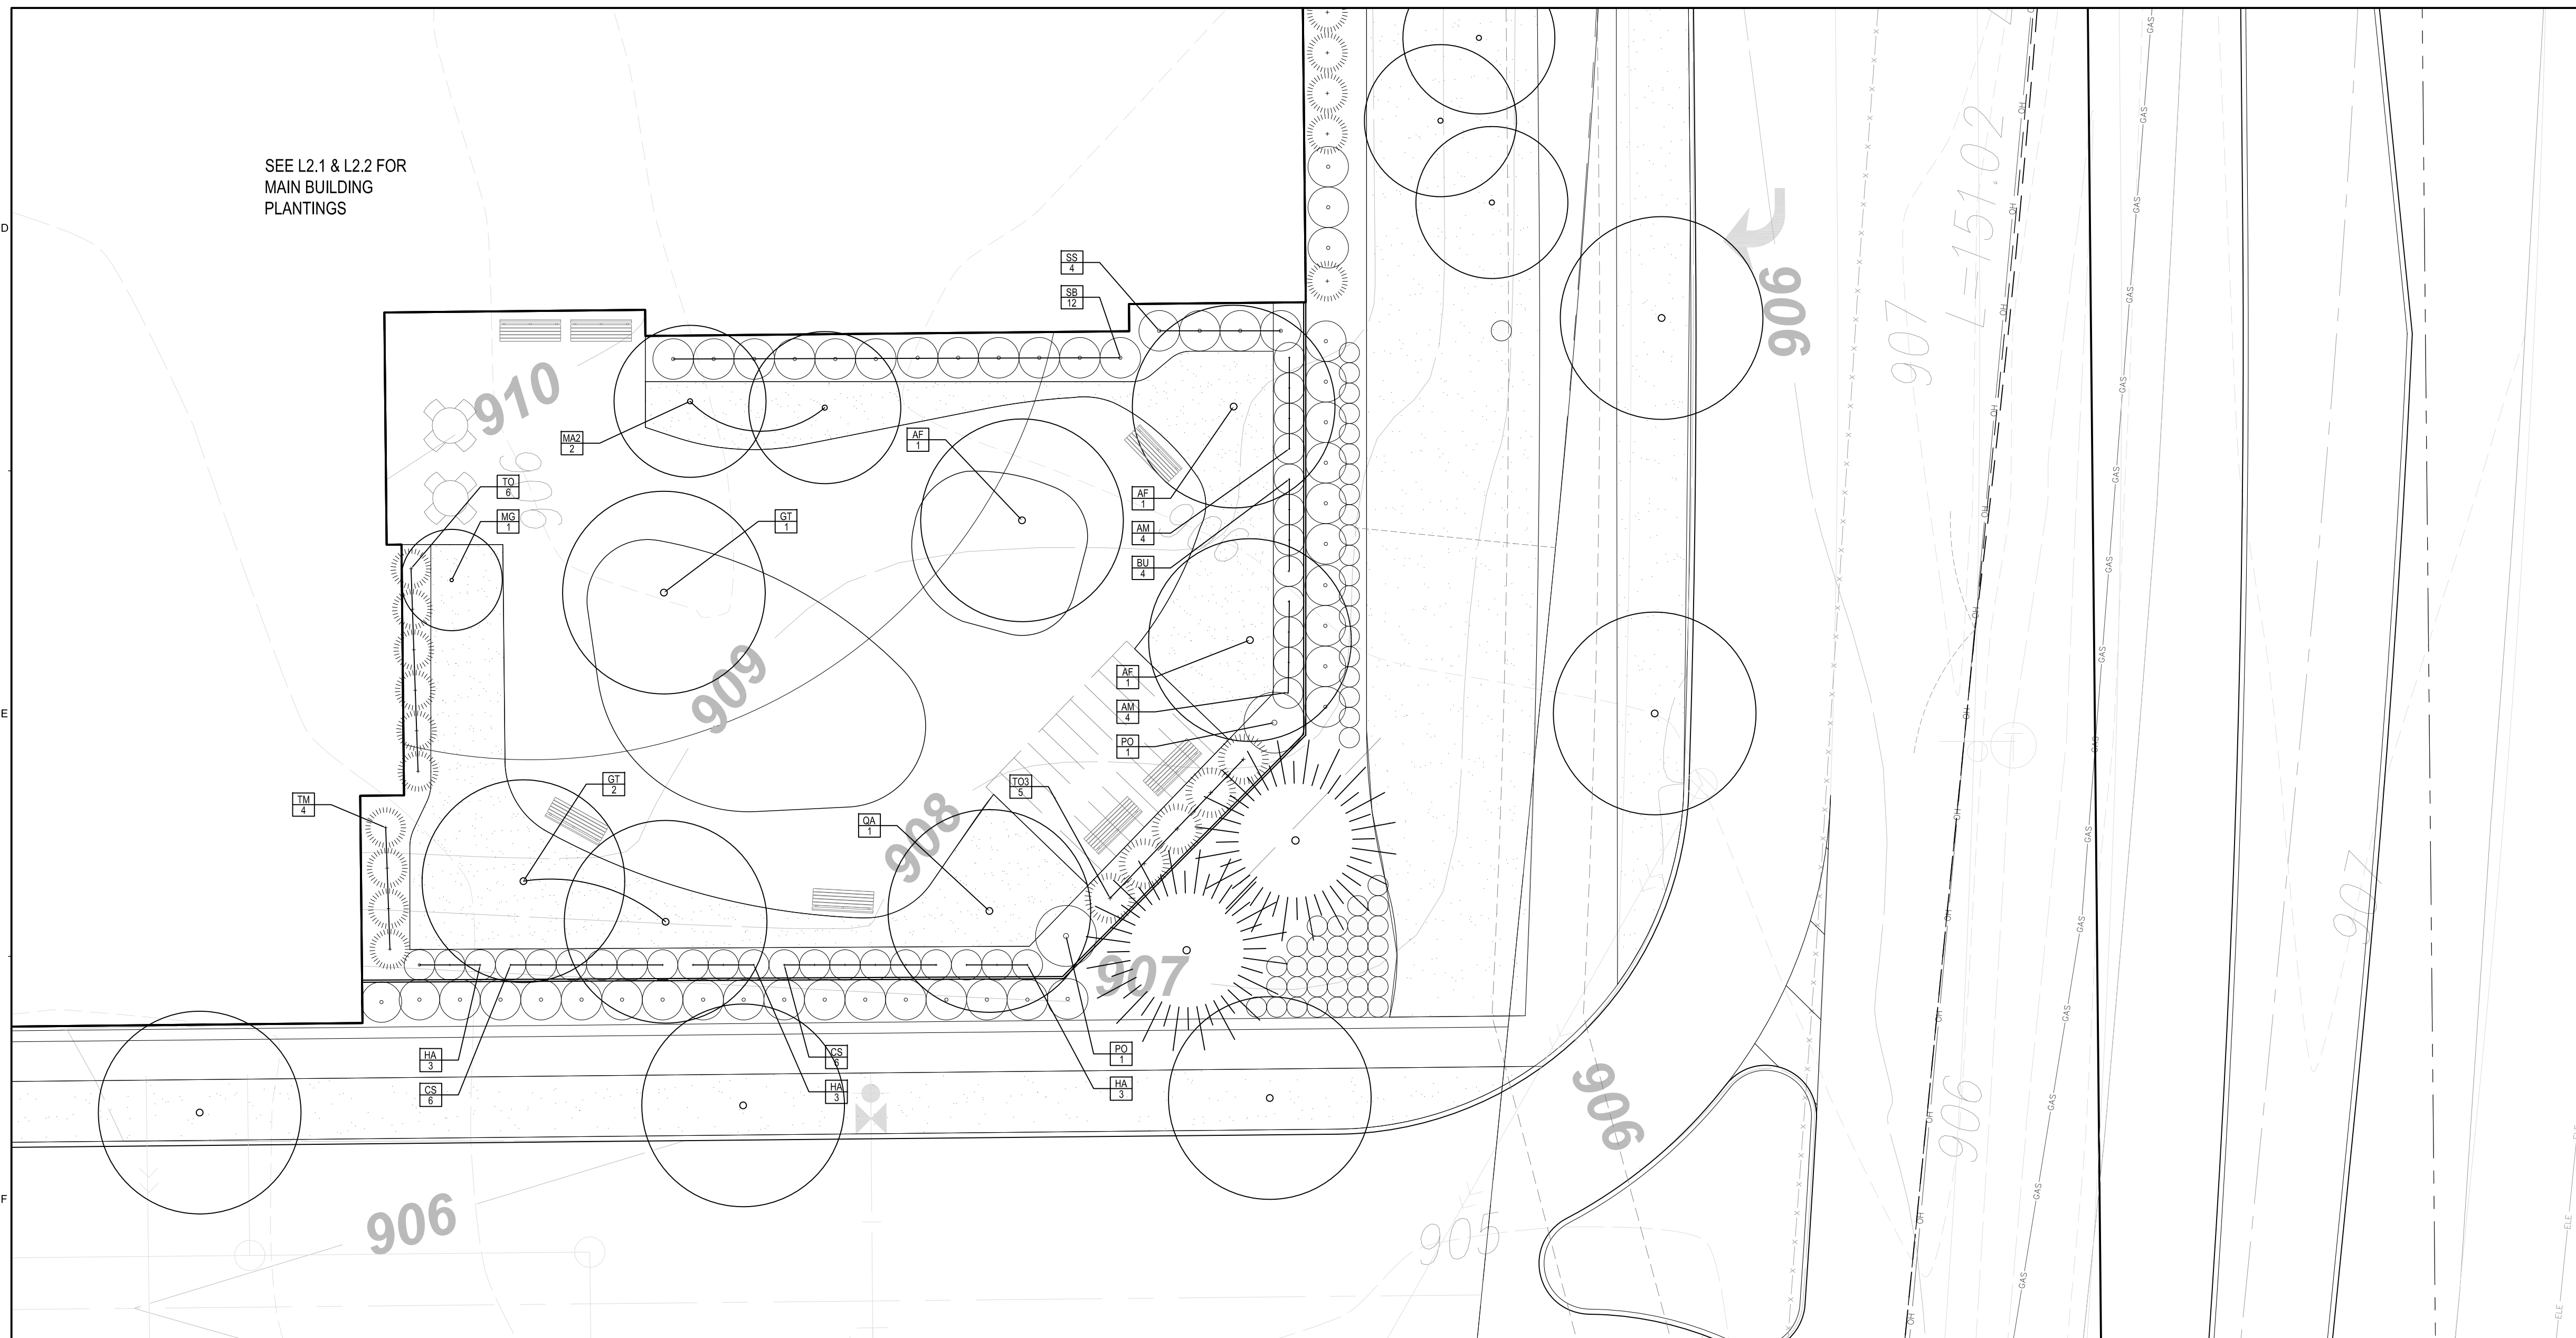

2 MEMORY CARE COURTYARD PLANTING PLAN
1" = 10'

Description	Revision	Date	Num
PUD Submittal		10/08/2018	
PUD Resubmittal		01/14/2019	

Comm: 186624
Date: 01/14/2019
Drawn: _____
Check: _____

**Town Center and
Memory Care
Courtyards
Planting Plans**

Scale: 1" = 10'

L2.3



**WOLD ARCHITECTS
AND ENGINEERS**
332 Minnesota Street, Suite W2000
Saint Paul, MN 55101


woldac.com | 651 227 7773

COLBERG | TEWS
landscape architecture

3151 East Franklin Avenue | Minneapolis, MN 55406
colbergtews.com

L2.4 PLANTING PLAN NOTES

1. REFER TO THE GENERAL NOTES.
2. SEE ARCHITECTURAL AND ELECTRICAL DRAWINGS FOR LIGHTING SELECTIONS AND ELECTRICAL INFORMATION.
3. SEE CIVIL FOR GRADING INFORMATION.
4. SEE SHEET L300 FOR PLANTING NOTES AND DETAILS.
5. SEE SPECIFICATIONS FOR SOILS AND INSTALLATION REQUIREMENTS.
6. SEE CIVIL EXISTING CONDITIONS PLAN FOR BENCHMARKS AND BOUNDARY INFORMATION.
7. SEE ARCHITECTURAL DRAWINGS FOR BUILDING INFORMATION.
8. DO NOT SCALE THE DRAWINGS. WRITTEN DIMENSIONS ARE TO BE USED FOR ALL LAYOUT WORK. IF A NECESSARY DIMENSION IS NOT SHOWN CONTRACTOR SHALL NOTIFY THE LANDSCAPE ARCHITECT AND REQUEST THE INFORMATION PRIOR TO RELATED WORK.
9. AT THE DISCRETION OF THE LANDSCAPE ARCHITECT, ELECTRONIC FILES OR COORDINATES WILL BE PROVIDED TO THE CONTRACTOR FOR SITE LAYOUT/STAKING.
10. FIELD VERIFY ALL MEASUREMENTS AND NOTIFY LANDSCAPE ARCHITECT OF ANY DISCREPANCIES WITH SITE CONDITIONS.
11. CONTRACTOR SHALL IMMEDIATELY NOTIFY THE LANDSCAPE ARCHITECT OF ANY LAYOUT DISCREPANCIES.

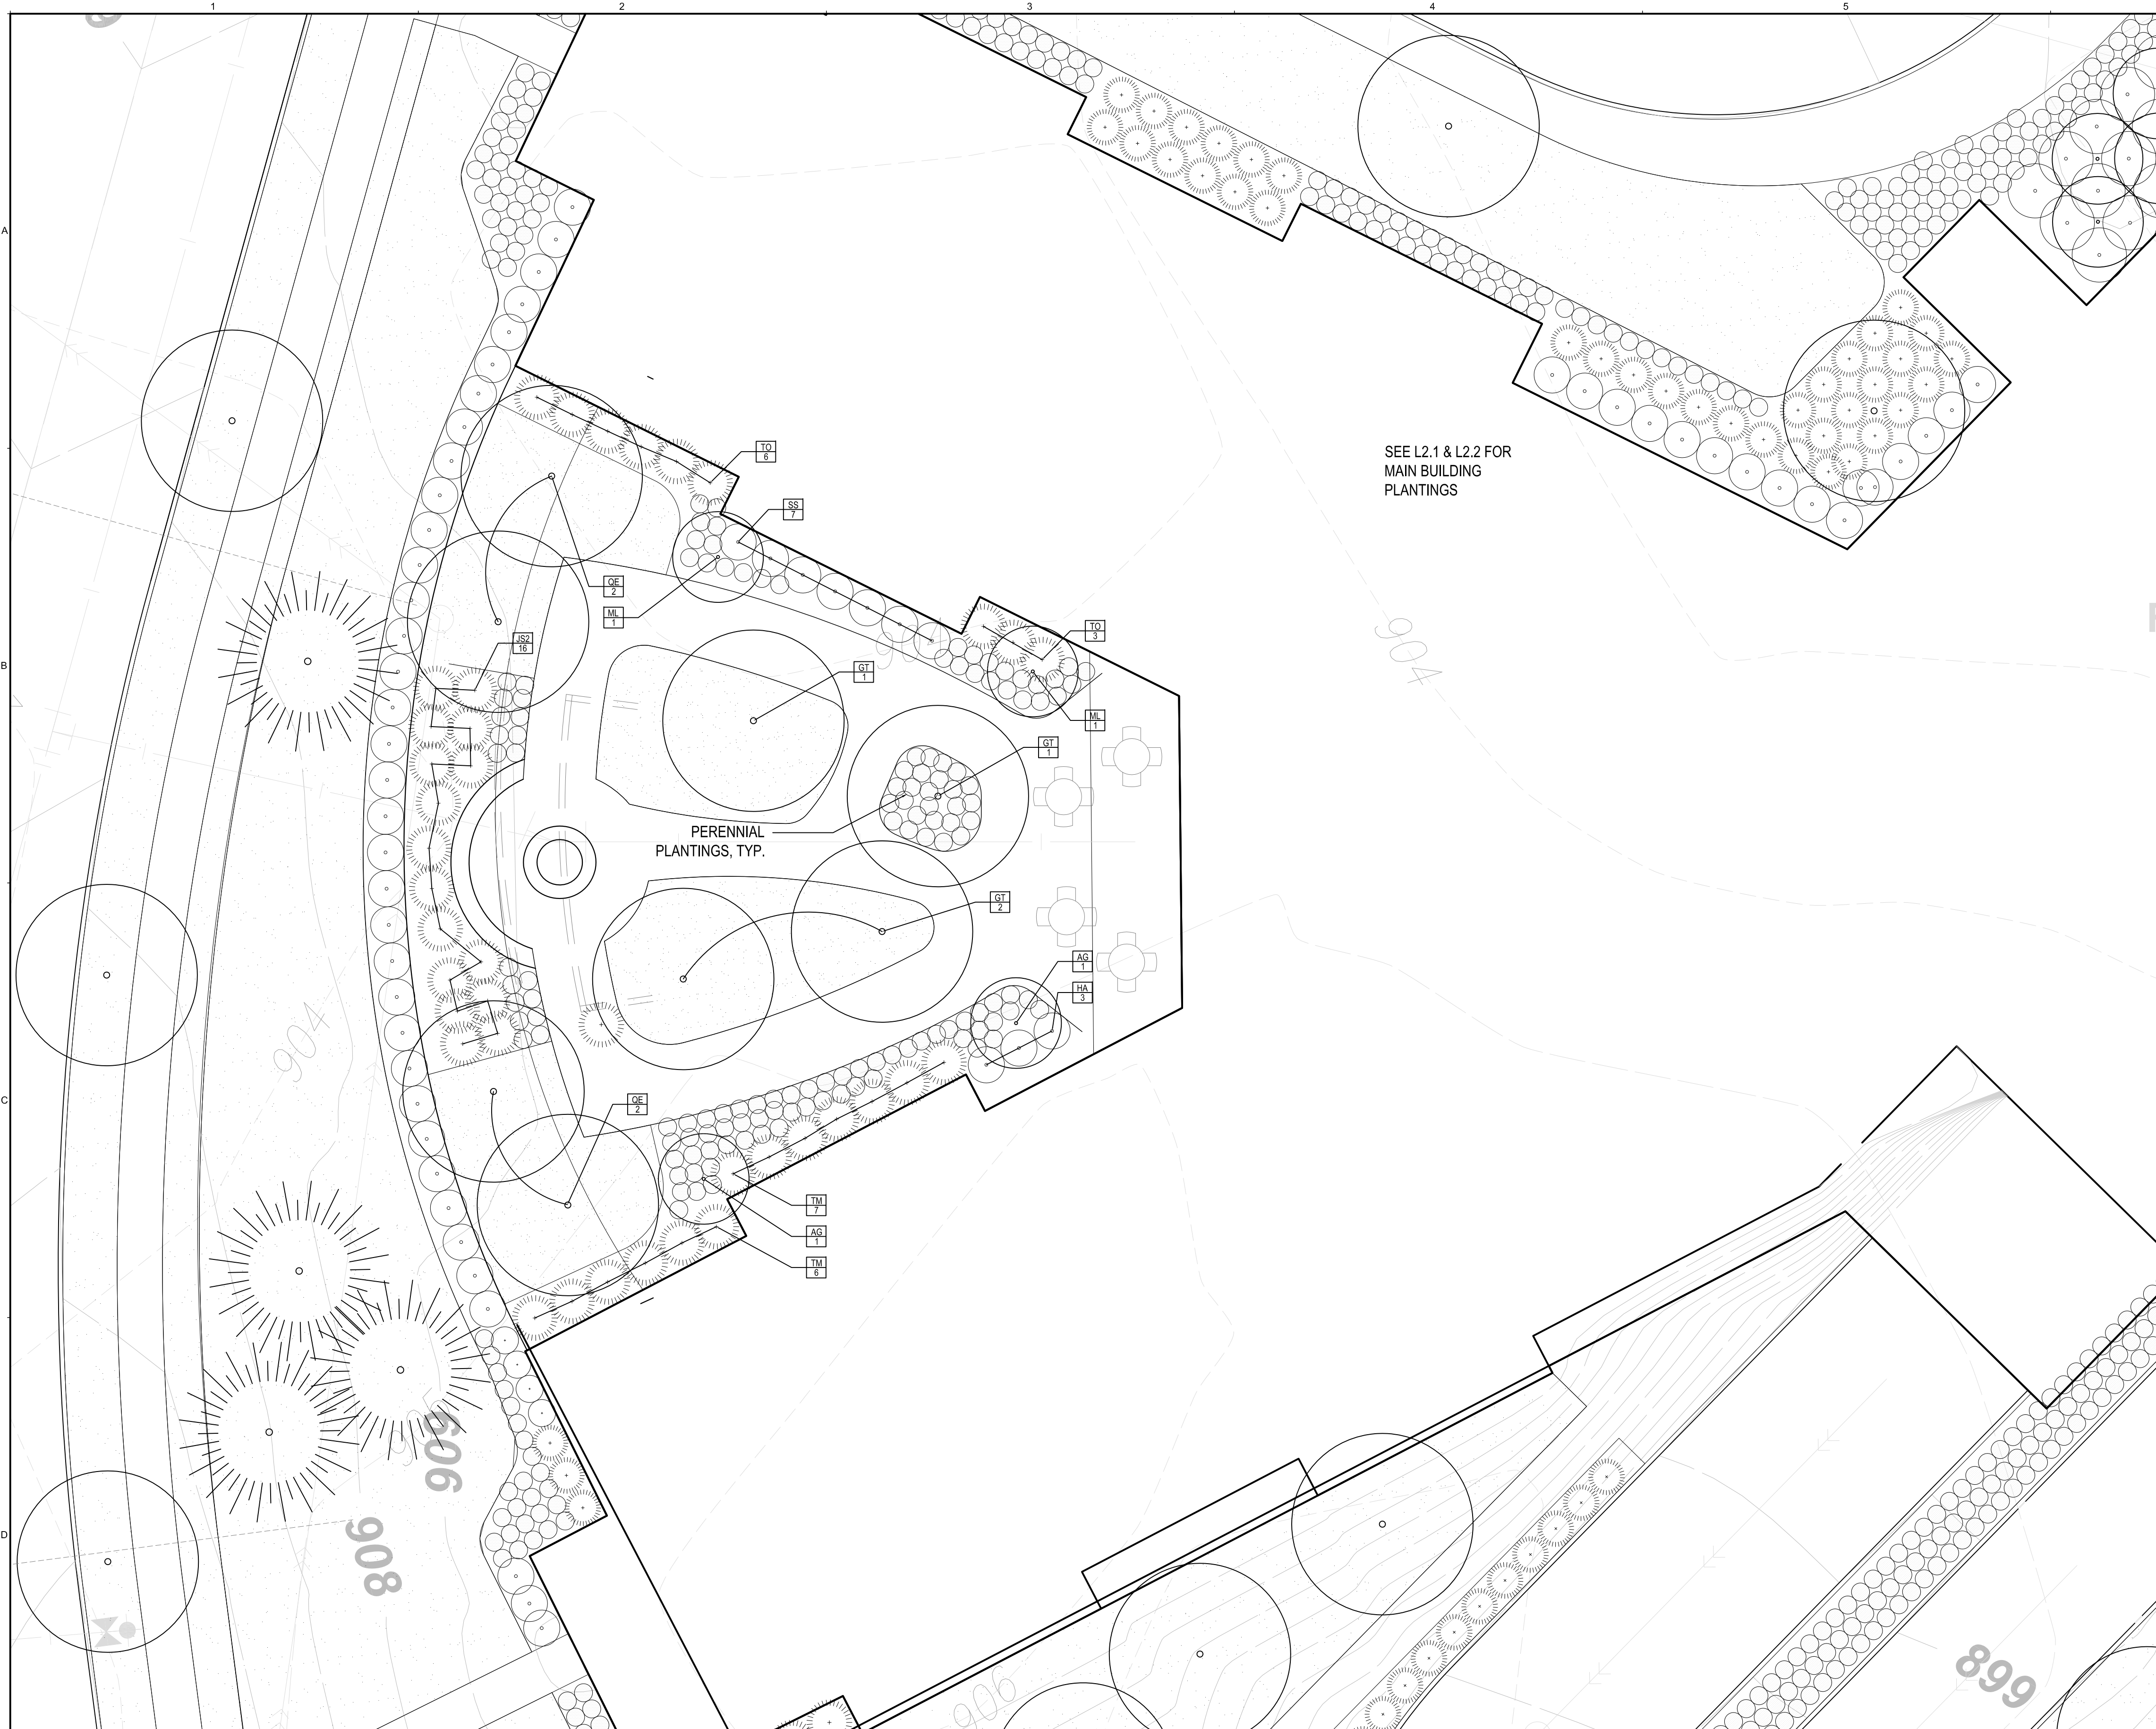


1 SKILLED NURSING COURTYARD PLANTING PLAN
1" = 10'

PLANT SCHEDULE - L2.4

TAG	QTY	COMMON NAME	BOTANICAL NAME	SIZE	NOTES
TREES					
AG	2	AUTUMN BRILLIANCE SERVICEBERRY	AMELANCHIER X GRANDIFLORA 'AUTUMN BRILLIANCE'	8' CLUMP	CLUMP FORM
GT	4	SKYLINE HONEYLOCUST	GLEDITSIA TRIACANTHOS VAR INERMIS 'SKYCOLE'	3" B+B	STRAIGHT LEADER
ML	2	LEONARD MESSEL MAGNOLIA	MAGNOLIA X LOEBNERI 'LEONARD MESSEL'	#10 CLUMP	CLUMP FORM
QE	4	NORTHERN PIN OAK	QUERCUS ELLIPSOIDALIS	3" B+B	STRAIGHT LEADER
SHRUBS					
HA	3	ANNABELLE HYDRANGEA	HYDRANGEA ARBORESCENS 'ANNABELLE'	#5 CONT	SPACING PER PLAN, 4' O.C. TYP.
JS2	16	BLUE ARROW JUNIPER	JUNIPERUS SCOPIULORUM 'BLUE ARROW'	#20 CONT	SPACING PER PLAN, 4' O.C. TYP.
SS	7	ASH LEAF SPIREA	SORBARIA SORBIFOLIA	#5 CONT	SPACING PER PLAN, 4' O.C. TYP.
TM	13	TAUNTON YEW	TAXUS X MEDIA 'TAUNTONII'	#5 CONT.	SPACING PER PLAN, 4' O.C. TYP.
TO	9	MR. BOWLING BALL ARBORVITAE	THUJA OCCIDENTALIS 'BOBAZAM'	#5 CONT	SPACING PER PLAN, 4' O.C. TYP.

Revisions		Num
Description	Date	
PUD Submittal	10/08/2018	
PUD Resubmittal	01/14/2019	


Comm: 186024
Date: 01/14/2019
Drawn: _____
Check: _____

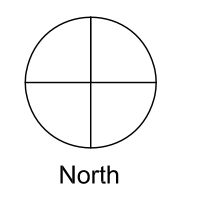

**Skilled Nursing
Courtyard
Planting Plan**

Scale: 1" = 10'

L2.4

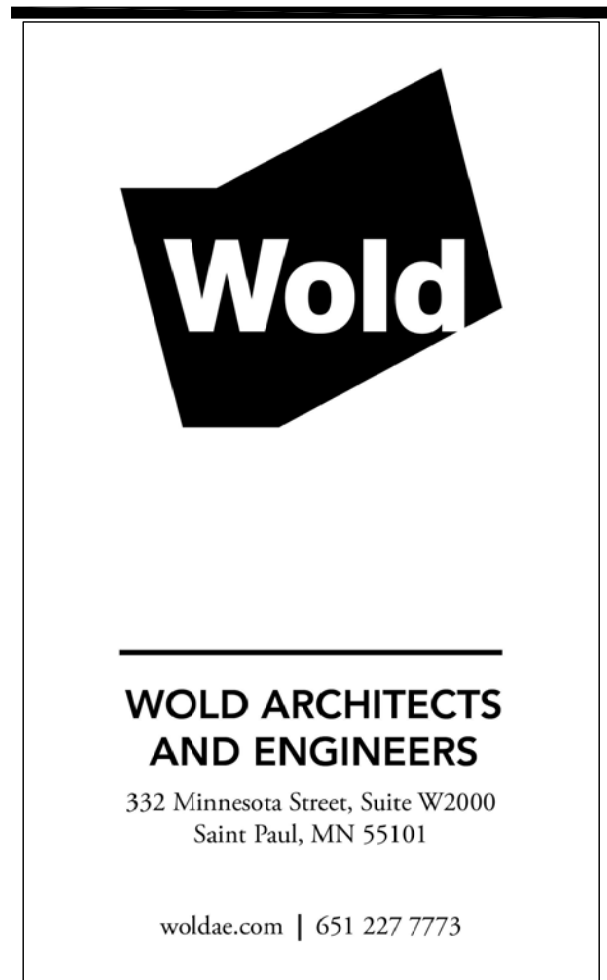

PLANT SCHEDULE - L2.5

TAG	QTY	COMMON NAME	BOTANICAL NAME	SIZE	NOTES
TREES					
AF	2	SIENNA GLEN MAPLE	ACER X FREEMANII 'AUTUMN GLEN'	3" B+B	STRAIGHT LEADER
AG	6	AUTUMN BRILLIANCE SERVICEBERRY	AMELANCHIER X GRANDIFLORA 'AUTUMN BRILLIANCE'	6" B+B	CLUMP FORM
BP	5	WHITESPIRE BIRCH	BETULA PLATYPHYLLA 'WHITESPIRE'	2.5" B+B	STRAIGHT LEADER
CC	3	THORNLESS COCKSPUR HAWTHORN	CRETAEGUS CRUS GALLI VAR. INERMIS	1.5" B+B	TREE FORM
GD	4	ESPRESSO KENTUCKY COFFEETREE	GYMNOCLADUS DIOICUS 'ESPRESSO - JFS'	3" B+B	STRAIGHT LEADER
MA	3	ADAMS CRABAPPLE	MALUS 'ADAMS'	1.5" B+B	TREE FORM
PC	8	CHALET SWISS STONE PINE	PINUS CEMBRA 'CHALET'	6" B+B	
PG	2	BLACK HILLS SPRUCE	PICEA GLAUCA VAR. DENATA	6" B+B	
QA	4	WHITE OAK	QUERCUS ALBA	3" B+B	STRAIGHT LEADER
SR	3	IVORY SILK TREE LILAC	SYRINGA RETICULATA 'IVORY SILK'	2" B+B	TREE FORM
SHRUBS					
AM	10	IROQUOIS BEAUTY CHOKEBERRY	ARONIA MELANOCARPA 'MORTON'	#5 CONT	SPACING PER PLAN, 4' O.C. TYP.
CS	21	ARCTIC FIRE DOGWOOD	CORNUS STOLONIFERA 'FARROW'	#5 CONT	SPACING PER PLAN, 4' O.C. TYP.
DL	79	DWARF BUSH HONEYSUCKLE	DIERVILLA LONICERA	#5 CONT.	SPACING PER PLAN, 4' O.C. TYP.
JS	19	ARCADIA JUNIPER	JUNIPERUS SABINA 'ARCADIA'	#5 CONT	SPACING PER PLAN, 4' O.C. TYP.
SS	14	ASH LEAF SPIREA	SORBARIA SORBIFOLIA	#5 CONT	SPACING PER PLAN, 4' O.C. TYP.
TO	14	MR. BOWLING BALL ARBORVITAE	THUJA OCCIDENTALIS 'BOBAZAM'	#5 CONT	SPACING PER PLAN, 4' O.C. TYP.
TO2	21	GOLDEN GLOBE ARBORVITAE	THUJA OCCIDENTALIS 'GOLDEN GLOBE'	#5 CONT	SPACING PER PLAN, 4' O.C. TYP.

L2.5 PLANTING PLAN NOTES

- REFER TO THE GENERAL NOTES.
- SEE ARCHITECTURAL AND ELECTRICAL DRAWINGS FOR LIGHTING SELECTIONS AND ELECTRICAL INFORMATION.
- SEE CIVIL FOR GRADING INFORMATION.
- SEE SHEET L300 FOR PLANTING NOTES AND DETAILS
- SEE SPECIFICATIONS FOR SOILS AND INSTALLATION REQUIREMENTS.
- SEE CIVIL EXISTING CONDITIONS PLAN FOR BENCHMARKS AND BOUNDARY INFORMATION.
- SEE ARCHITECTURAL DRAWINGS FOR BUILDING INFORMATION.
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- FIELD VERIFY ALL MEASUREMENTS AND NOTIFY LANDSCAPE ARCHITECT OF ANY DISCREPANCIES WITH SITE CONDITIONS.
- CONTRACTOR SHALL IMMEDIATELY NOTIFY THE LANDSCAPE ARCHITECT OF ANY LAYOUT DISCREPANCIES.

L2.5 SOD / SEEDING NOTES:

TOTAL SODDED AREA FOR CLUBHOUSE: 4,738 SF
 TOTAL SEEDED AREA FOR CLUBHOUSE: 3,262 SF

- AREAS TO BE SODDED
- AREAS TO BE SEEDED W/ MNDOT 34-261 - RIPARIAN SEED MIX

CANOPY COVERAGE CALCULATIONS


CLUBHOUSE PARKING LOT	5,866 SF
CANOPY COVERAGE REQUIRED	2,346 SF
6 LG TREES WITHIN 7'	3,600 SF
2 MED. TREES WITHIN 7'	500 SF
TREES WITHIN 7-12" 0 LG. 0 MED.	000 SF
TOTAL CANOPY COVERAGE PROVIDED	3,600 SF

TOTAL FOUNDATION PLANTINGS - CLUBHOUSE


LF FOUNDATION- FRONT AND STREET FACING	73 LF
TREES REQUIRED (LARGE)	1
SHRUBS REQUIRED (LARGE)	4
TREES PROVIDED: 12 MED.	8 LG.
SHRUBS PROVIDED: 84 MEDIUM	56 LG.

OPEN SPACE PLANTINGS - CLUBHOUSE

CLUBHOUSE OPEN SPACE	11,525 SF
TREES REQUIRED (LARGE)	6
SHRUBS REQUIRED (LARGE)	17
TREES PROVIDED: 10 LG. + 9 MED.	16 LG.
SHRUBS PROVIDED: 51 MEDIUM	34 LG.

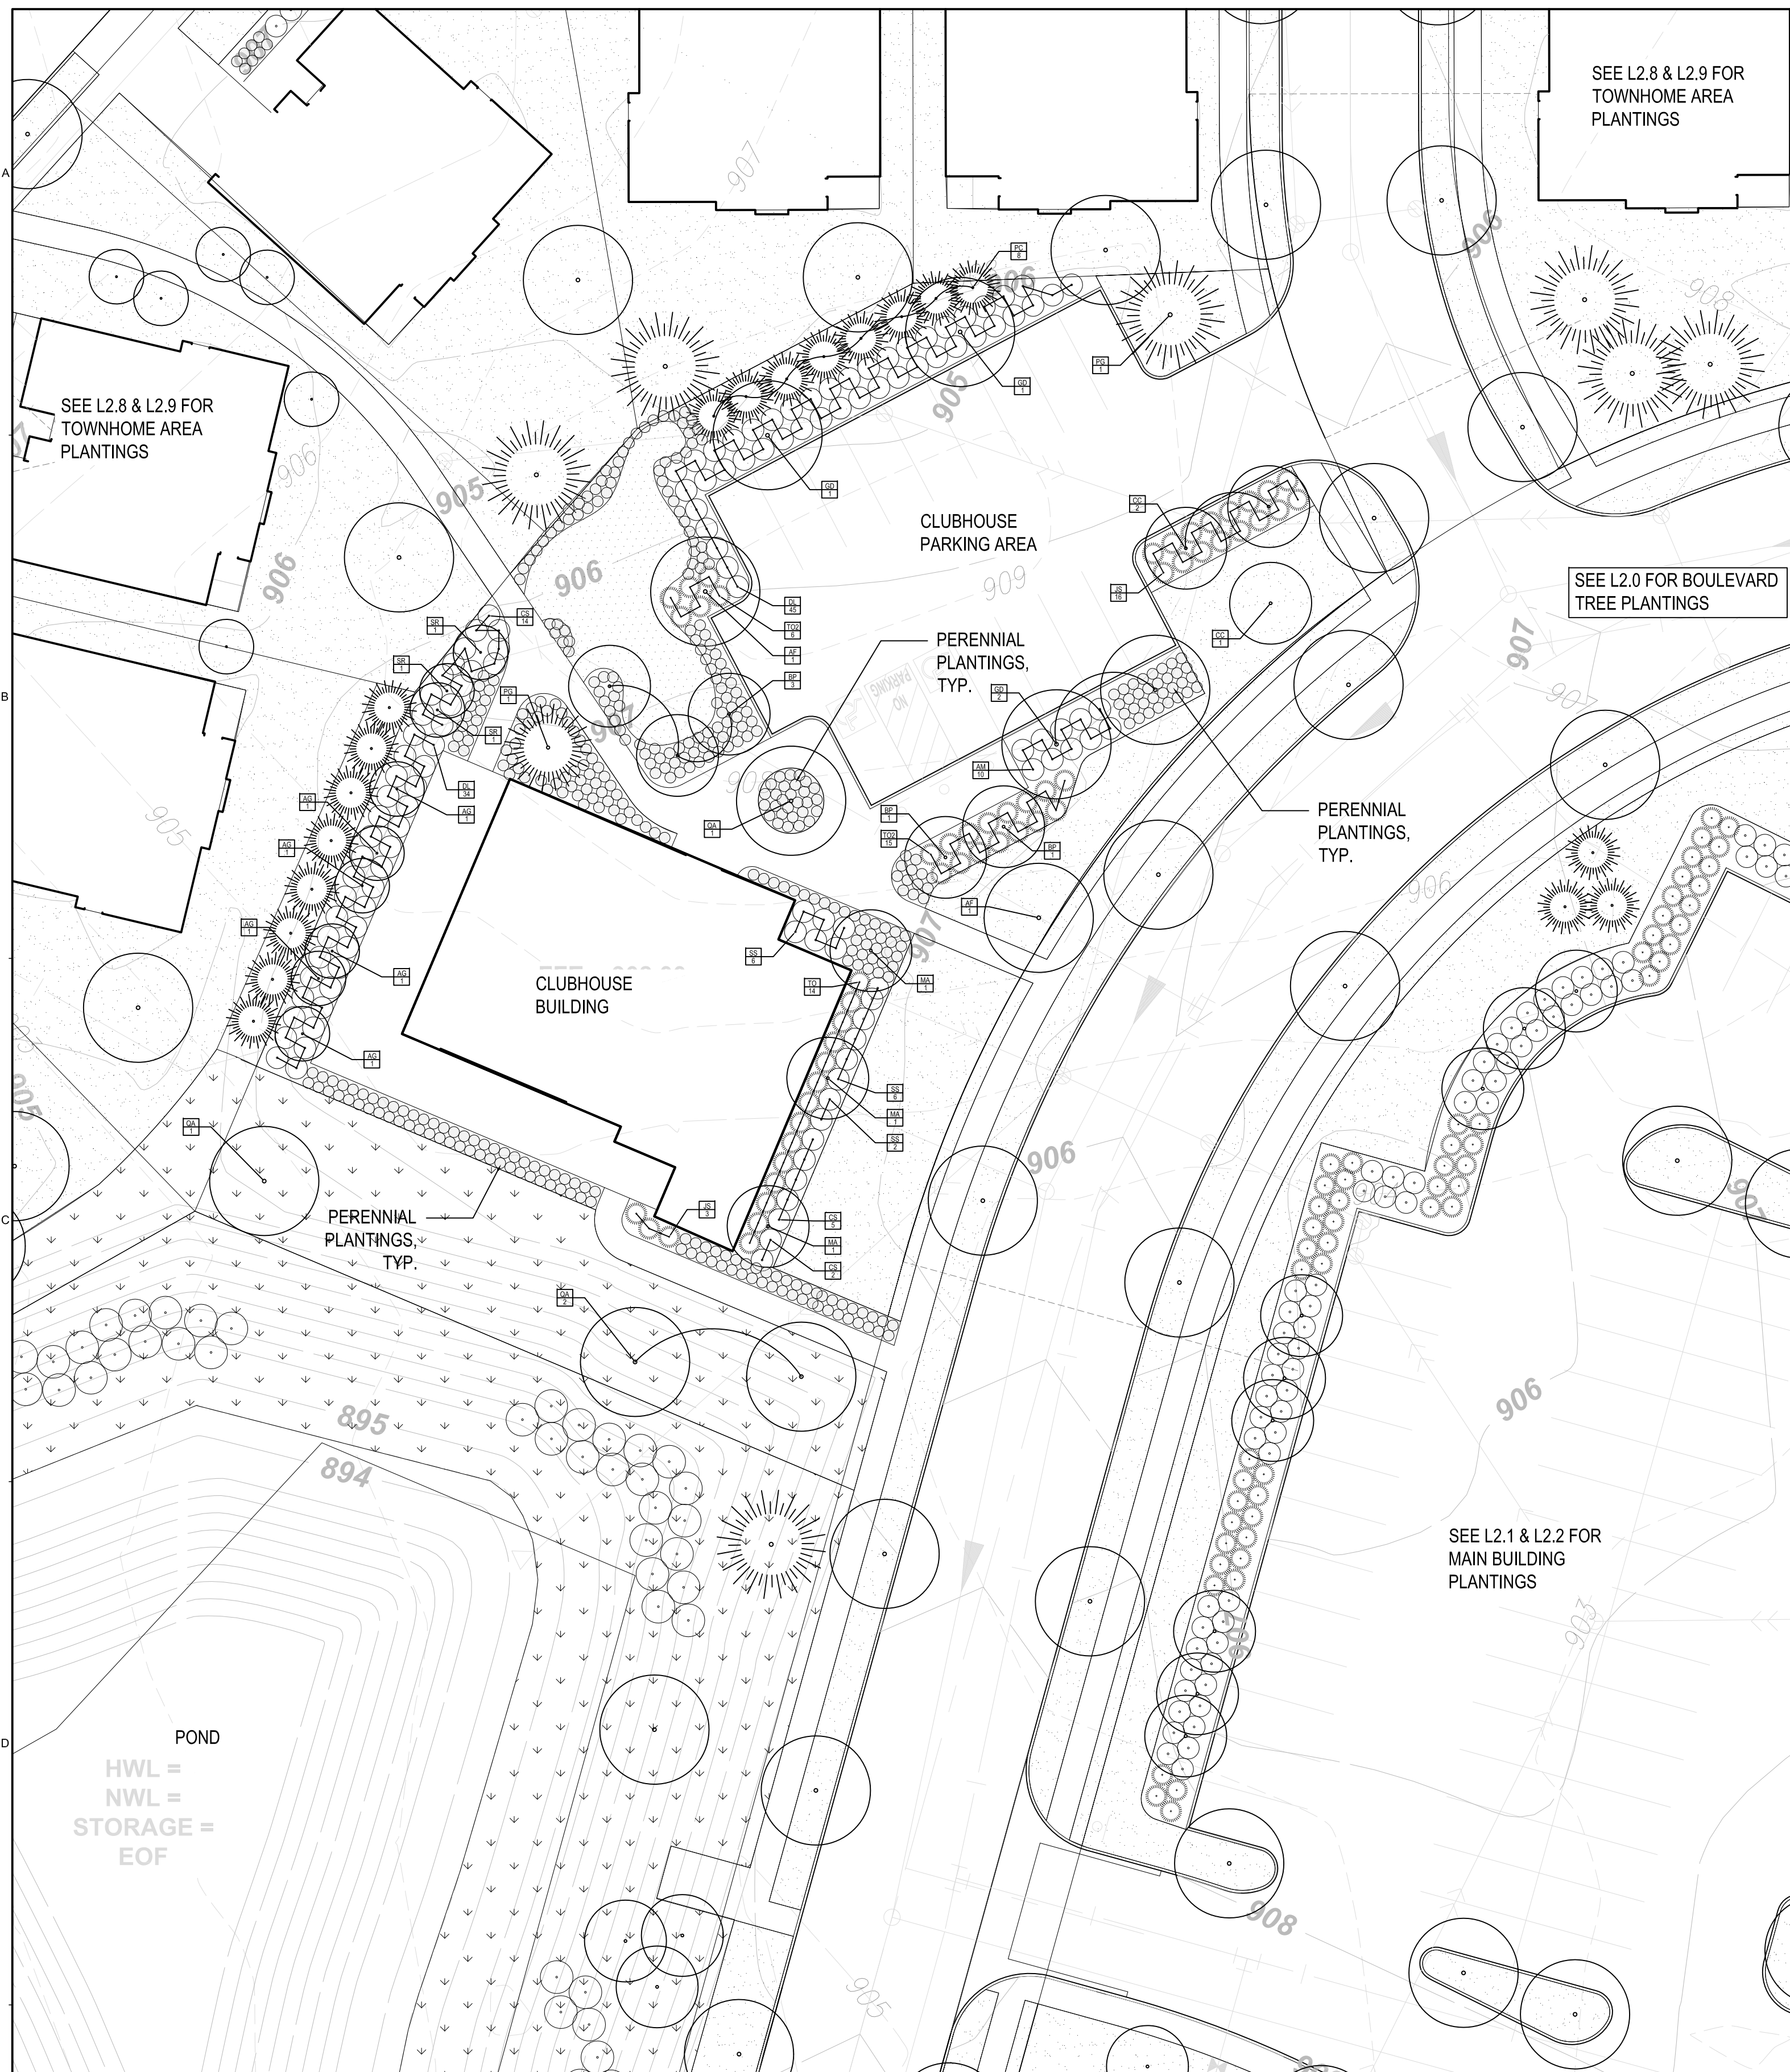


1 CLUBHOUSE PLANTING PLAN
1" = 20'

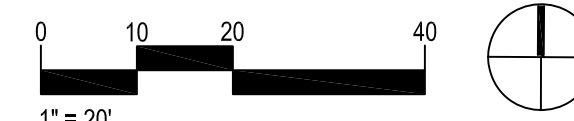

Revisions		
Description	Date	Num
PUD Submittal	10/08/2018	
PUD Resubmittal	01/14/2019	

Comm: 186024
 Date: 01/14/2019
 Drawn: _____
 Check: _____

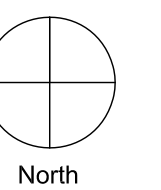

**Clubhouse
Planting Plan**



**WOLD ARCHITECTS
AND ENGINEERS**
332 Minnesota Street, Suite W2000
Saint Paul, MN 55101
woldac.com | 651 227 7773

COLBERG | TEWS
landscape architecture
3111 East Franklin Avenue | Minneapolis, MN 55406
colbergtews.com

L2.7 PLANTING PLAN NOTES

1. REFER TO THE GENERAL NOTES.
2. SEE ARCHITECTURAL AND ELECTRICAL DRAWINGS FOR LIGHTING SELECTIONS AND ELECTRICAL INFORMATION.
3. SEE CIVIL FOR GRADING INFORMATION.
4. SEE SHEET L300 FOR PLANTING NOTES AND DETAILS.
5. SEE SPECIFICATIONS FOR SOILS AND INSTALLATION REQUIREMENTS.
6. SEE CIVIL EXISTING CONDITIONS PLAN FOR BENCHMARKS AND BOUNDARY INFORMATION.
7. SEE ARCHITECTURAL DRAWINGS FOR BUILDING INFORMATION.
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PLANT SCHEDULE - L2.7

TAG	QTY	COMMON NAME	BOTANICAL NAME	SIZE	NOTES
TREES					
JV	8	EASTERN RED CEDAR	JUNIPERUS VIRGINIANA	6' B+B	
PT	6	QUAKING ASPEN	POPULUS TREMULOIDES	2' B+B	
QA	4	WHITE OAK	QUERCUS ALBA	3" B+B	STRAIGHT LEADER
SHRUBS					
CS	44	ISANTI DOGWOOD	CORNUS SERICEA 'ISANTI'	#5 CONT	SPACING PER PLAN, 6' O.C. TYP.
RG	40	SMOOTH SUMAC	RHUS GLABRA	#5 CONT.	SPACING PER PLAN, 6' O.C. TYP.

L2.7 SOD / SEEDING NOTES:

TOTAL SODDED AREA FOR SW GREENSPACE: 0 SF
TOTAL SEEDED AREA FOR SW GREENSPACE: 56,678 SF

- AREAS TO BE SODDED
- AREAS TO BE SEEDED W/ MNDOT 35-241 - MESIC PRAIRIE SEED MIX

OPEN SPACE PLANTINGS - SW GREENSPACE

OPEN SPACE	56,142 SF
TREES REQUIRED (LARGE)	28
SHRUBS REQUIRED (LARGE)	84
TREES PROVIDED: 187 LG (PRESERVED) + 14 LG	36 LG.
SHRUBS PROVIDED:	29 LG.

Description	Revisions		Num
	Date		
PUD Submittal	10/08/2018		
PUD Resubmittal	01/14/2019		

Comm: 186624
Date: 01/14/2019
Drawn: _____
Check: _____
North


**SW Greenspace
Planting Plan**

Scale: SEE DRAWING

L2.7




1 SW GREENSPACE PLANTING PLAN
1" = 20'

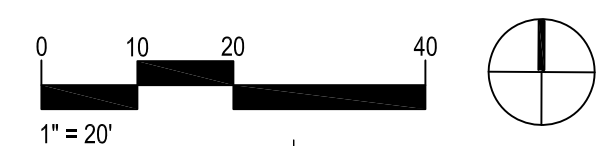

MN


A

CONSULT THE FOLLOWING DRAWINGS FOR INFORMATION: L2.0, L2.1, L2.2, L2.3, L2.4, L2.5, L2.6, L2.8, L2.9, L2.10, L2.11, L2.12, L3.37, 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L16.71, L16.72, L16.73, L16.74, L16.75, L16.76, L16.77, L16.78, L16

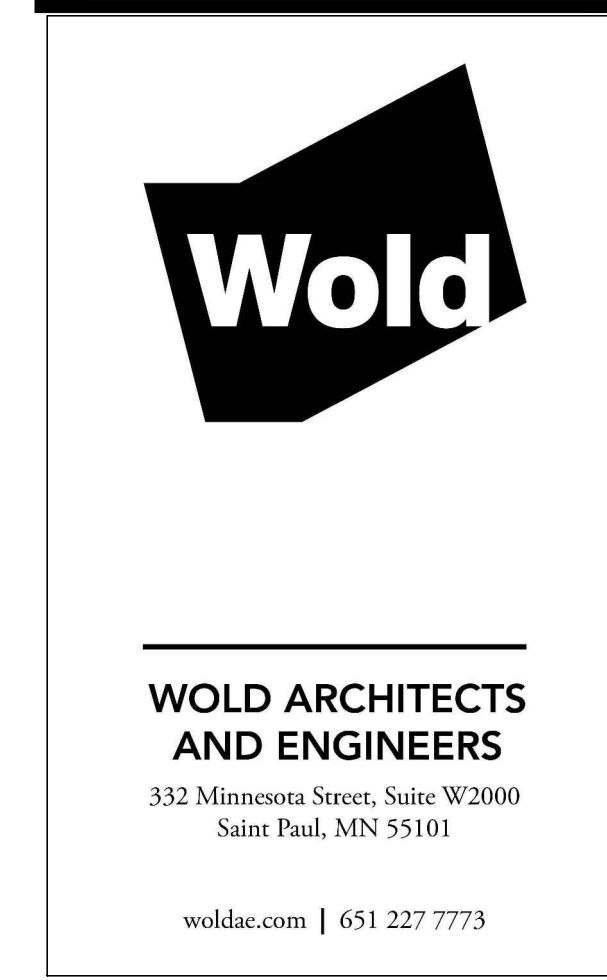

L2.8 PLANTING PLAN NOTES

1. REFER TO THE GENERAL NOTES.
2. SEE ARCHITECTURAL AND ELECTRICAL DRAWINGS FOR LIGHTING SELECTIONS AND ELECTRICAL INFORMATION.
3. SEE CIVIL FOR GRADING INFORMATION.
4. SEE SHEET L300 FOR PLANTING NOTES AND DETAILS.
5. SEE SPECIFICATIONS FOR SOILS AND INSTALLATION REQUIREMENTS.
6. SEE CIVIL EXISTING CONDITIONS PLAN FOR BENCHMARKS AND BOUNDARY INFORMATION.
7. SEE ARCHITECTURAL DRAWINGS FOR BUILDING INFORMATION.
8. DO NOT SCALE THE DRAWINGS. WRITTEN DIMENSIONS ARE TO BE USED FOR ALL LAYOUT WORK. IF A NECESSARY DIMENSION IS NOT SHOWN CONTRACTOR SHALL NOTIFY THE LANDSCAPE ARCHITECT AND REQUEST THE INFORMATION PRIOR TO RELATED WORK.
9. AT THE DISCRETION OF THE LANDSCAPE ARCHITECT, ELECTRONIC FILES OR COORDINATES WILL BE PROVIDED TO THE CONTRACTOR FOR SITE LAYOUT/STAKING.
10. FIELD VERIFY ALL MEASUREMENTS AND NOTIFY LANDSCAPE ARCHITECT OF ANY DISCREPANCIES WITH SITE CONDITIONS.
11. CONTRACTOR SHALL IMMEDIATELY NOTIFY THE LANDSCAPE ARCHITECT OF ANY LAYOUT DISCREPANCIES.

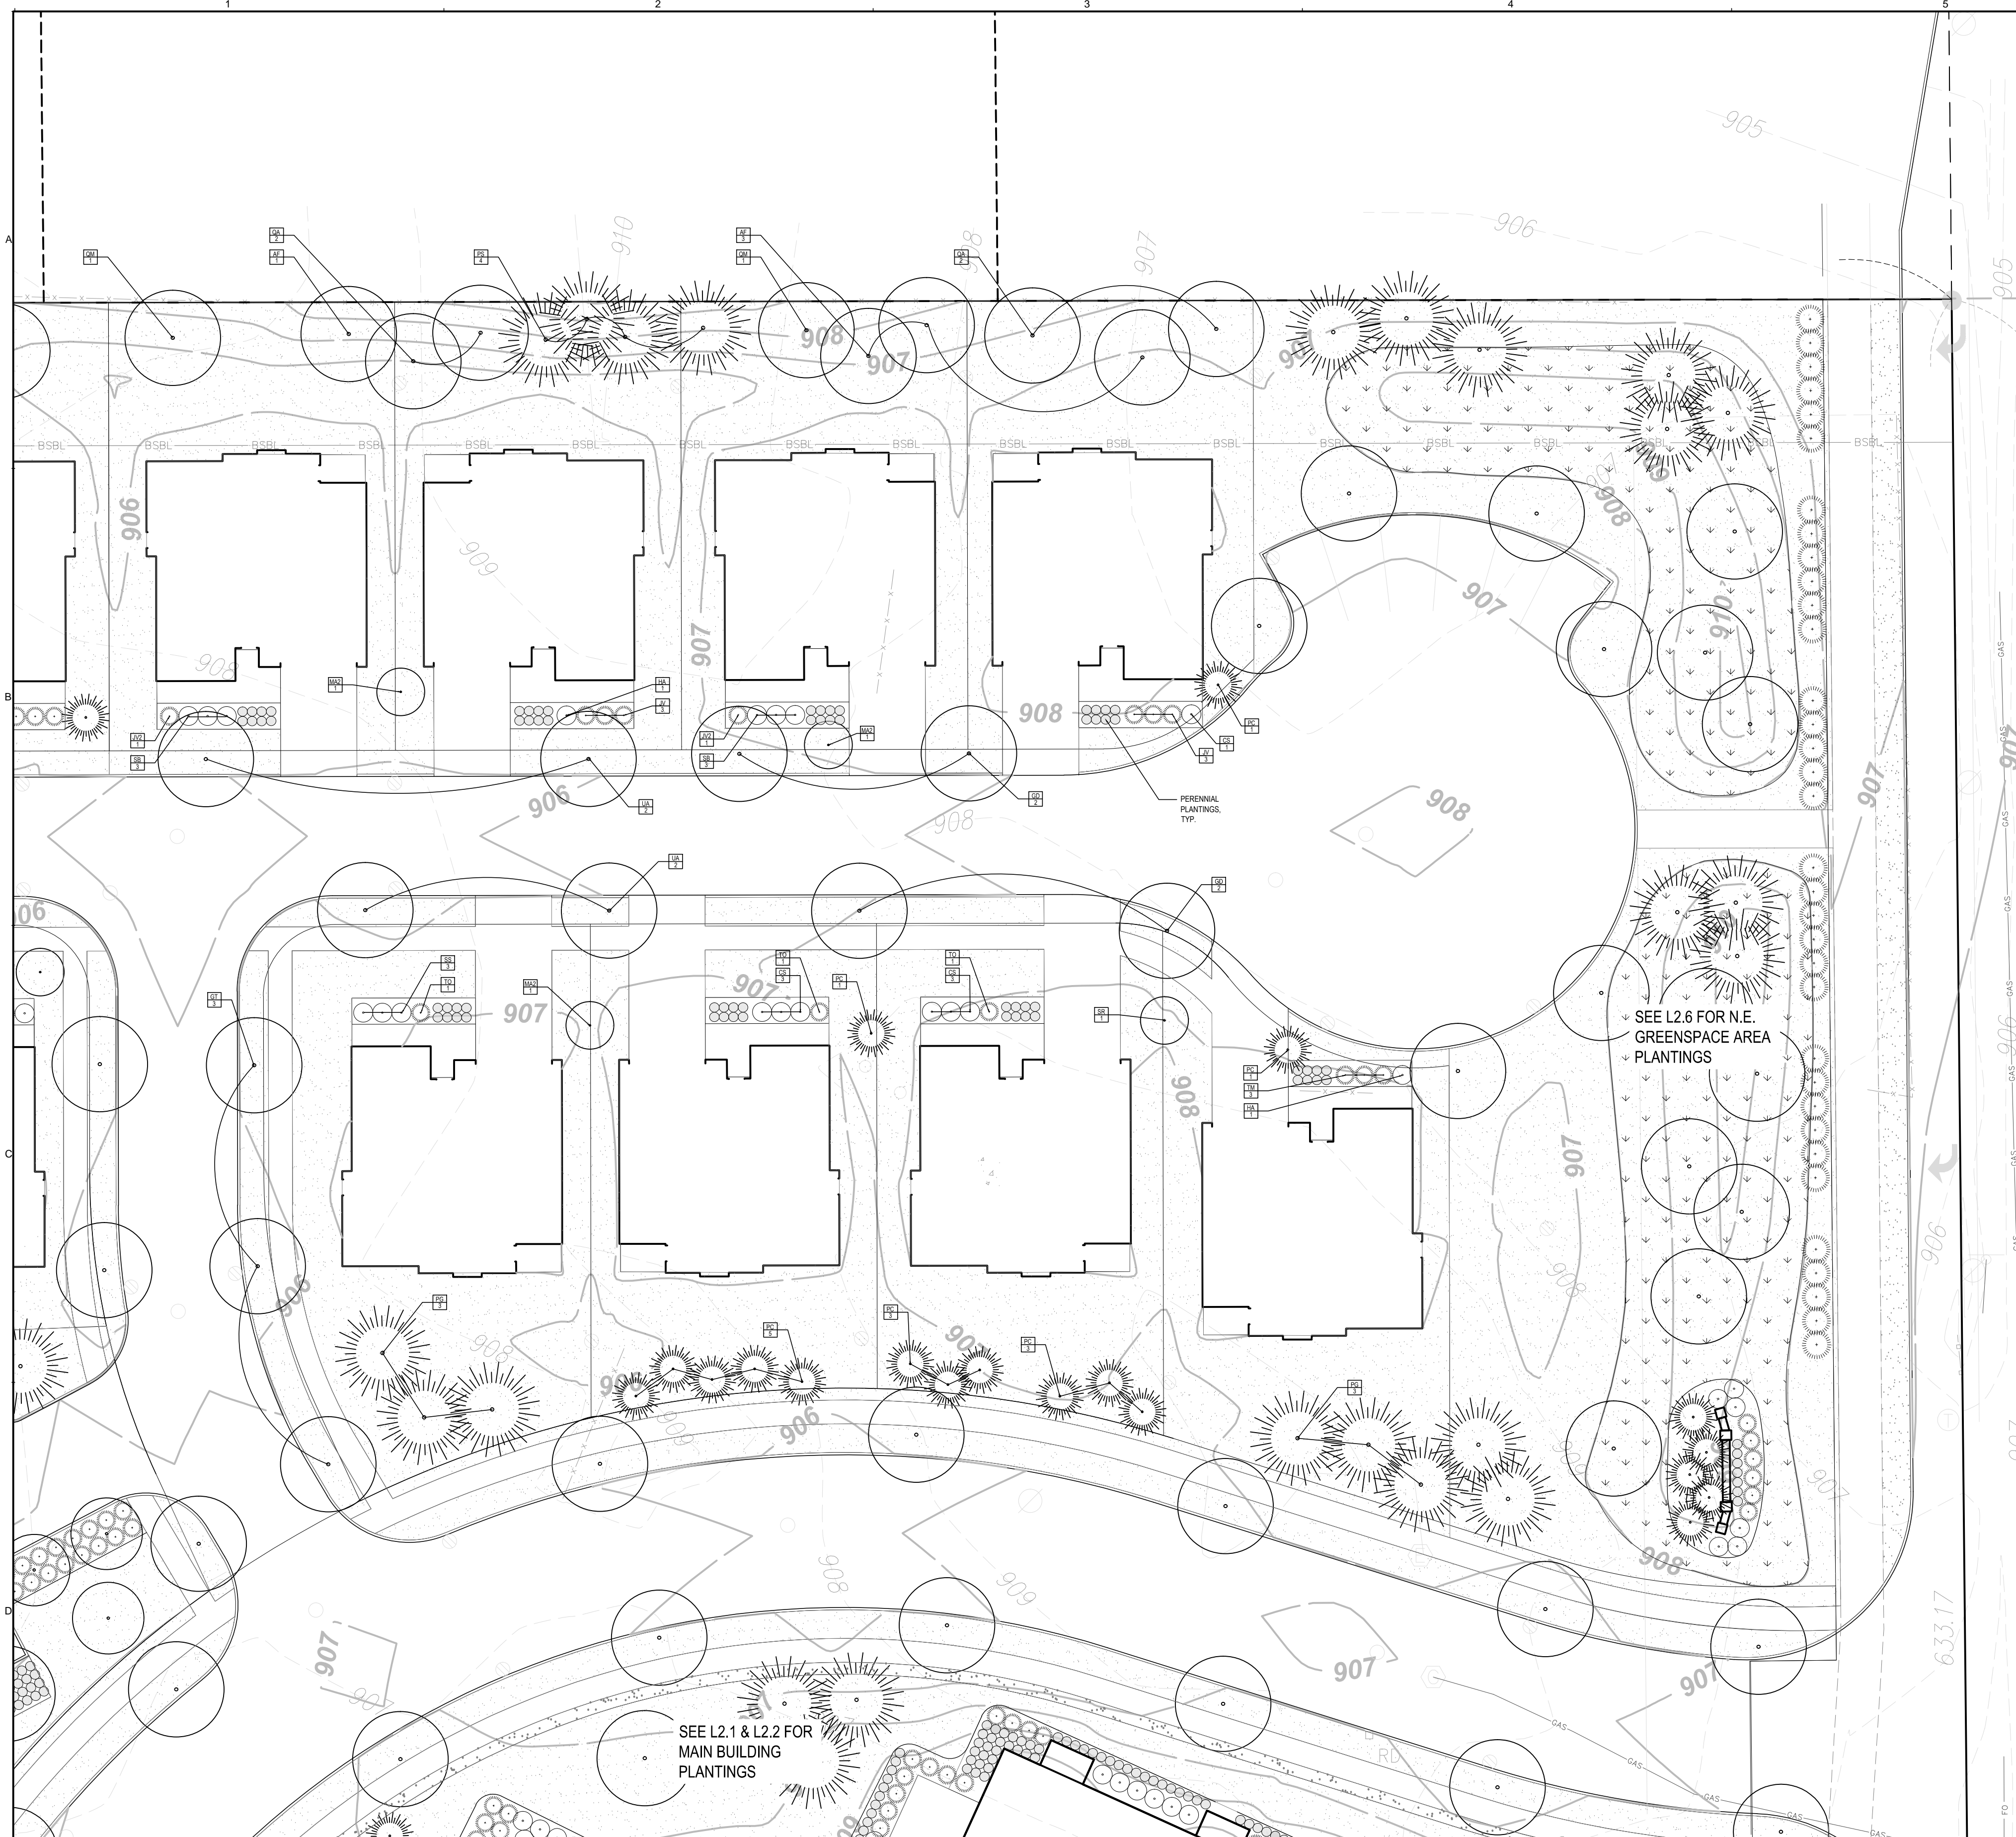

1 EAST TOWNHOMES PLANTING PLAN
1" = 20'



PLANT SCHEDULE - L2.8

TAG	QTY	COMMON NAME	BOTANICAL NAME	SIZE	NOTES
TREES					
AF	4	SIENNA GLEN MAPLE	ACER X FREEMANII 'AUTUMN GLEN'	3" B+B	STRAIGHT LEADER
GD	4	ESPRESSO KENTUCKY COFFEETREE	GYMNOCLADUS DIOICUS 'ESPRESSO-JTF'	3" B+B	
GT	3	SKYLINE HONEYLOCUST	GLEDITSIA TRIACANTHOS VAR INERMIS 'SKYCOLE'	3" B+B	STRAIGHT LEADER
MA2	3	SPRING SNOW CRABAPPLE	MALUS 'SPRING SNOW'	1.5" B+B	TREE FORM
PG	6	BLACK HILLS SPRUCE	PICEA GLAUCA VAR. DENSATA	6" B+B	
PC	14	PRAIRIE STATESMAN SWISS STONE PINE	PINUS CEMBRA 'HERMAN'	6" B+B	STRAIGHT LEADER
PS	4	WHITE PINE	PINUS STROBUS	6" B+B	STRAIGHT LEADER
QA	4	WHITE OAK	QUERCUS ALBA	3" B+B	STRAIGHT LEADER
QM	2	BUR OAK	QUERCUS MACROCARPA	3" B+B	STRAIGHT LEADER
SR	1	IVORY SILK TREE LILAC	SYRINGA RETICULATA 'IVORY SILK'	2" B+B	TREE FORM
UA	4	VALLEY FORGE ELM	ULMUS AMERICANA 'VALLEY FORGE'	3" B+B	DISEASE RESISTANT
SHRUBS					

CS	7	ARCTIC FIRE DOGWOOD	CORNUS STOLONIFERA 'FARROW'	#5 CONT.	SPACING PER PLAN, 4' O.C. TYP.
HA	2	ANNABELLE HYDRANGEA	HYDRANGEA ARBORESCENS 'ANNABELLE'	#5 CONT.	SPACING PER PLAN, 4' O.C. TYP.
JS	6	ARCADIA JUNIPER	JUNIPERUS SABINA 'ARCADIA'	#5 CONT.	SPACING PER PLAN, 4' O.C. TYP.
JV2	2	GREY OWL JUNIPER	JUNIPERUS VIRGINIANA 'GREY OWL'	#5 CONT.	SPACING PER PLAN, 4' O.C. TYP.
SS	3	ASH LEAF SPIREA	SORBARIA SORBIFOLIA	#5 CONT.	SPACING PER PLAN, 4' O.C. TYP.
SB	6	GOLDFLAME SPIREA	SPIREAEA X BUMALDA 'GOLDFLAME'	#5 CONT.	SPACING PER PLAN, 4' O.C. TYP.
TM	3	TAUNTON YEW	TAXUS X MEDIA 'TAUNTONII'	#5 CONT.	SPACING PER PLAN, 4' O.C. TYP.
TO	3	MR. BOWLING BALL ARBORVITAE	THUJA OCCIDENTALIS 'BOBAZAM'	#5 CONT.	SPACING PER PLAN, 4' O.C. TYP.

CANOPY COVERAGE CALCULATIONS	
NORTH PARKING SPACES	1,399 SF
CANOPY COVERAGE REQUIRED	560 SF
2 LG TREES WITHIN 7'	1,200 SF
TOTAL CANOPY COVERAGE PROVIDED	1,200 SF

L2.8 SOD / SEEDING NOTES:
TOTAL SODDED AREA FOR EAST TOWNHOMES: 36,208 SF




Revisions		
Description	Date	Num
PLD Submittal	10/08/2018	
PLD Resubmittal	01/14/2019	

Comm: 186024
Date: 01/14/2019
Drawn: _____
Check: _____
North

East Townhomes Planting Plan

Scale: SEE DRAWING

L2.8

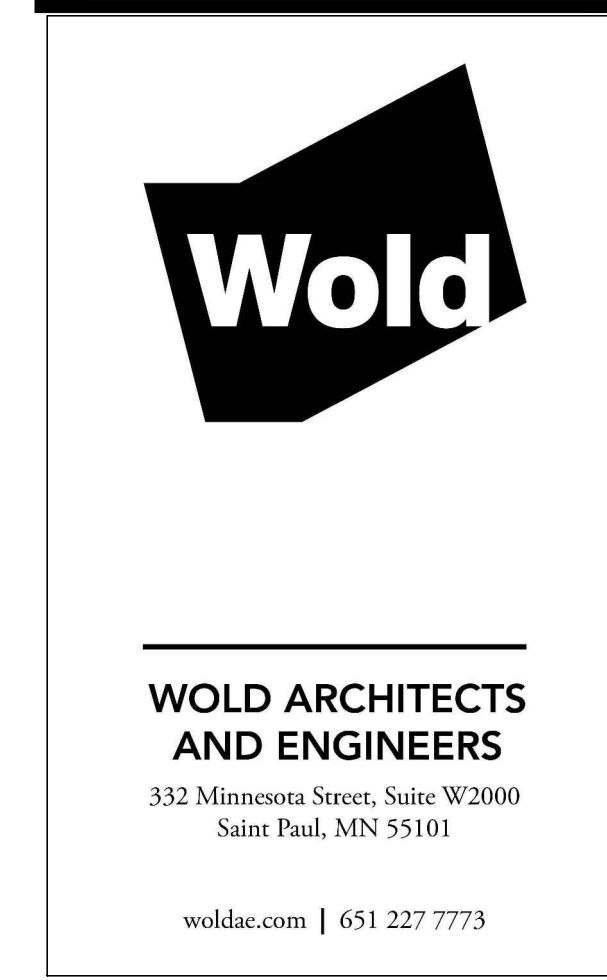

L2.9 PLANTING PLAN NOTES

- REFER TO THE GENERAL NOTES.
- SEE ARCHITECTURAL AND ELECTRICAL DRAWINGS FOR LIGHTING SELECTIONS AND ELECTRICAL INFORMATION.
- SEE CIVIL FOR GRADING INFORMATION.
- SEE SHEET L3.00 FOR PLANTING NOTES AND DETAILS.
- SEE SPECIFICATIONS FOR SOILS AND INSTALLATION REQUIREMENTS.
- SEE CIVIL EXISTING CONDITIONS PLAN FOR BENCHMARKS AND BOUNDARY INFORMATION.
- SEE ARCHITECTURAL DRAWINGS FOR BUILDING INFORMATION.
- DO NOT SCALE THE DRAWINGS. WRITTEN DIMENSIONS ARE TO BE USED FOR ALL LAYOUT WORK. IF A NECESSARY DIMENSION IS NOT SHOWN CONTRACTOR SHALL NOTIFY THE LANDSCAPE ARCHITECT AND REQUEST THE INFORMATION PRIOR TO RELATED WORK.
- AT THE DISCRETION OF THE LANDSCAPE ARCHITECT, ELECTRONIC FILES OR COORDINATES WILL BE PROVIDED TO THE CONTRACTOR FOR SITE LAYOUT/STAKING.
- FIELD VERIFY ALL MEASUREMENTS AND NOTIFY LANDSCAPE ARCHITECT OF ANY DISCREPANCIES WITH SITE CONDITIONS.
- CONTRACTOR SHALL IMMEDIATELY NOTIFY THE LANDSCAPE ARCHITECT OF ANY LAYOUT DISCREPANCIES.

PLANT SCHEDULE - L2.9

TAG	QTY	COMMON NAME	BOTANICAL NAME	SIZE	NOTES
TREES					
AF	3	SIENNA GLEN MAPLE	ACER X FREEMANII 'AUTUMN GLEN'	3" B+B	STRAIGHT LEADER
AL	5	ALLEGHENY SERVICEBERRY	AMELANCHIER LAEVIS	1.5" B+B	TREE FORM MULTISTEM
CC	3	THORNLESS COCKSPUR HAWTHORN	CRETAEGUS CRUS GALLI VAR. INERMIS	1.5" B+B	TREE FORM
GD	8	ESPRESSO KENTUCKY COFFEETREE	GYMNOCLADUS DIOICUS 'ESPRESSO-JFS'	3" B+B	
GT	11	SKYLINE HONEYLOCUST	GLEDITSIA TRIACANTHOS VAR. INERMIS 'SKYCOLE'	3" B+B	
MA	2	ADAMS CRABAPPLE	MALUS 'ADAMS'	1.5" B+B	TREE FORM
MA2	5	SPRING SNOW CRABAPPLE	MALUS 'SPRING SNOW'	1.5" B+B	TREE FORM
PC	4	PRAIRIE STATESMAN SWISS STONE PINE	PINUS CEMBRA 'HERMAN'	6" B+B	STRAIGHT LEADER
PG	2	BLACK HILLS SPRUCE	PICEA GLAUCA 'DENSATA'	6" B+B	
PR	4	RED PINE	PINUS RESINOSA	6" B+B	
PS	3	WHITE PINE	PINUS STROBUS	6" B+B	
QA	6	WHITE OAK	QUERCUS ALBA	2.5" B+B	
QE	4	NORTHERN PIN OAK	QUERCUS ELLIPSOIDALIS	2.5" B+B	DO NOT USE QUERCUS PALUSTRIS
QM	3	BUR OAK	QUERCUS MACROCARPA	2.5" B+B	
SR	1	IVORY SILK TREE LILAC	SYRINGA RETICULATA 'IVORY SILK'	2" B+B	TREE FORM
UA	2	VALLEY FORGE ELM	ULMUS AMERICANA 'VALLEY FORGE'	3" B+B	DISEASE RESISTANT
SHRUBS					
AM	3	IRIQUOIS BEAUTY CHOKEBERRY	ARONIA MELANOCARPA 'MORTON'	#5 CONT.	SPACING PER PLAN, 4' O.C. TYP.
CS	7	ARCTIC FIRE DOGWOOD	CORNUS STOLONIFERA 'FARROW'	#5 CONT.	SPACING PER PLAN, 4' O.C. TYP.
DL	3	DWARF BUSH HONEYSUCKLE	DIERVILLA LONICERA	#5 CONT.	SPACING PER PLAN, 4' O.C. TYP.
HA	7	ANNABELLE HYDRANGEA	HYDRANGEA ARBORESCENS 'ANNABELLE'	#5 CONT.	SPACING PER PLAN, 4' O.C. TYP.
JS	8	ARCADIA JUNIPER	JUNIPERUS SABINA 'ARCADIA'	#5 CONT.	SPACING PER PLAN, 4' O.C. TYP.
JV2	4	GREY OWL JUNIPER	JUNIPERUS VIRGINIANA 'GREY OWL'	#5 CONT.	SPACING PER PLAN, 4' O.C. TYP.
SB	4	GOLDFLAME SPIREA	SPIRAEA X BUMALDA 'GOLDFLAME'	#5 CONT.	SPACING PER PLAN, 4' O.C. TYP.
TM	8	TAUNTON YEW	TAXUS X MEDIA 'TAUNTONII'	#5 CONT.	SPACING PER PLAN, 4' O.C. TYP.
TO	1	MR. BOWLING BALL ARBORVITAE	THUJA OCCIDENTALIS 'BOBAZAM'	#5 CONT.	SPACING PER PLAN, 4' O.C. TYP.
TO2	2	GOLDEN GLOBE ARBORVITAE	THUJA OCCIDENTALIS 'GOLDEN GLOBE'	#5 CONT.	SPACING PER PLAN, 4' O.C. TYP.

L2.9 SOD / SEEDING NOTES:

TOTAL SODDED AREA FOR WEST TOWNHOMES: 39,576 SF
 TOTAL SEEDED AREA FOR WEST TOWNHOMES: 21,361 SF

- AREAS TO BE SODDED
- AREAS TO BE SEEDED W/ MNDOT 35-241 - MESIC PRAIRIE SEED MIX

CANOPY COVERAGE CALCULATIONS

WEST TOWNHOME PARKING SPACES	929 SF
CANOPY COVERAGE REQUIRED	372 SF
1 LG TREES WITHIN 7'	600 SF
TOTAL CANOPY COVERAGE PROVIDED	600 SF

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 North

West Townhomes Planting Plan



**LYNGBLOMSTEN
SENIOR
COMMUNITIES**

HODGSON ROAD
LINO LAKES, MN 55014

LYNGBLOMSTEN


1415 ALMOND AVE W
ST. PAUL, MN 55108




**WOLD ARCHITECTS
AND ENGINEERS**

332 Minnesota Street, Suite W2000
Saint Paul, MN 55101

woldae.com | 651.227.7773

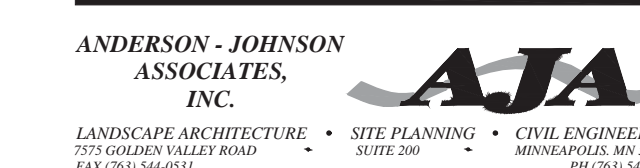

LANDSCAPE ARCHITECTURE • SITE PLANNING • CIVIL ENGINEERING
307 GARDEN VALLEY DRIVE • MINNETONKA, MN 55120
P&L 01/14/14 12/15

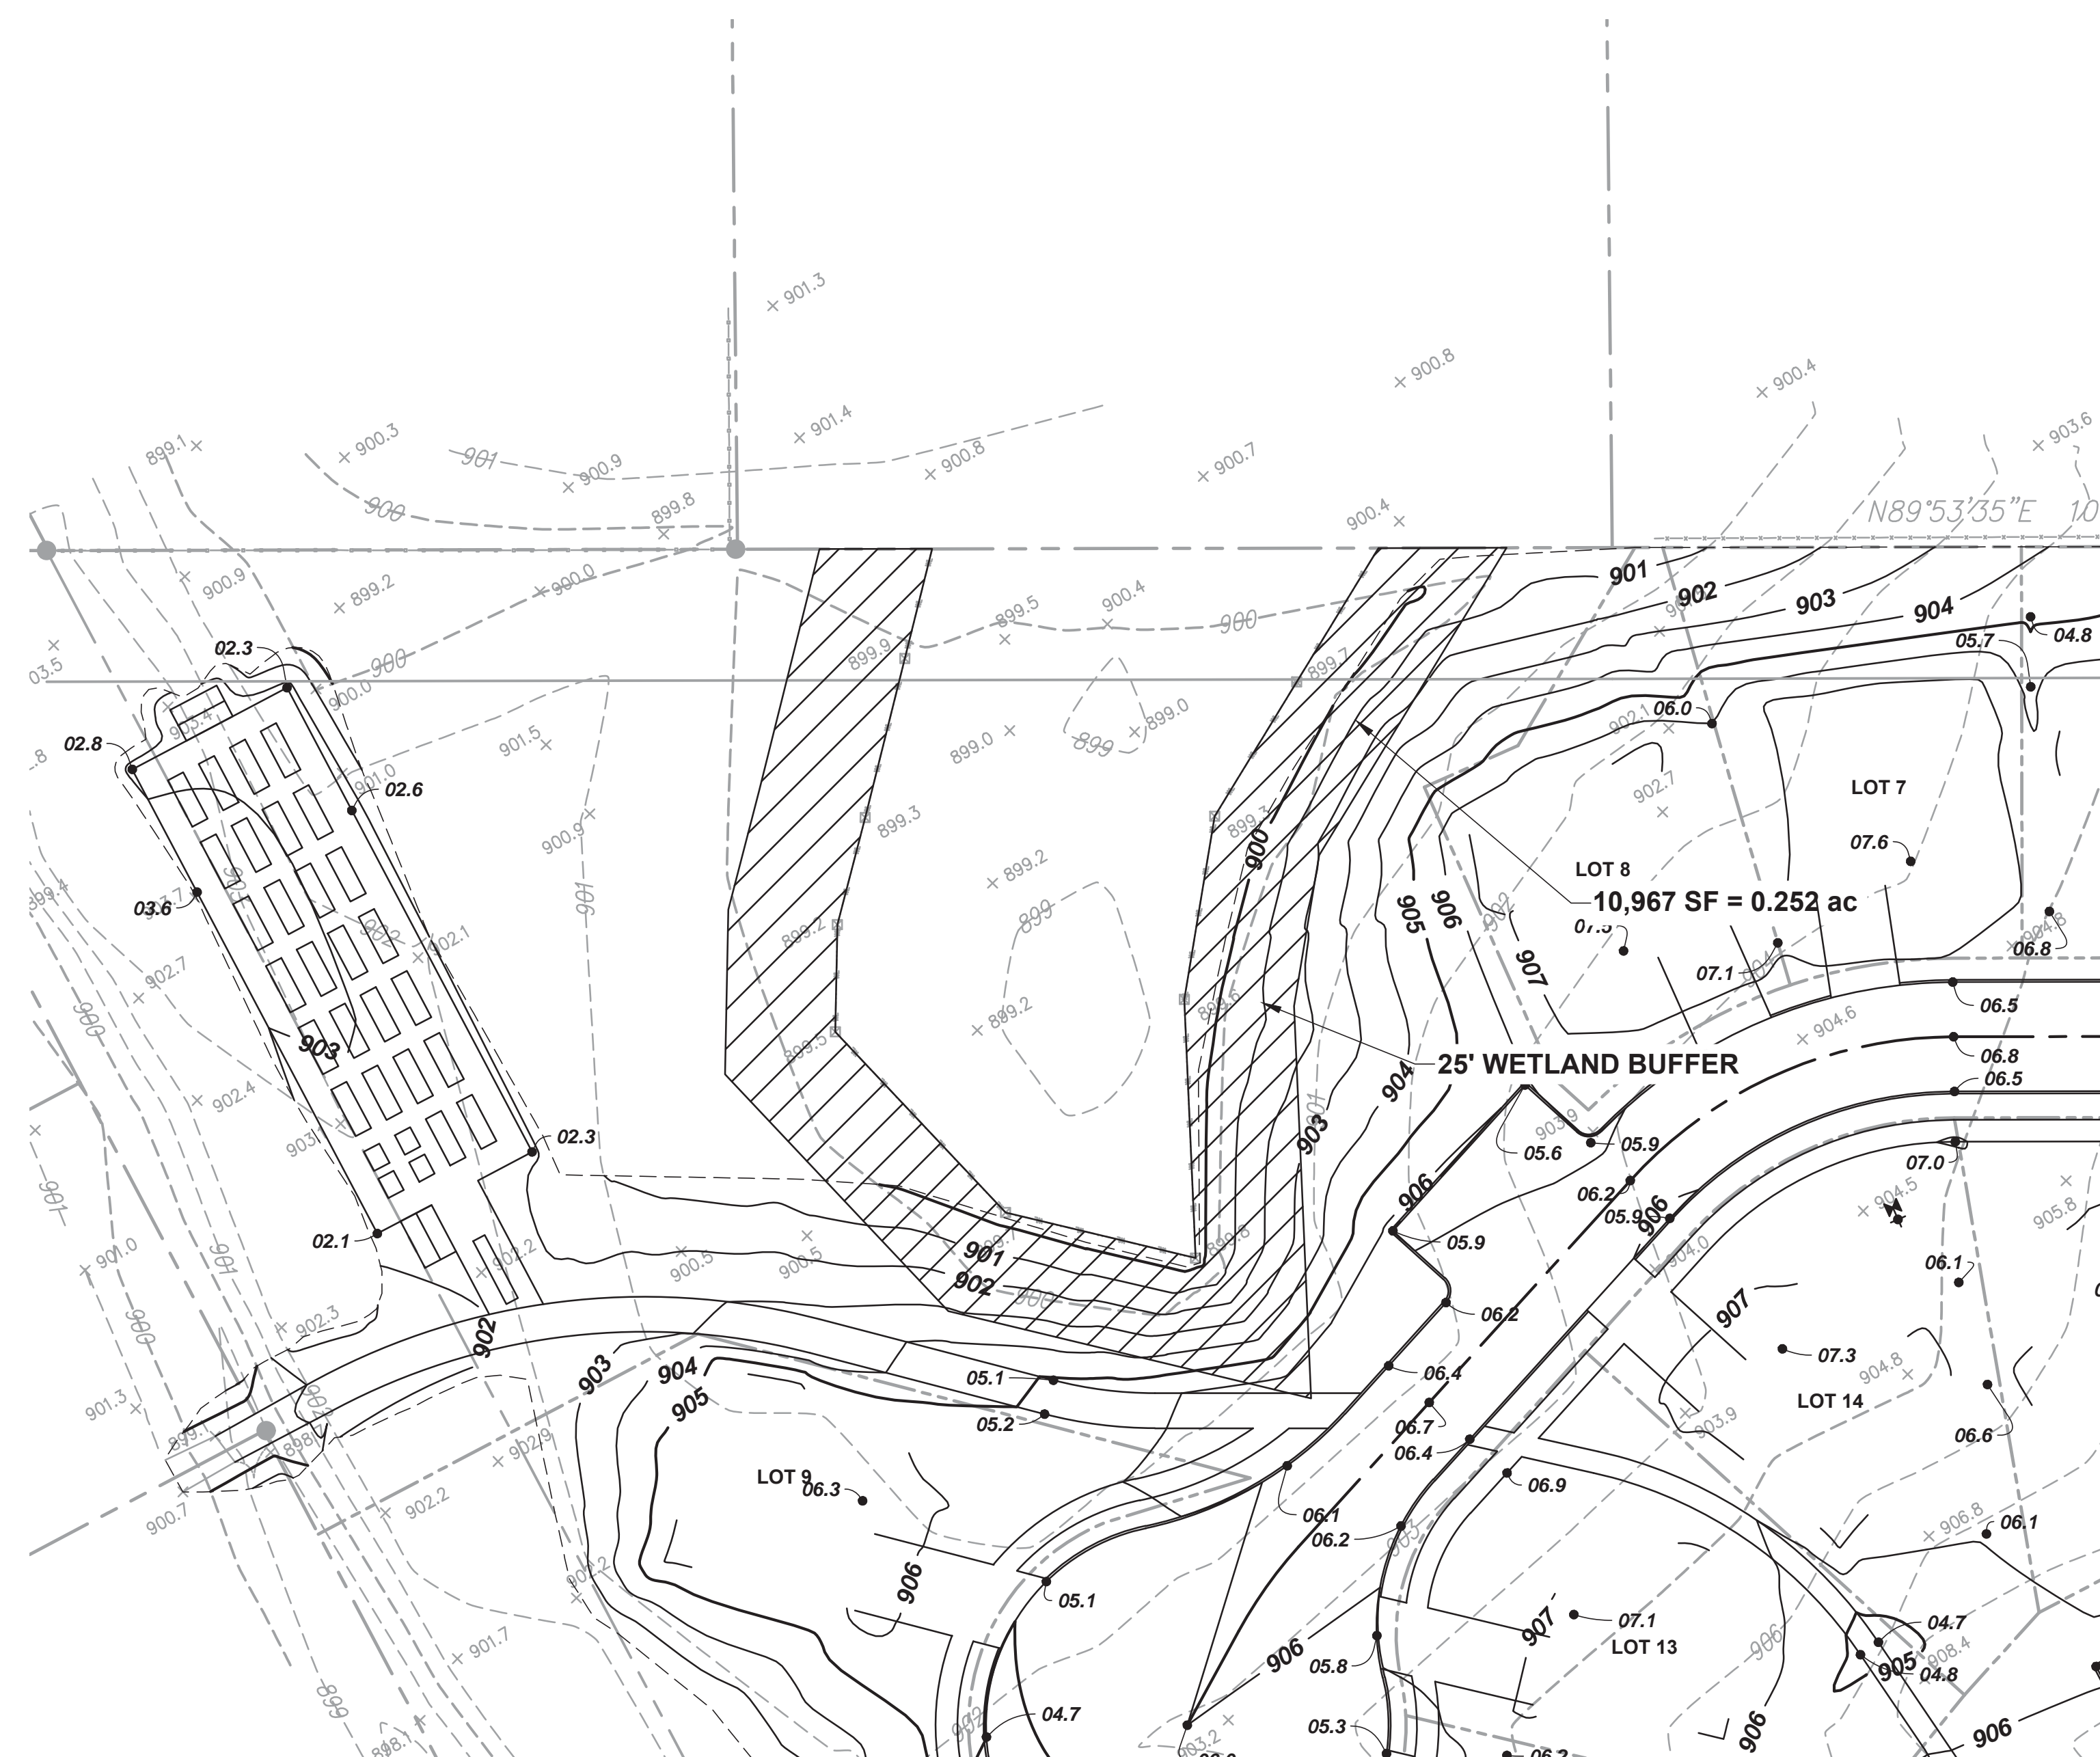

WETLAND BUFFER AREA
SCALE: 1" = 30'

I hereby certify that this plan, specification or report was prepared by me or under my direct supervision and that I am a duly Licensed PROFESSIONAL ENGINEER under the laws of the State of MINNESOTA


DAVID A. REY
Registration Number 40180 Date

Description	Revisions	
	Date	Num

Comm: XXX
Date: XXXX
Drawn: BJD
Check: DAR



**WETLAND
BUFFER MAP**

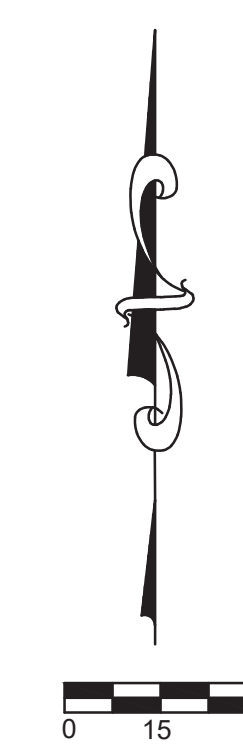

Scale: 1" = 30'

C0.00



Memorandum

To: Environmental Board

From: Marty Asleson

Date: February 6, 2019

Re: Item 6B, 2019 Environmental Board Goals

At the November 28th Environmental Board meeting, we reviewed the 2018 goals and discussed the goals for 2019. The following comments were made:

Minutes:

- Suggestion was made to be more visible to the public; such as more community events
- Schedule site visits to wetland banking and conservation easement areas, and invite residents to share their thoughts and learn more about these easements
- Circulate educational material more frequently throughout the year
- Look at past meeting notes pertaining to goals. Use this information to develop future goals and/or keep a running journal throughout the year where ideas can be readily pulled from to create the upcoming years set goals.

My Recollection:

Consolidate some of the built points from 2018 Goals, and reorder.

Lino Lakes Environmental Board 2019 Goals Draft

1. Review new development and construction plan applications for Environmental quality, and encourage a conservation development approach in these reviews. The City Comprehensive Plan reflects citizen's 2040 vision for Lino Lakes and the values expressed in the Resource Management System portion should be used in the review of development proposals.
2. Promote environmental stewardship and conservation opportunities with Lino Lakes' citizens through outreach and participation in city-sponsored events.
3. Implement public education activities to promote water conservation and protection... Continue to evaluate wetland bank opportunities to support natural resource restoration and protection. Support quality surface water management and water conservation projects. Collaborate with Rice Creek Watershed District, Vadnais Lakes Area Water Management Organization, and city staff to promote development and practices that renew, preserve, and restore surface water including lakes, stream and wetlands.
4. Partner with Anoka County Recycling Resource Solutions to meet or exceed our city recycling goal of 50 % (2,158 tons) of our municipal solid waste. Maintain or expand organics program. Find innovative ways to promote and expand recycling in the City.
5. Evaluate at least 3 past Environmental Board development projects to help inform future Environmental Board recommendations.
6. Support the Community Garden site in conjunction with the Parks Department. Assist with garden modifications that may be needed because of the 2017 land sale.
7. Continue implementation of the Lino Lakes EAB Plan. Update the plan as needed based on the 2017 identification of EAB in Lino Lakes, experience gained during implementation, and rapidity of the spread of EAB throughout the City's forests. Offer residents opportunities for tree purchasing and possibly tree treatment. Obtain interns and train them in Ash Tree Treatment. Continue treating a third of our City boulevard trees.
8. Continue to monitor the Heron rookery in Peltier Lake and to support the protection of resources in that area. Update Council on these matters. Recruit volunteers, as needed, to help with rookery maintenance and monitoring.
9. Support the maintenance of established conservation easement areas where funding is available. Conduct education as needed for homeowners near or adjacent to these easements.
10. Support EAB management and tree planting opportunities for residents.