

STAFF REPORT

DATE: 11/28/22

REGULAR

ITEM#: 4a – PUBLIC HEARING

MOTION

TO: Planning Commission

FROM: Ben Hetzel, Lake Elmo City Planner

AGENDA ITEM: Upper 33rd Street N Conditional Use Permit Request

REVIEWED BY: Sophia Jensen, Code Enforcement Official

INTRODUCTION:

Henry Elgersma of Upper 33rd LLC recently submitted a conditional use permit application to construct a four unit townhome building at the properties described as Lots 10 and 11, Block 2, Subdivision of Lake Elmo Park. (PIDs 1302921320051 and 1302921320052). The Village Mixed Use Zoning District requires a conditional use permit for all new residential uses. The existing vacant lots are located along Upper 33rd Street N to the west of Lake Elmo Avenue N in the Old Village. The applicant has also submitted a lot consolidation application to combine lots 10 and 11. Administrative approval of a consolidation is required since the properties are existing platted lots.

History

Lot 11 was originally platted as lots 11, 12, and half of 13 in the early 1900s. Since the original platting, lots 11, 12, and half of 13 were consolidated into one lot, now known as lot 11. Lot 10 has remained untouched.

ISSUE BEFORE PLANNING COMMISSION:

The Planning Commission is being asked to hold a public hearing, review, and make a recommendation on the requests to approve a conditional use permit amendment to construct a four unit townhome building.

REQUEST DETAILS/ANALYSIS:

Applicants: Henry Elgersma

Property Owner: Upper 33rd Street LLC

Location: Lots 10 and 11, Block 2, Subdivision of Lake Elmo Park

Request: Conditional Use Permit for a four unit townhome building.

Site Area: 0.4 total acres

Existing Land Use: Vacant

Existing Zoning: Village Mixed Use (VMX)

Surrounding: Rural Single Family – North, West, East

Comprehensive Plan: Village Mixed Use (VMX)

Deadline for Action: Application Complete – 11/8/22

60 Day Deadline – 1/8/23

Extension Letter – NA

Regulations: Article XIII Village Districts

Article VIII Environmental Performance Standards Article VII, Section 105.12.420 Off-Street Parking

Proposal

The applicant is proposing a total of four units in the single family attached dwelling structure. All four units will be located on a contiguous lot surrounded by existing single family residential uses. The building has a mixture of 1-1/2 and 2 story units and has a footprint of approximately 5,700 square feet with varying unit sizes. Each unit has a total of three bedrooms and a rear facing attached two car garage. A driveway is proposed off of Upper 33rd Street N along the west property line and would wrap around to access the rear facing attached garages. The provided landscape plan depicts a 6 foot privacy fence along the north property line along with trees and 3 foot tall gabions to provide screening from Upper 33rd Street N.

Village Mixed-Use Zoning District Description

This district is intended to continue the traditional mixed-use development that has occurred in the Old Village by allowing retail, service, office, civic and public uses as well as residential units. The mixture of land uses within the district is essential to establishing the level of vitality and intensity needed to support retail and service uses. Development within areas zoned VMX will occur at a density of 5 - 10 units per acre. Senior congregate care facilities may exceed this density maximum with a range not to exceed a total of 16 units per acre, provided the facility can satisfy all zoning and applicable conditional use permit review criteria. The placement of building edges and treatment of building, parking, landscaping, and pedestrian spaces is essential to creating the pedestrian friendly environment envisioned for the VMX district.

Comprehensive Plan

The subject property is located within the Old Village District of the Village Planning Area. The Old Village carries the nostalgic history and character of the City. In turn, vitality of the Old Village Main Street is dependent upon enough households supporting the existing businesses and desired businesses along Main Street.

The 2040 Comprehensive Plan indicates that the future plan for the Old Village is to enhance and preserve the historic character of Main Street. There is an opportunity to fill existing gaps with similarly sized and scaled buildings that are supportive and consistent with the architectural charm of existing buildings.

Density

The total site area equals 0.4 acres. The allowable density within the Village Mixed-Use district is a range of 5-10 units per acre. This proposal would meet the minimum and maximum density with a calculation of 10 units per acre.

| | Required | Proposed |
|----------------------------------|----------------|--------------------|
| Minimum Lot Area (Square | 3,000 per unit | 17,424 total |
| Feet) | | |
| Minimum Lot Width | 25 ft per unit | 175 ft total |
| Max Impervious Coverage | 75 percent | 66.8 percent |
| Front Yard Setback | 25 ft | 25 ft |
| Rear Yard Setback | 10 ft | 25.8 ft |
| Side Yard Setback | 10 ft | 32.3ft and 16.7 ft |
| Driveway Setback (side lot line) | 5 ft | 5 ft |

The applicant is proposing a retaining wall that abuts the west and north property lines. According to Section 105.12.200 if the Lake Elmo City Code, walls six feet in height or less may encroach into side and rear yard setbacks. However, the City Engineer has indicated that the applicant must establish drainage and utility easements along the side and year property lines. The retaining wall and portion of driveway may not encroach within these easements. The applicant will be required to provide updated plans showing the requested easements and that they are free of encroachments.

Off-Street Parking Requirements

The off-street parking requirements of the Lake Elmo City Code require one parking space per one bedroom unit and two spaces per two bedroom unit or larger for single-family attached dwellings. An additional ten percent of parking spaces shall also be required for visitor parking. The architectural plans show that the proposal will meet the bedroom parking space requirement by providing each residential unit an attached two car garage. Currently, the plans do not show visitor parking.

The Lake Elmo City Code does have a provision to waive the parking requirements in the VMX zoning district recognizing the availability of on-street and shared parking facilities. Due to the inability to park along Upper 33rd Street N, staff does not recommend waiving the parking requirements for this proposal. The applicant should be required to revise the plans to show adequate visitor parking spaces.

Development Standards

Development of land within the village districts shall follow established standards for specific uses. The following standards apply to single family attached dwellings.

- a) The primary entrance to each unit shall be located on the facade fronting a public street. *The proposal shows a primary entrance facing Upper 33rd Street N for each unit.*
- b) Common open space for use by all residents or private open space adjacent to each other shall be provided. Such open space shall comprise of a minimum of 300 square feet in the V-HDR and VMX, and 500 square feet per unit in the V-MDR. The total amount of open space required for four units is 1,200 square feet. The provided site plan shows 2,950 square feet of open space.

c) Unless otherwise specified in this article, single family attached dwellings in the VMX and V-MDR shall adhere to the MDR district setbacks. *Article XIII Village Districts lists specific setbacks for the VMX district. The proposal meets the required setbacks of the VMX district.*

Stormwater Management

The proposal includes an underground storm water infiltration chamber to mitigate 100% of the required rate and volume control. The applicant has not provided soil boring data to determine the feasibility of infiltration on the site. This data will be a requirement for an acceptable stormwater management plan.

REVIEW COMMENTS

City Engineer

- 1. Final Construction Plans must be prepared in accordance with the Engineering and Design Standards Manual, dated January 2022.
- 2. Upper 33rd Street N does not meet the minimum city standards for road width and right of way width.
- 3. No on street parking is allowed along Upper 33rd Street N. Parking must be kept internal to the site.
- 4. No sidewalk or trail currently exists along Upper 33rd Street due to the narrow roadway.
- 5. A 10-ft drainage and utility easement should be provided along the property frontage. Minimum lot easements should be included along the side and rear property lines as well.
- 6. The proposed retaining walls along the west and rear property lines should be a minimum of 5 ft from property lines and outside all lot easements.
- 7. Revise the existing conditions plan to show a minimum distance of 150 ft outside the property boundary in all directions.
- 8. The project is subject to a stormwater management plan. Post construction discharge rates and volumes must be equal or less than pre-existing discharge rates.
- 9. No storm sewer calculations have been provided to demonstrate the available capacity in the City storm sewer system at this location.
- 10. Soil borings are required to determine the feasibility of infiltration on site.
- 11. The stormwater facilities shall remain privately owned and maintained. A stormwater maintenance and easement agreement will be required. A Homeowner's association would be required to provide for ongoing ownership and maintenance.
- 12. Municipal water supply is available to the site.
- 13. Sanitary sewer service is available to the site.

Fire Department (Memo dated 10/31/22)

- 1. The fire sprinkler system shall be installed compliant with provisions of 2016 NFPA Standard 13D, Installation of Sprinkler Systems in One- and Two-Family Dwellings or IRC P2904. City permit required prior to initiation of work.
- 2. Building address numbers shall be plainly visible from the street fronting the property and shall be a contrasting color from the background. Size and placement of address numbers shall be approved by the fire and planning departments.

RECCOMMENDED CONDITIONAL USE FINDINGS

Conditional use means a land use or development as defined by ordinance that would not be

appropriate generally but may be allowed with appropriate restrictions as provided by official controls only upon a finding that all of the following provisions are met. Staff recommends the following findings:

- 1. The proposed use will not be detrimental to or endanger the public health, safety, comfort, convenience or general welfare of the neighborhood or the city. The proposed use will not endanger the public health, safety, comfort, convenience or general welfare of the neighborhood or the City.
- 2. The use or development conforms to the City of Lake Elmo Comprehensive Plan. The site is already zoned in conformance with the intent of the Old Village District of the Village Planning Area and the Village Mixed Use zoning district.
- 3. The use or development is compatible with the existing neighborhood. The proposed use is compatible with the existing single family residential in the neighborhood. The design of the proposed structure is consistent with the surrounding area in terms of building height, building materials, colors, and variations of pitched roofs.
- 4. The proposed use meets all specific development standards for such use listed in the Zoning Code. The use meets all the specific development standards for single family attached dwellings set forth in LEC 105.12.820(a)(3).
- 5. If the proposed use is in a flood plain management or shoreland area, the proposed use meets all the specific standards for such use listed in Article XIX (Shoreland Management) and Title 100 (Flood Plain Management). *The proposed use is not within a Shoreland Management District or a Floodplain Management zone.*
- 6. The proposed use will be designed, constructed, operated, and maintained so as to be compatible in appearance with the existing or intended character of the general vicinity and will not change the essential character of that area. The design of the proposed structure is designed to be compatible with the height, colors, and building materials of the surrounding area.
- 7. The proposed use will not be hazardous or create a nuisance as defined under this Chapter to existing or future neighboring structures. *The use is not hazardous and will not create a nuisance.*
- 8. The proposed use will be served adequately by essential public facilities and services, including streets, police and fire protection, drainage structures, refuse disposal, water and sewer systems and schools or will be served adequately by such facilities and services provided by the persons or agencies responsible for the establishment of the proposed use. *The proposed use will be served adequately by essential public facilities and services*.
- 9. The proposed use will not create excessive additional requirements at public cost for public facilities and services and will not be detrimental to the economic welfare of the community. *The proposed use will not create excessive additional requirements at a public cost.*
- 10. The proposed use will not involve uses, activities, processes, materials, equipment, and

conditions of operation that will be detrimental to any persons, property, or the general welfare because of excessive production of traffic, noise, smoke, fumes, glare, or odors. The proposed residential use will not produce excessive noise, fumes, glare, or odors. The addition of four dwelling units should not create excessive traffic along 33rd Street N especially with the restriction of on street parking. Any future expansion of 33rd Street N to the west will further improve traffic circulation.

- 11. Vehicular approaches to the property, where present, will not create traffic congestion or interfere with traffic on surrounding public thoroughfares. The proposed structure will not create traffic congestion or interfere with traffic on surrounding public thoroughfares. Four additional residential units should not create congestion. The rear facing garages and singular access creates for a safer vehicle access onto Upper 33rd Street N by eliminating the need to back out into a public street.
- 12. The proposed use will not result in the destruction, loss, or damage of a natural or scenic feature of major importance. The use will not result in the destruction, loss, or damage of a natural or scenic feature of major importance.

FISCAL IMPACT:

None

RECOMMENDED CONDITIONS OF APPROVAL:

- 1. The applicant must obtain all other necessary City, State, and other governing body permits and approvals prior to the commencement of any construction activity onsite.
- 2. All recommendations in the City Engineer's memorandum dated 11/15/22 shall be met prior to any construction activity.
- 3. All recommendations provided be the City's Landscape Architect shall be met prior to any construction activity.
- 4. All conditions in the Fire Chief's memorandum dated 11/8/22 must be met prior to any construction activity.
- 5. The applicant shall provide the City with recorded documents from Washington County which effectuate the required lot consolidation prior to any construction activity.
- 6. The applicant must receive an approved address from Washington County prior to any construction activity.
- 7. The applicant shall provide one additional off-street parking space for visitor parking as per Lake Elmo City Code.
- 8. An encroachment agreement is required for fencing located in the required drainage and utility easements prior to any construction activity. A fence permit is also required regardless of the location of the fencing.
- 9. If the applicant has not taken action toward starting the townhouse structure or if substantial construction has not taken place within 12 months of the City's approval of the conditional use permit, the CUP approval shall become void. The applicant may request City Council approval of a time extension to start or implement the conditional use permit.

PUBLIC COMMENT:

A public hearing notice was sent to surrounding property owners on November 16, 2022 and published in the Stillwater Gazette on November 18, 2022. Staff has received one public comment that was against the request.

Susan Dunn at 11018 Upper 33rd Street N provided comment to staff in opposition of the proposal. The reason being, is that the proposed single family attached use is inappropriate for this area.

OPTIONS:

The Planning Commission may:

- Recommend approval of the requests.
- Recommend approval of the requests with conditions.
- Recommend denial of the requests, citing findings of fact for denial.

RECOMMENDATION:

Staff recommends that the Planning Commission recommend approval of the conditional use permit amendment to construct a four unit townhome building.

"Move to recommend approval of a conditional use permit to allow the construction of a four unit townhome building at the properties described as Lots 10 and 11, Block 2, Subdivision of Lake Elmo Park."

ATTACHMENTS:

- 1) Land Use Applications
- 2) Written Statements
- 3) Location Map
- 4) Civil Plans
- 5) Architectural Plans
- 6) City Engineer Email Dated 11/15/22
- 7) Fire Department Memo dated 11/8/22

| Date Received: | |
|----------------|---|
| Received By: | 7 |
| Permit #: | |



651-747-3900 3800 Laverne Avenue North Lake Elmo, MN 55042

LAND USE APPLICATION

| Little GGE / II i Elevition | |
|---|------|
| ☐ Comprehensive Plan ☐ Zoning District Amend ☐ Zoning Text Amend ☐ Variance*(see below) ☐ Zoning Appeal | |
| ☐ Conditional Use Permit (C.U.P.) ☐ Flood Plain C.U.P. ☐ Interim Use Permit (I.U.P.) ☐ Excavating/Grading | |
| ☐ Lot Line Adjustment ☐ Minor Subdivision ☐ Residential Subdivision Sketch/Concept Plan | |
| □ PUD Concept Plan □ PUD Preliminary Plan □ PUD Final Plan □ Wireless Communications | |
| Applicant: Henry Elgersma Address: 393 Cleveland Ave S, Saint Paul, MN 55105 Phone # 515-441-2594 Email Address: henry@jcorp.biz Fee Owner: Upper 33rd, LLC Address: 393 Cleveland Ave S Saint Paul, MN 55105 Phone # 515-441-2594 Email Address: henry@jcorp.biz Property Location (Address): N/A (Complete (long) Legal Description: SUBDIVISIONNAME ELMO PARK LOT 10 BLOCK 2 SUBDIVISIONCD 37200 LOTS 11&12 & E1/2 OF LT 13 002 ELMO PARK ADD SUBDIVISIONNAME ELMO PARK LOT 11 BLOCK 2 SUBDIVISIONCD 37200 PID#: 1302921320051, 1302921320052 | |
| Detailed Reason for Request: | |
| COF Submittal to build new 4-unit townhouse project on Opper 33rd 3t | |
| | |
| *Variance Requests: As outlined in Section 301.060 C. of the Lake Elmo Municipal Code, the applicant must demonstrate practical difficulties before a variance can be granted. The practical difficulties related to this application are as follows: | |
| No variance requests | |
| | |
| In signing this application, I hereby acknowledge that I have read and fully understand the applicable provisions of the Zoning ordinance and current administrative procedures. I further acknowledge the fee explanation as outlined in the application procedures and hereby agree to pay all statements received from the City pertaining to additional application expense. Signature of applicant: Date: Date: | |
| Signature of fee owner: Date: | CITY |
| | |

W OCL S 8 SOSS



CUP Application - Written Statements

Upper 33rd Street

A) Contact Information

Owners:

Henry Elgersma 393 Cleveland Ave S, Saint Paul, MN 55105 515-441-2594 Ryan McKilligan: 1110 Raymond Ave #3, Saint Paul, MN 55108

Civil Engineer:

651-502-1470

T.J. Rose, P.E. 3524 Labore Road, White Bear Lake, MN 55110 651-481-9120

Architect:

Henry Elgersma, AIA 393 Cleveland Ave S, Saint Paul, MN 55105 515-441-2594

B) Site Data

No address assigned
V-MX (Village Mixed Use) zoning
12,499 SF (.287 acres) - PID 1302921320052
5,000 SF (.115 acres) - PID 1302921320051
Legal Description:
SubdivisionName ELMO PARK Lot 11 Block 2 SubdivisionCd 37200
SubdivisionName ELMO PARK Lot 10 Block 2 SubdivisionCd 37200
LOTS 11&12 & E1/2 OF LT 13 002 ELMO PARK ADD SUBDIVISIONNAME ELMO PARK
LOT 11 LOCK 2 SUBDIVISIONCD 37200

C) Property history

Currently a vacant piece of land

D) Proposed use

i. We are proposing a residential use comprised of four single-family attached dwelling units on one combined lot. The units will each have a main entry facing Upper 33rd Street with open front yards to create an appealing front elevation and



connection to the surrounding community. Each unit will have a rear-facing two car garage accessed from a private driveway. One access point for vehicles on the western portion of the site is proposed, with the east side yard being maintained for open space along with the front yard. The proposed building conforms to all setback requirements and leaves ample space between the structure and adjacent properties. Fencing will be provided to screen between the properties to the west and north. There should be minimal impact to any wetland or forest natural areas.

ii. No employees or hours of operation for residential use. Proposed development schedule would be construction during 2023 construction season with opening late 2023.


E) Justification


- i. The proposed Residential use of Attached Single Family Dwellings is consistent with the context of the adjacent area in terms of overall building height, quality of proposed building, and residential use. The use will not be detrimental to public health, safety, comfort, convenience, or general welfare of the neighborhood or City.
- ii. Lake Elmo 2040 Comprehensive Plan Goals for the Old Village District include encouraging walkable, pedestrian scale buildings, encouraging an increase in households, and supporting development of various housing types throughout the community for various life stages. The proposed density of 4 dwelling units in 4.02 acres is consistent with the Lake Elmo 2040 Comprehensive Plan which allows a minimum of 5 up to 10 dwelling units per acre for the Village Mixed Use designation. We believe introducing four high-quality, single family attached rental homes contributes to these goals by increasing the population to support the nearby businesses on Lake Elmo Ave, contributing to the walkable quality of the neighborhood with pedestrian scaled buildings with entrances that face the street rather and not garages, and complying with the density target for the V-MU area. Additionally, creating four high-quality rental units diversifies the housing options that are currently almost entirely owner-occupied, and offers a low-maintenance living option for residents in any stage of life.
- iii. The proposed project's compatibility with the existing neighborhood is established through:
 - 1. Using a mixture of 1-1/2 story and 2 story units which are similar in height to existing housing nearby
 - 2. Using similar materials and color palettes to nearby houses and buildings on Lake Elmo Ave.
 - 3. Utilizing varied pitched roofs and wall planes to tie into the existing massing and shape of nearby homes and the break the building down into smaller parts
 - 4. Using similar window patterning as nearby homes and businesses
 - 5. Creating primary entrances that face the street and sidewalks to encourage pedestrian connection to the neighborhood




6. Locating the garages and vehicular circulation in the rear of the building.

ArcGIS Web AppBuilder

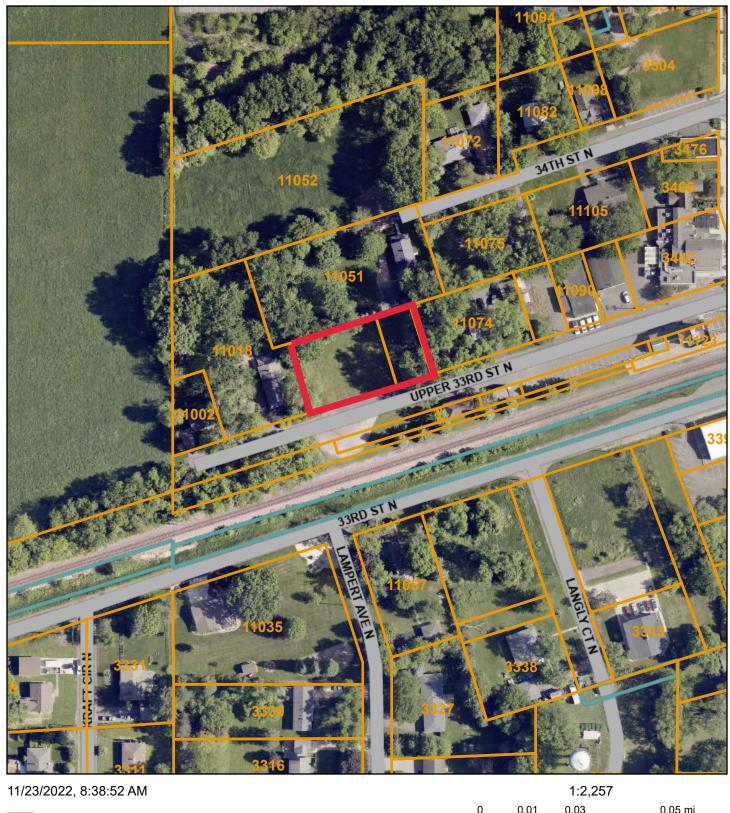

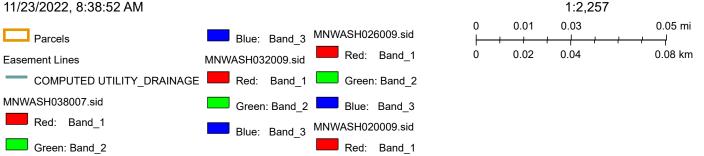

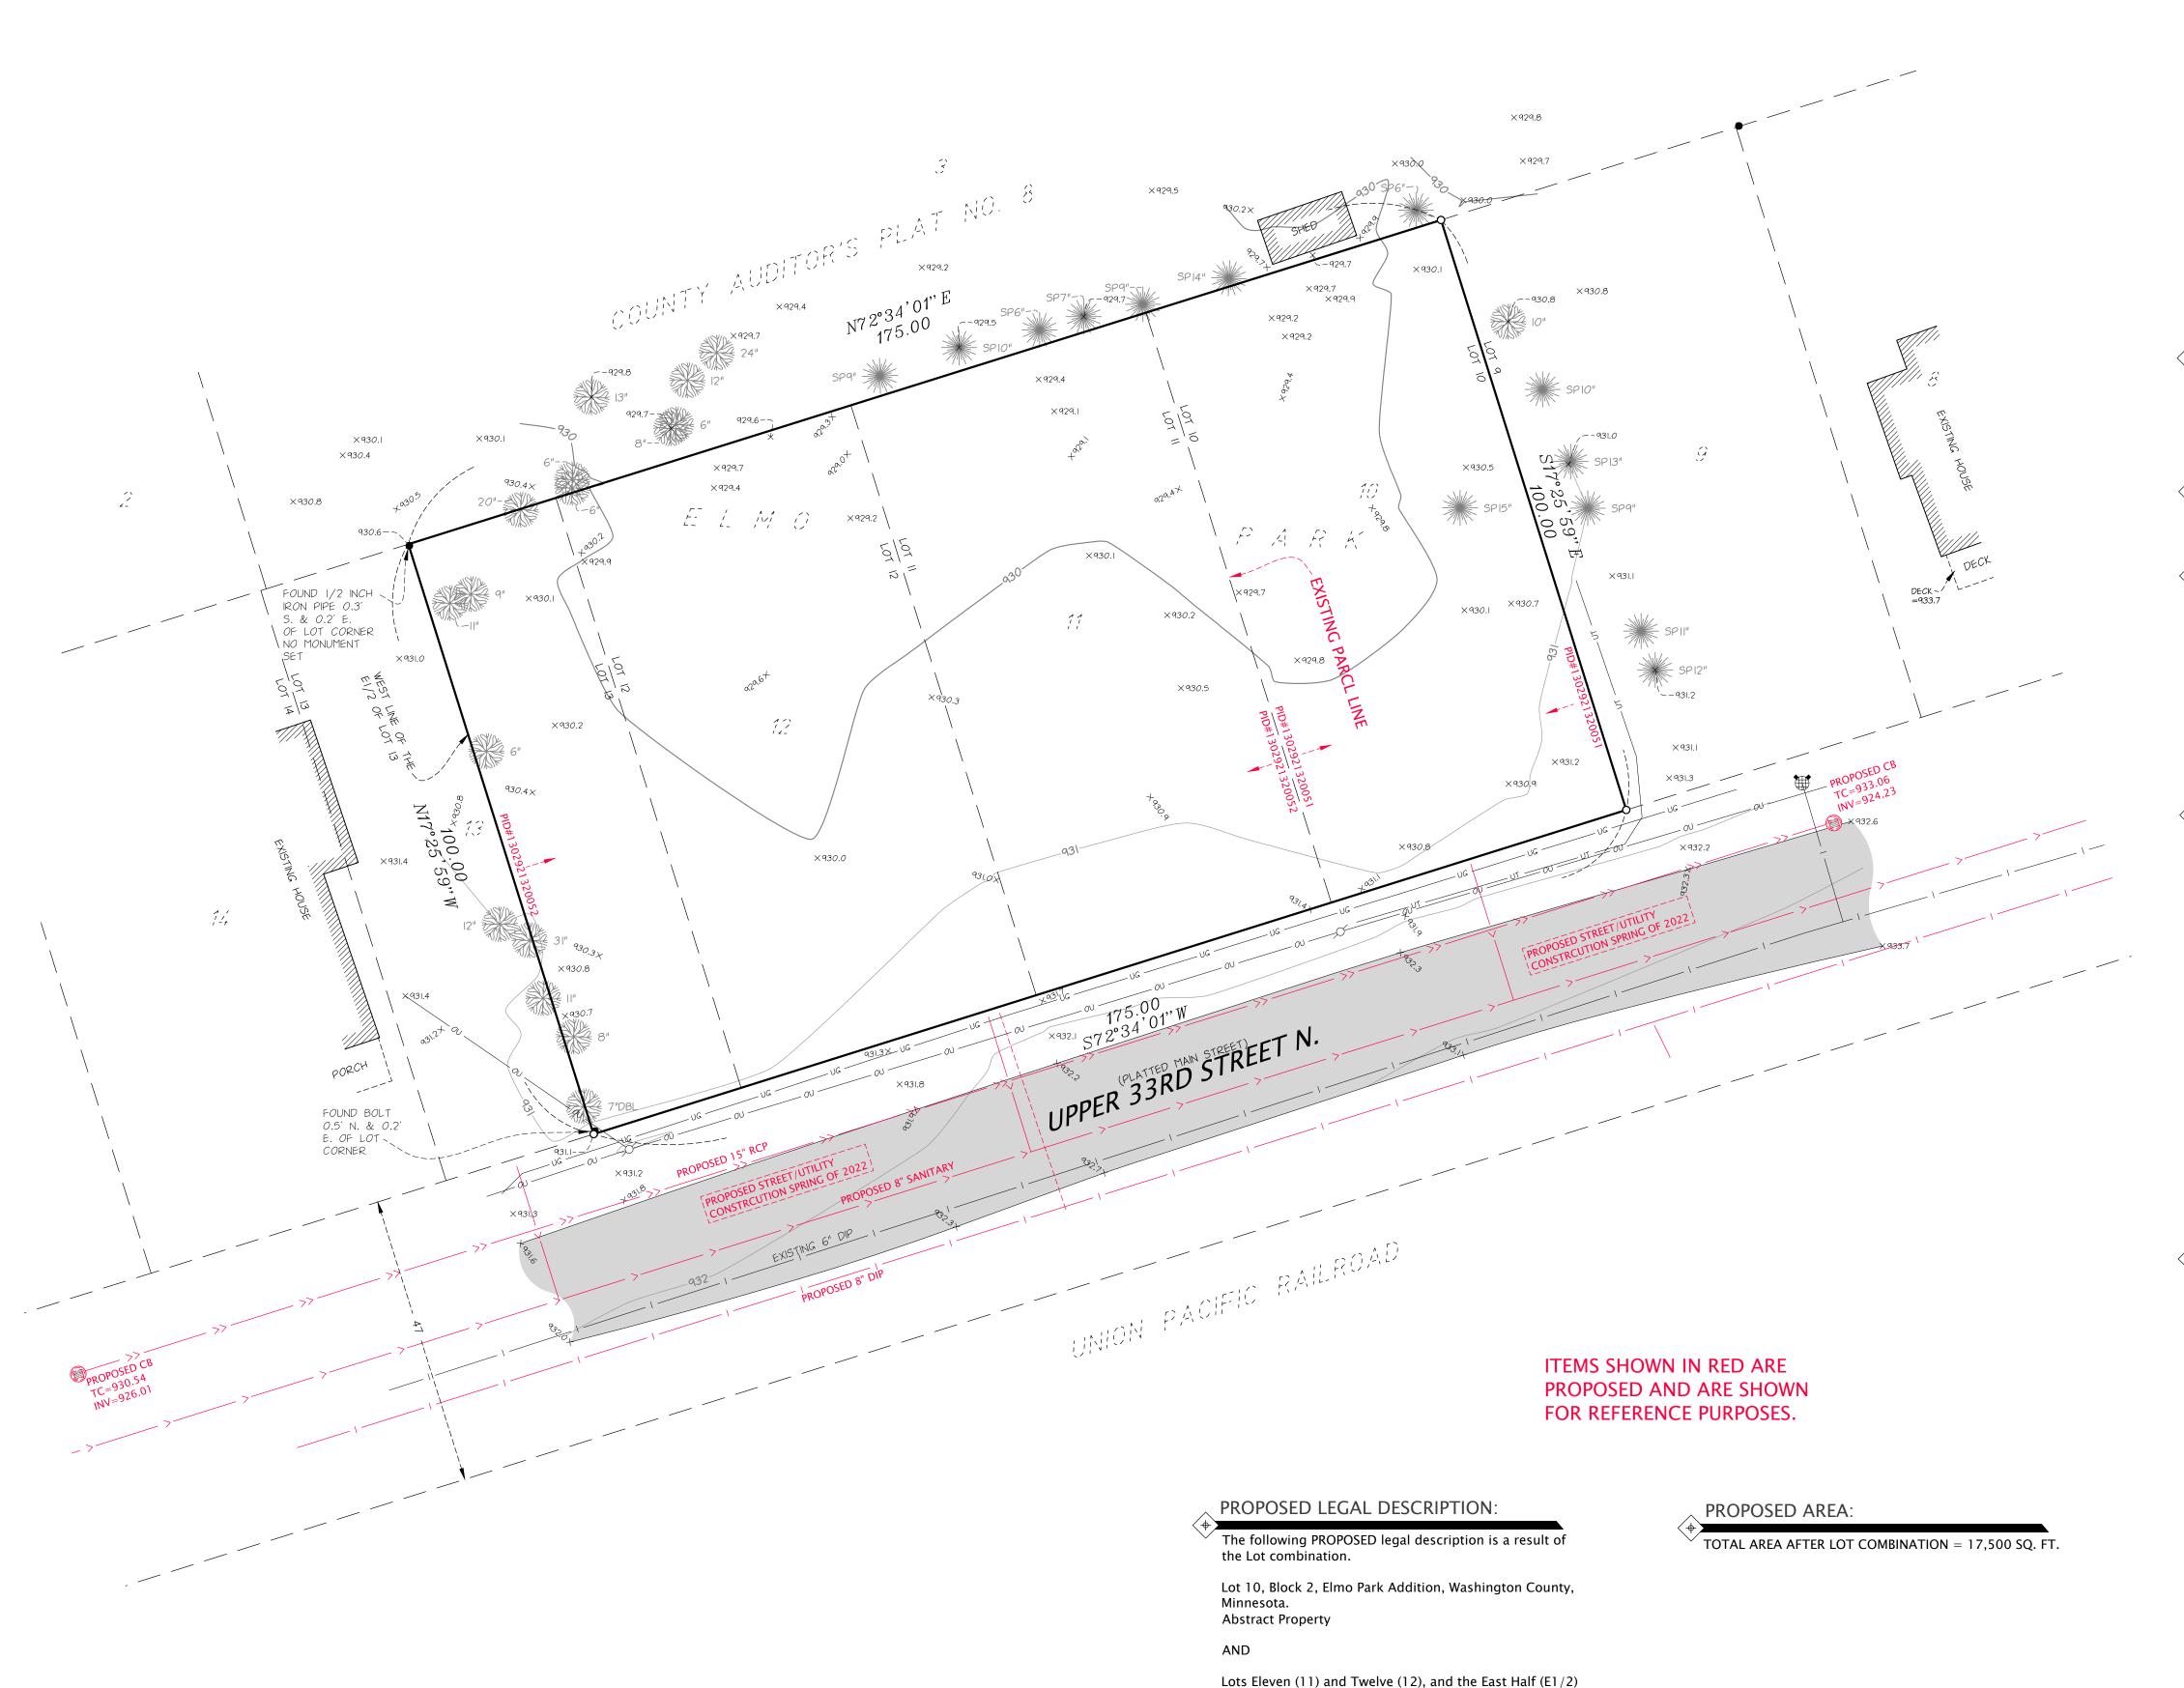

of Lot Thirteen (13) in Block Two (2) of Elmo Park,

Minnesota.

Torrens Property

according to the plat thereof on file and of record in the office of the Registrar of Titles, Washington County,

LEGAL DESCRIPTION:

The following legal description is as shown on the All American Title Co., Inc as Agent for Old Republic National Title Insurance Company Title Commitment No. 119817-22-02-R-1, dated January 10th, 2022

PID#1302921320051 Lot 10, Block 2, Elmo Park Addition, Washington County, Minnesota. Abstract Property

AND

PID#1302921320052 Lots Eleven (11) and Twelve (12), and the East Half (E1/2) of Lot Thirteen (13) in Block Two (2) of Elmo Park, according to the plat thereof on file and of record in the office of the Registrar of Titles, Washington County,

Minnesota. Torrens Certificate No. 71287

TITLE NOTES:

THE FOLLOWING EASEMENTS AND OR ENCUMBRANCES ARE AS SHOWN ON THE ABOVE MENTIONED TITLE COMMITMENT.

1. NO SURVEY RELATED ITEMS LISTED ON SAID TITLE COMMITMENT.

AREA:

TOTAL AREA AS SHOWN = 17,500 SQ. FT.

SURVEY NOTES:


- 1. BEARINGS ARE BASED ON THE WASHINGTON COUNTY COORDINATE SYSTEM NAD 1983.
- 2. UNDERGROUND UTILITIES SHOWN PER GOPHER ONE LOCATES AND AS-BUILTS PLANS PROVIDED BY THE CITY OF LAKE ELMO PUBLIC WORKS DEPARTMENT.
- 3. THERE MAY SOME UNDERGROUND UTILITIES, GAS, ELECTRIC, ETC. NOT SHOWN OR LOCATED.
- 4. PROPOSED UTILITIES SHOWN PER PLANS PROVIDED BY THE CITY OF LAKE

ELMO ENGINEERING DEPARTMENT.

LEGEND:

FLARED END SECTION


STORM MANHOLE

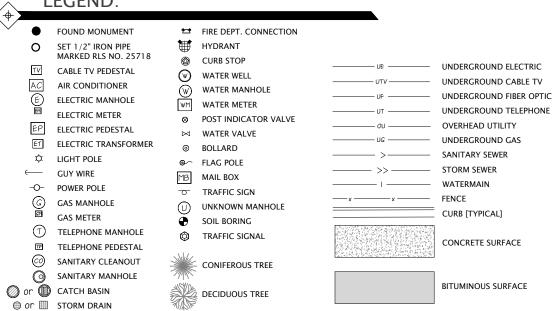

UNDERGROUND UTILITIES NOTES:

THE UNDERGROUND UTILITIES SHOWN HAVE BEEN LOCATED FROM FIELD SURVEY INFORMATION AND EXISTING DRAWINGS. THE SURVEYOR MAKES NO GUARANTEE THAT THE UNDERGROUND UTILITIES SHOWN COMPRISE ALL SUCH UTILITIES IN THE AREA, EITHER IN SERVICE OR ABANDONED. THE SURVEYOR FURTHER DOES NOT WARRANT THAT THE UNDERGROUND UTILITIES SHOWN ARE IN THE EXACT LOCATION INDICATED ALTHOUGH HE DOES CERTIFY THAT THEY ARE LOCATED AS ACCURATELY AS POSSIBLE FROM THE INFORMATION AVAILABLE. THIS SURVEY HAS NOT PHYSICALLY LOCATED THE UNDERGROUND UTILITIES. ADDITIONAL UTILITIES OF WHICH WE ARE UNAWARE MAY EXIST.



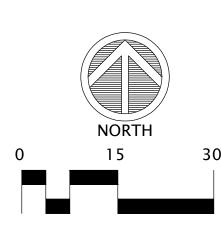

CONTACT:

Ryan McKilligan - Project Manager Element Design-Build Mobile: 515-291-7708 ryan@element-db.com

COUNTY/CITY:



CITY OF LAKE ELMO

REVISIONS:


DATE REVISION 3-10-22 INITIAL ISSUE 11-2-22 LOT COMBINATION


CERTIFICATION:

me, or under my direct supervision, and that I am a duly Licensed Land Surveyor under the laws of the state of Minnesota.

Date: 3-10-22

PROJECT LOCATION:

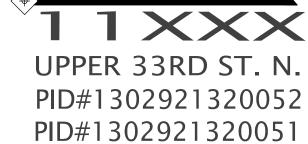

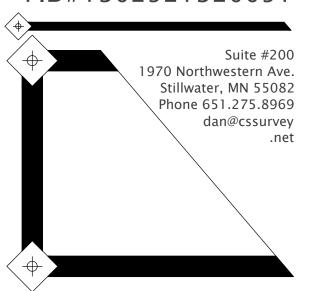


CORNERSTONE LAND SURVEYING, INC.

FILE NAME PROJECT NO.

COMBINATION

ZZ271A

ZZ12271A

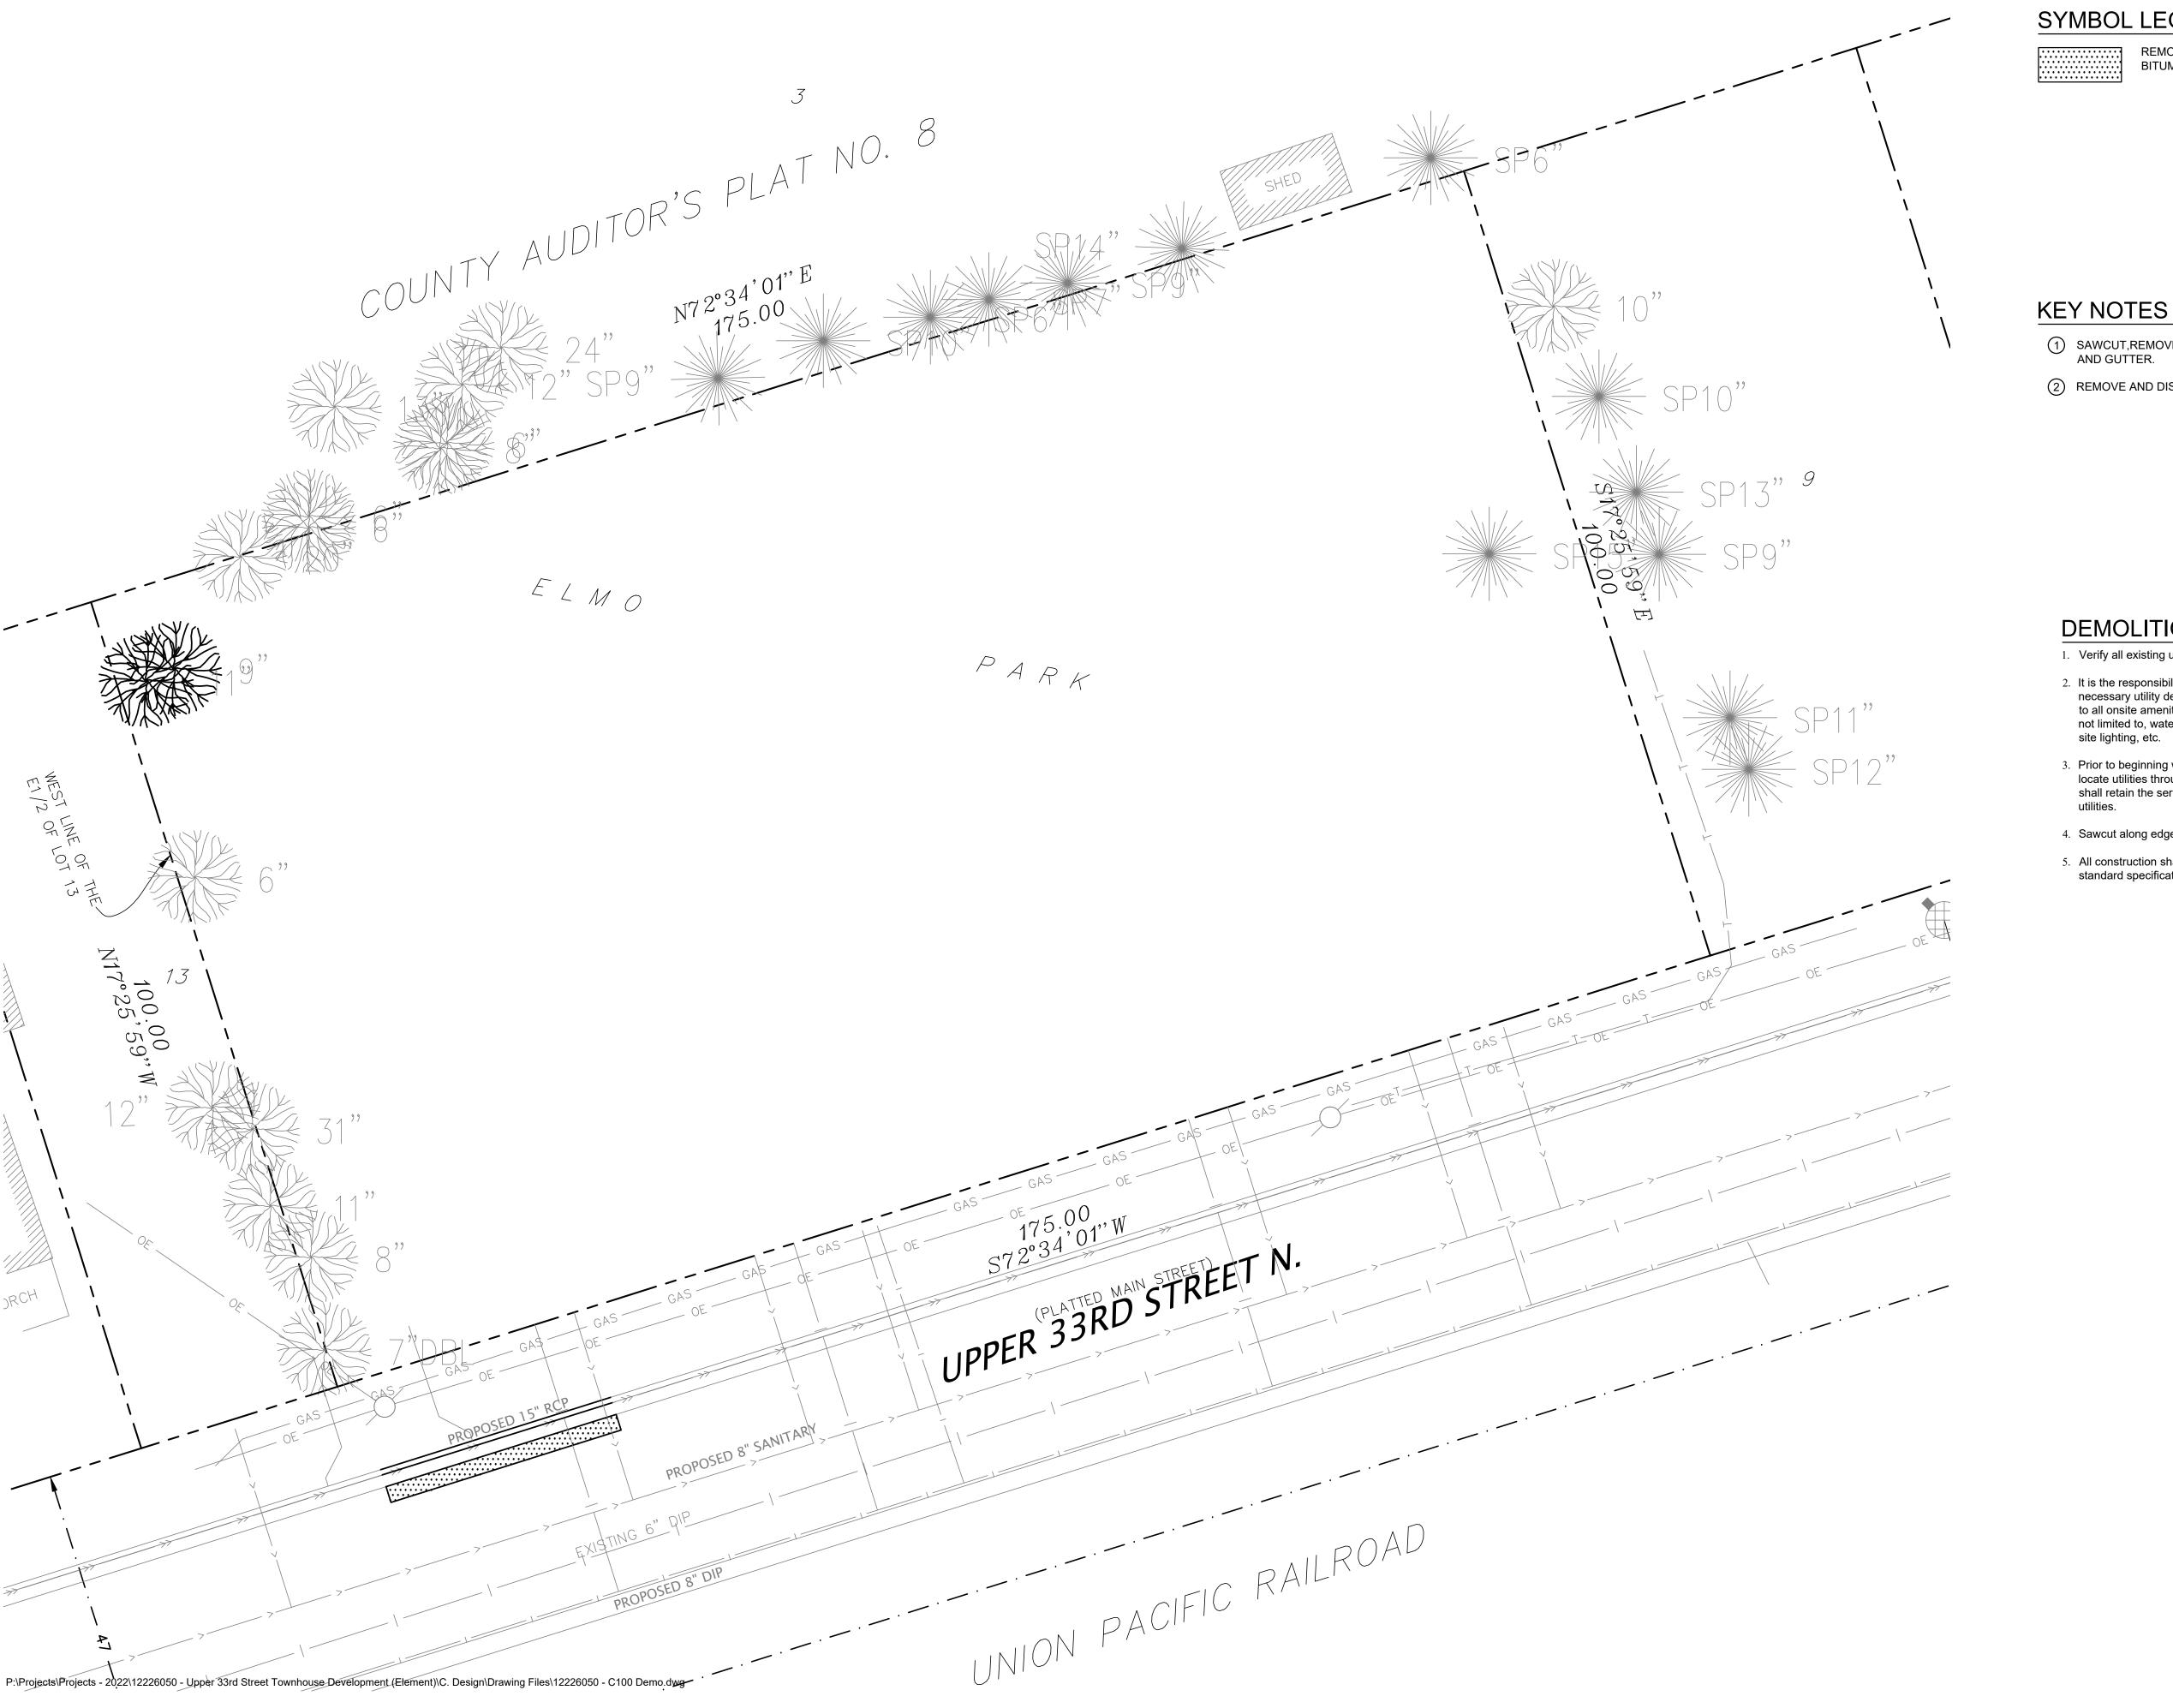

SYMBOL LEGEND

REMOVE AND DISPOSE OF EXISTING BITUMINOUS PAVEMENT SECTION

(1) SAWCUT, REMOVE, AND DISPOSE OF EXISTING CONCRETE CURB AND GUTTER.


2 REMOVE AND DISPOSE OF EXISTING TREE, STUMP, AND ROOTS.



DESIGN-BUIL

DEMOLITION NOTES

- 1. Verify all existing utility locations.
- 2. It is the responsibility of the Contractor to perform or coordinate all necessary utility demolitions and relocations from existing utility locations to all onsite amenities and buildings. These connections include, but are not limited to, water, sanitary sewer, cable tv, telephone, gas, electric, site lighting, etc.
- Prior to beginning work, contact Gopher State Onecall (651-454-0002) to locate utilities throughout the area under construction. The Contractor shall retain the services of a private utility locator to locate the private
- 4. Sawcut along edges of pavements, sidewalks, and curbs to remain.
- 5. All construction shall be performed in accordance with state and local standard specifications for construction.

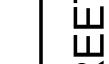

STRE

I hereby certify that this plan, specifications or report was prepared by me or under my direct supervision and that I am a duly licensed Professional Engineer under the laws of the state of Minnesota.

Matthew J. Woodruff, P.E. Date: 11.03.22 Lic. No.:

Rev. Date Description


Project #: 12226050 Drawn By:

Checked By: MJW

Issue Date: 11.03.22 Sheet Title:

DEMOLITION PLAN

Sheet: C100

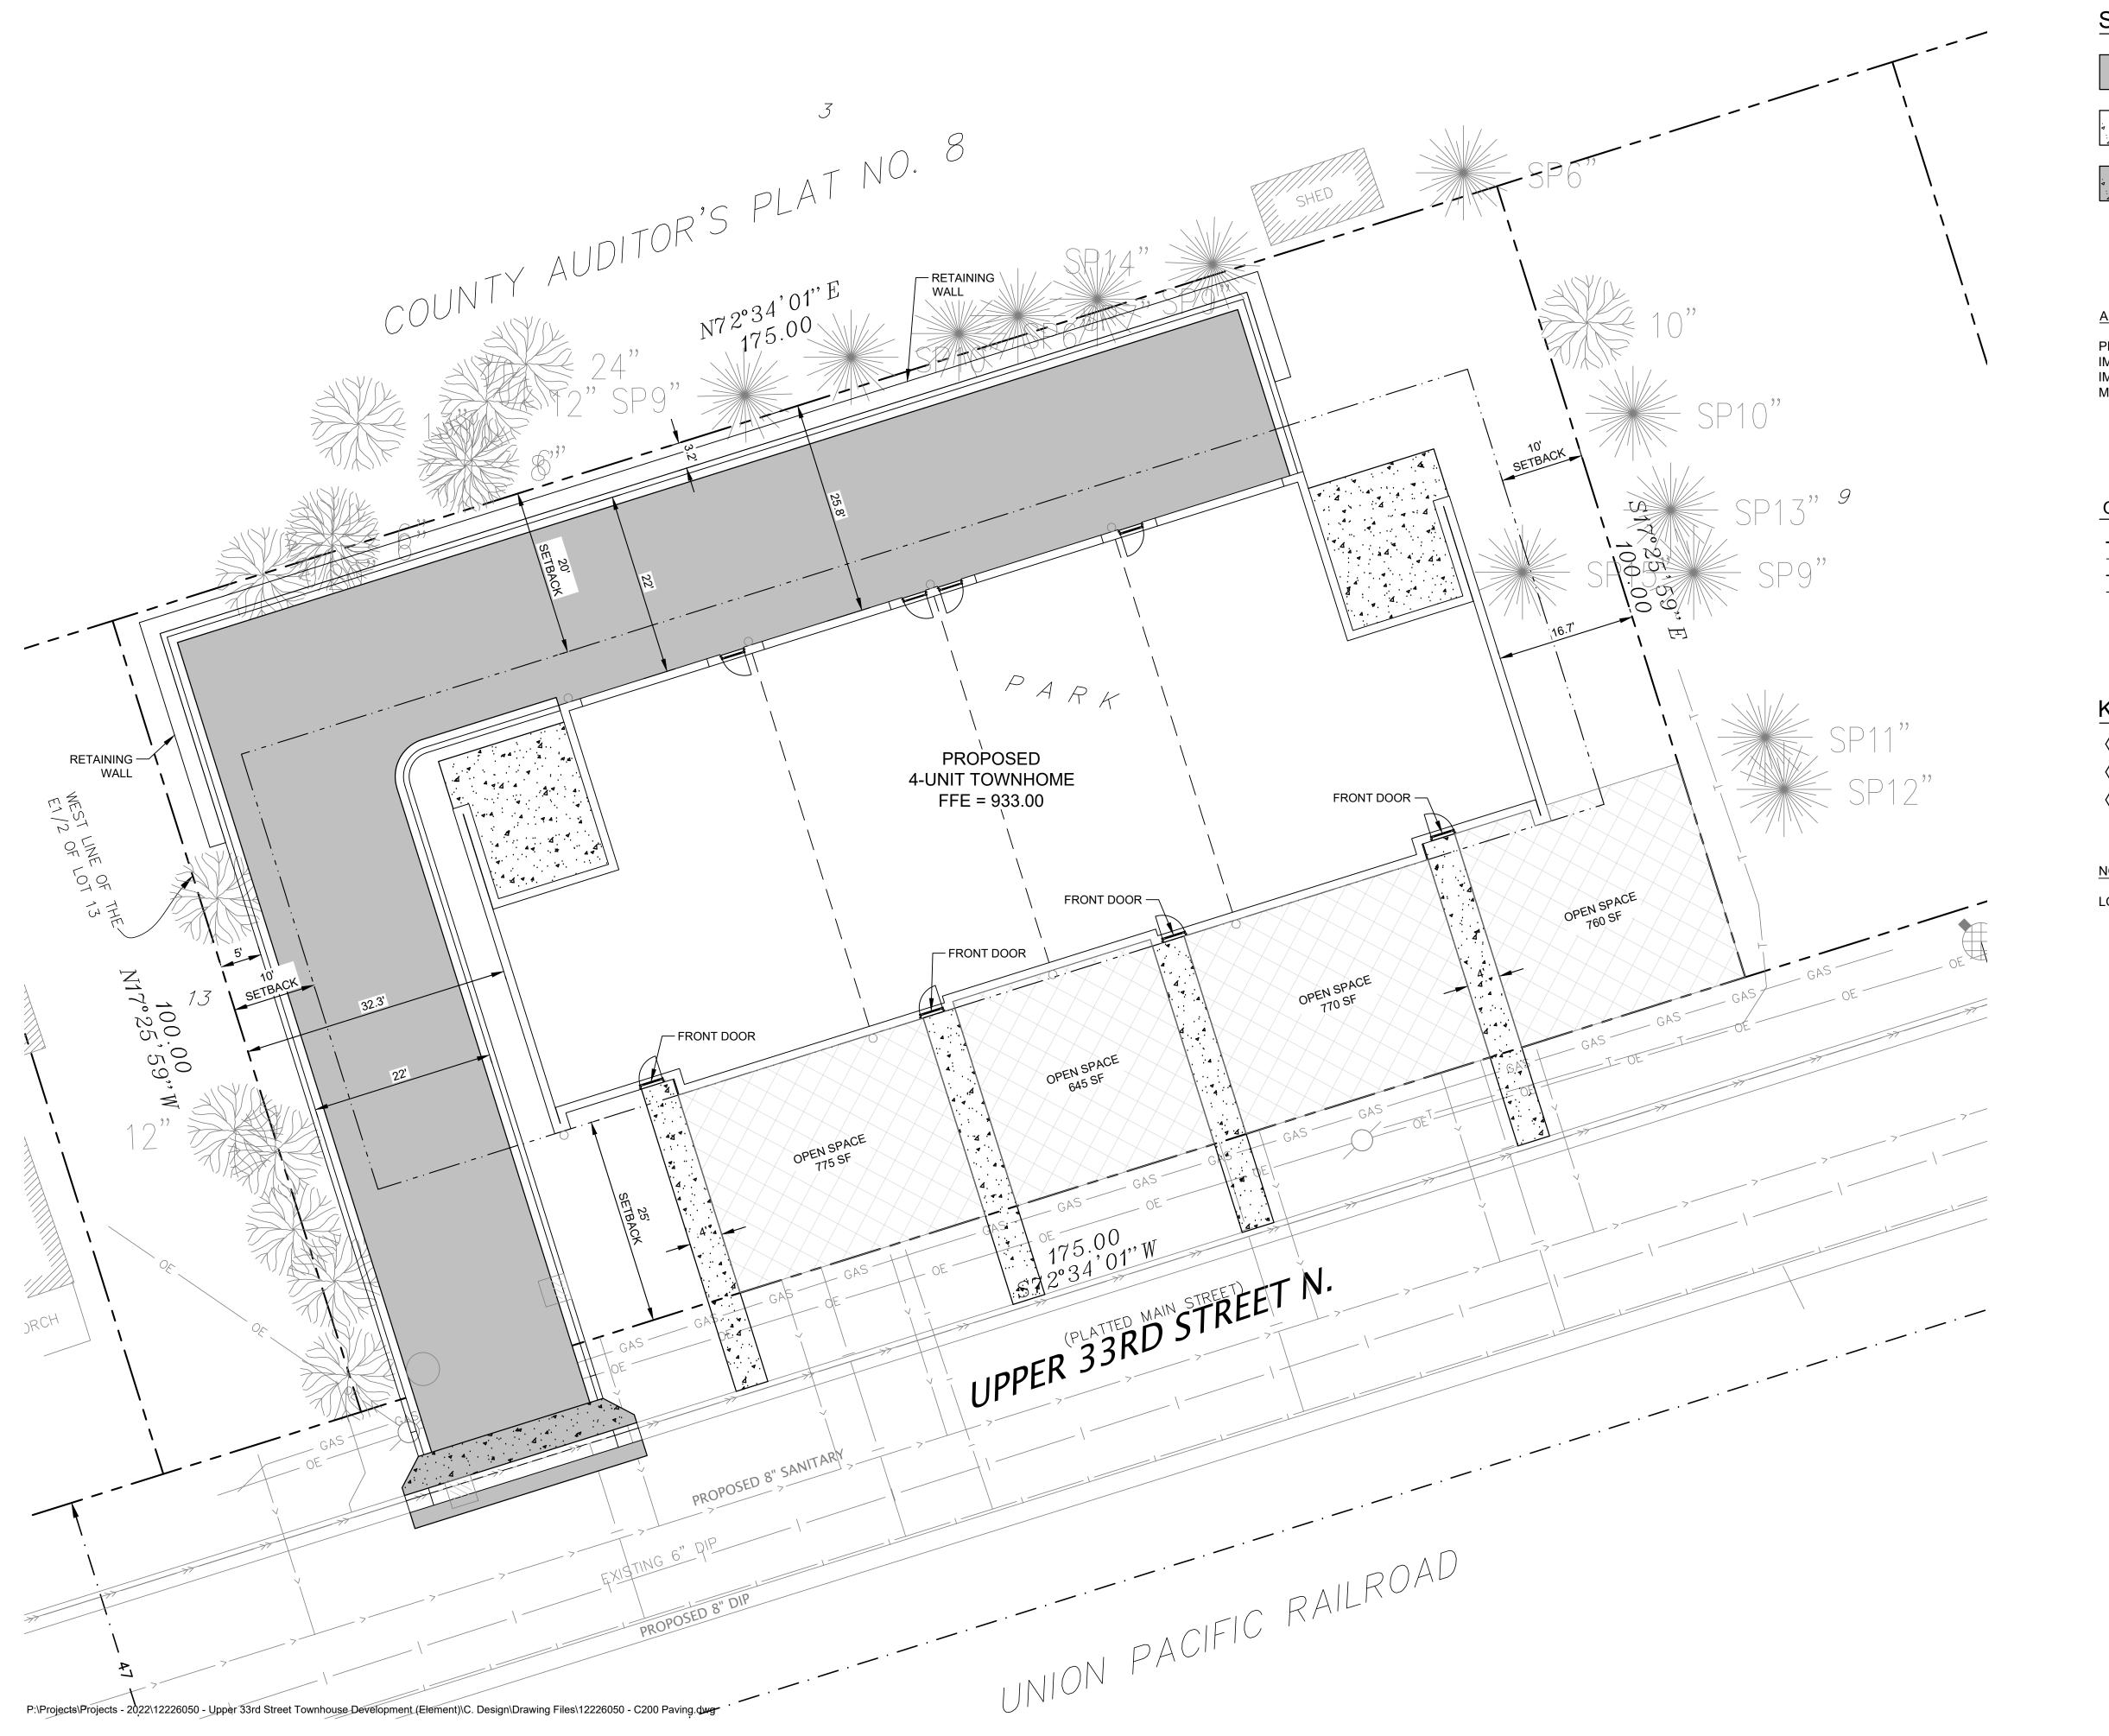

SYMBOL LEGEND

NEW LIGHT-DUTY BITUMINOUS PAVEMENT SEE DETAIL 1/C500



NEW CONCRETE SIDEWALK SEE DETAIL 3/C500




NEW DRIVEWAY APRON CONCRETE PAVEMENT SEE DETAIL 10/C500

AREA CALCULATIONS:

PROPERTY AREA = 17,500 S.F.
IMPERVIOUS AREA = 11,684 S.F.
IMPERVIOUS PERCENT = 66.8%
MAX. ALLOWABLE IMPERVIOUS = 75% (13,125 S.F.)


GENERAL LEGEND

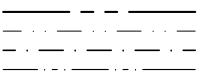

KEY NOTES

- 1 B612 CURB AND GUTTER, SEE DETAIL 2/C500
- 2 DRIVEWAY APRON, SEE DETAIL 10/C500
- (3) RETAINING WALL, SEE DETAIL 4/C500

LOTS WILL BE CONSOLIDATED INTO ONE LOT.

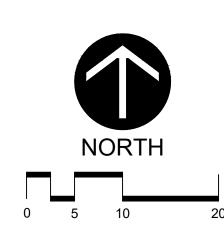

Larson Engineering, Inc.

DESIGN-BUILD

RD STREE' HOUSE

I hereby certify that this plan, specifications or report was prepared by me or under my direct supervision and that I am a duly licensed Professional Engineer under the laws of the state of Minnesota.

Matthew J. Woodruff, P.E. Date: 11.03.22 Lic. No.:

Description


Rev. Date

| Project #: | 12226050 |
|-------------|----------|
| Drawn By: | TJR |
| Checked By: | MJW |

Issue Date: 11.03.22

Sheet Title:

SITE PLAN

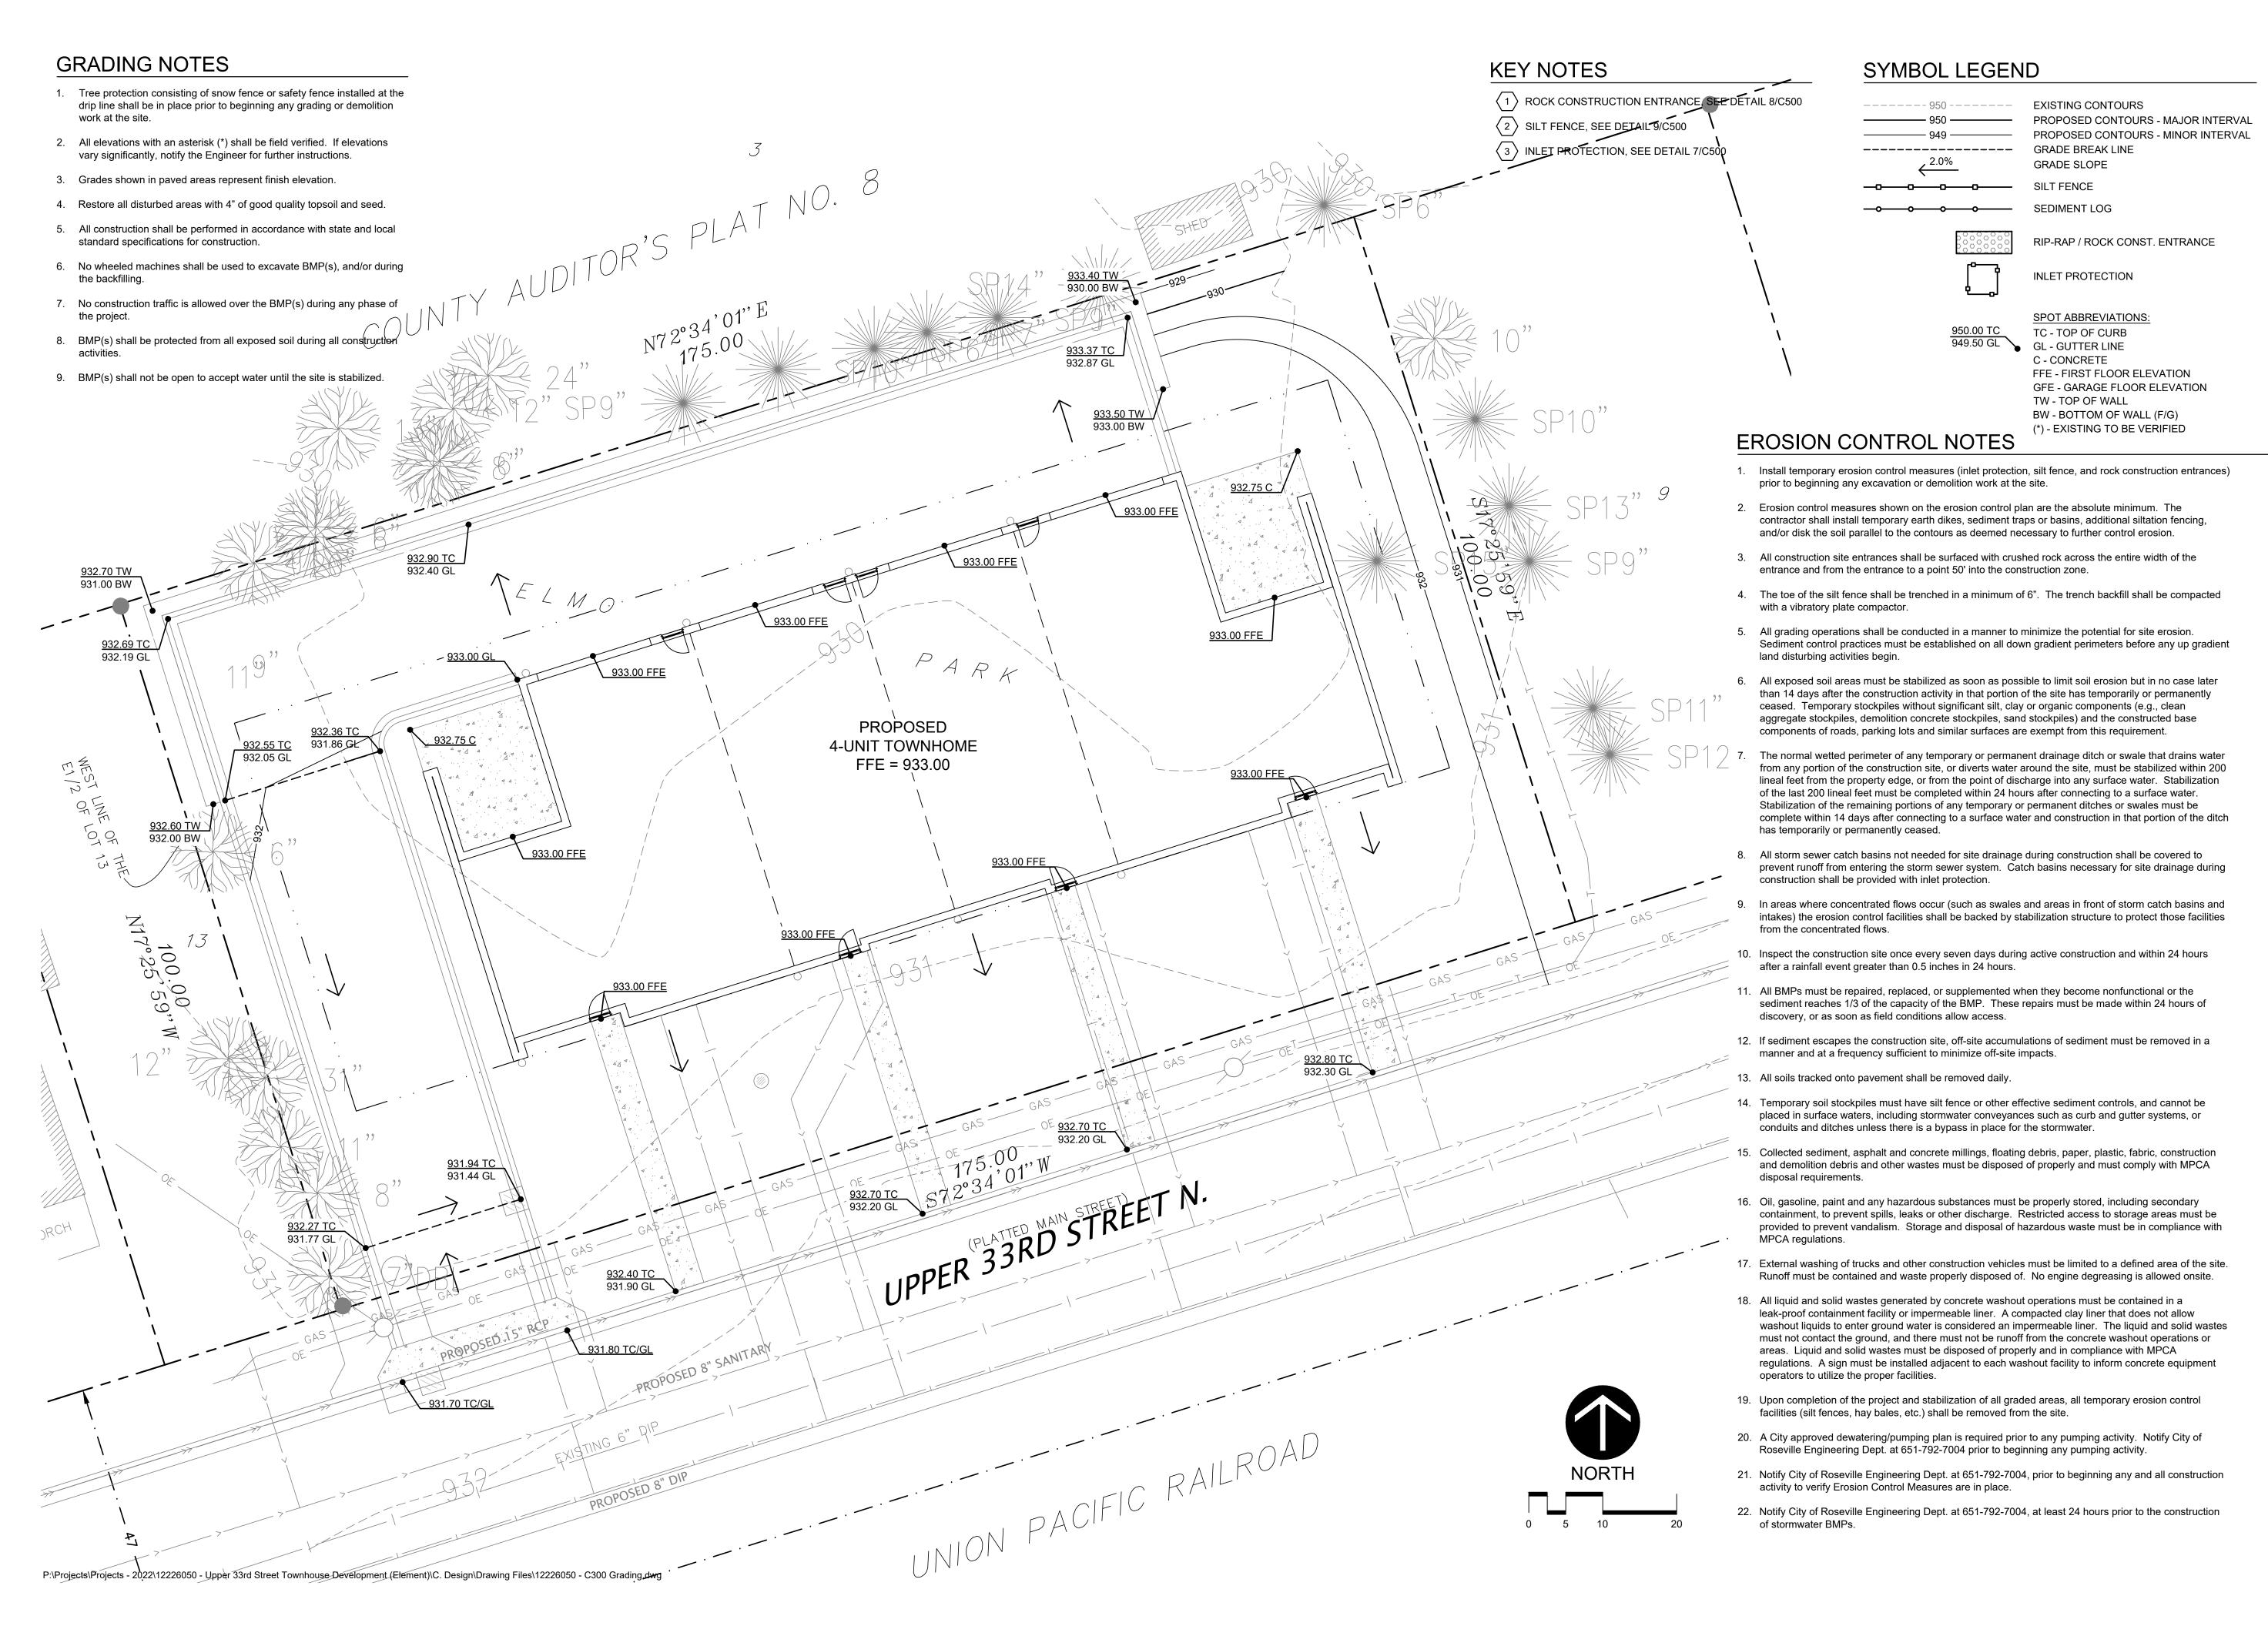

Larson Engineering, Inc 3524 Labore Road White Bear Lake, MN 55110 651.481.9120 (f) 651.481.92

ELEMENT

DESIGN-BUILD

RAYMOUND AVENUE, UNIT

UPPER 33RD STREET TOWNHOUSE DEVELOPMENT

I hereby certify that this plan, specifications or report was prepared by me or under my direct supervision and that I am a duly licensed Professional Engineer under the laws of the state of Minnesota.

Matthew J. Woodruff, P.E.

Date: 11.03.22 Lic. No.:

Description

Rev. Date

Project #: 12226050


Drawn By: TJR

Checked By: MJW

Checked By: MJW
Issue Date: 11.03.22
Sheet Title:

GRADING AND EROSION CONTROL PLAN

C300

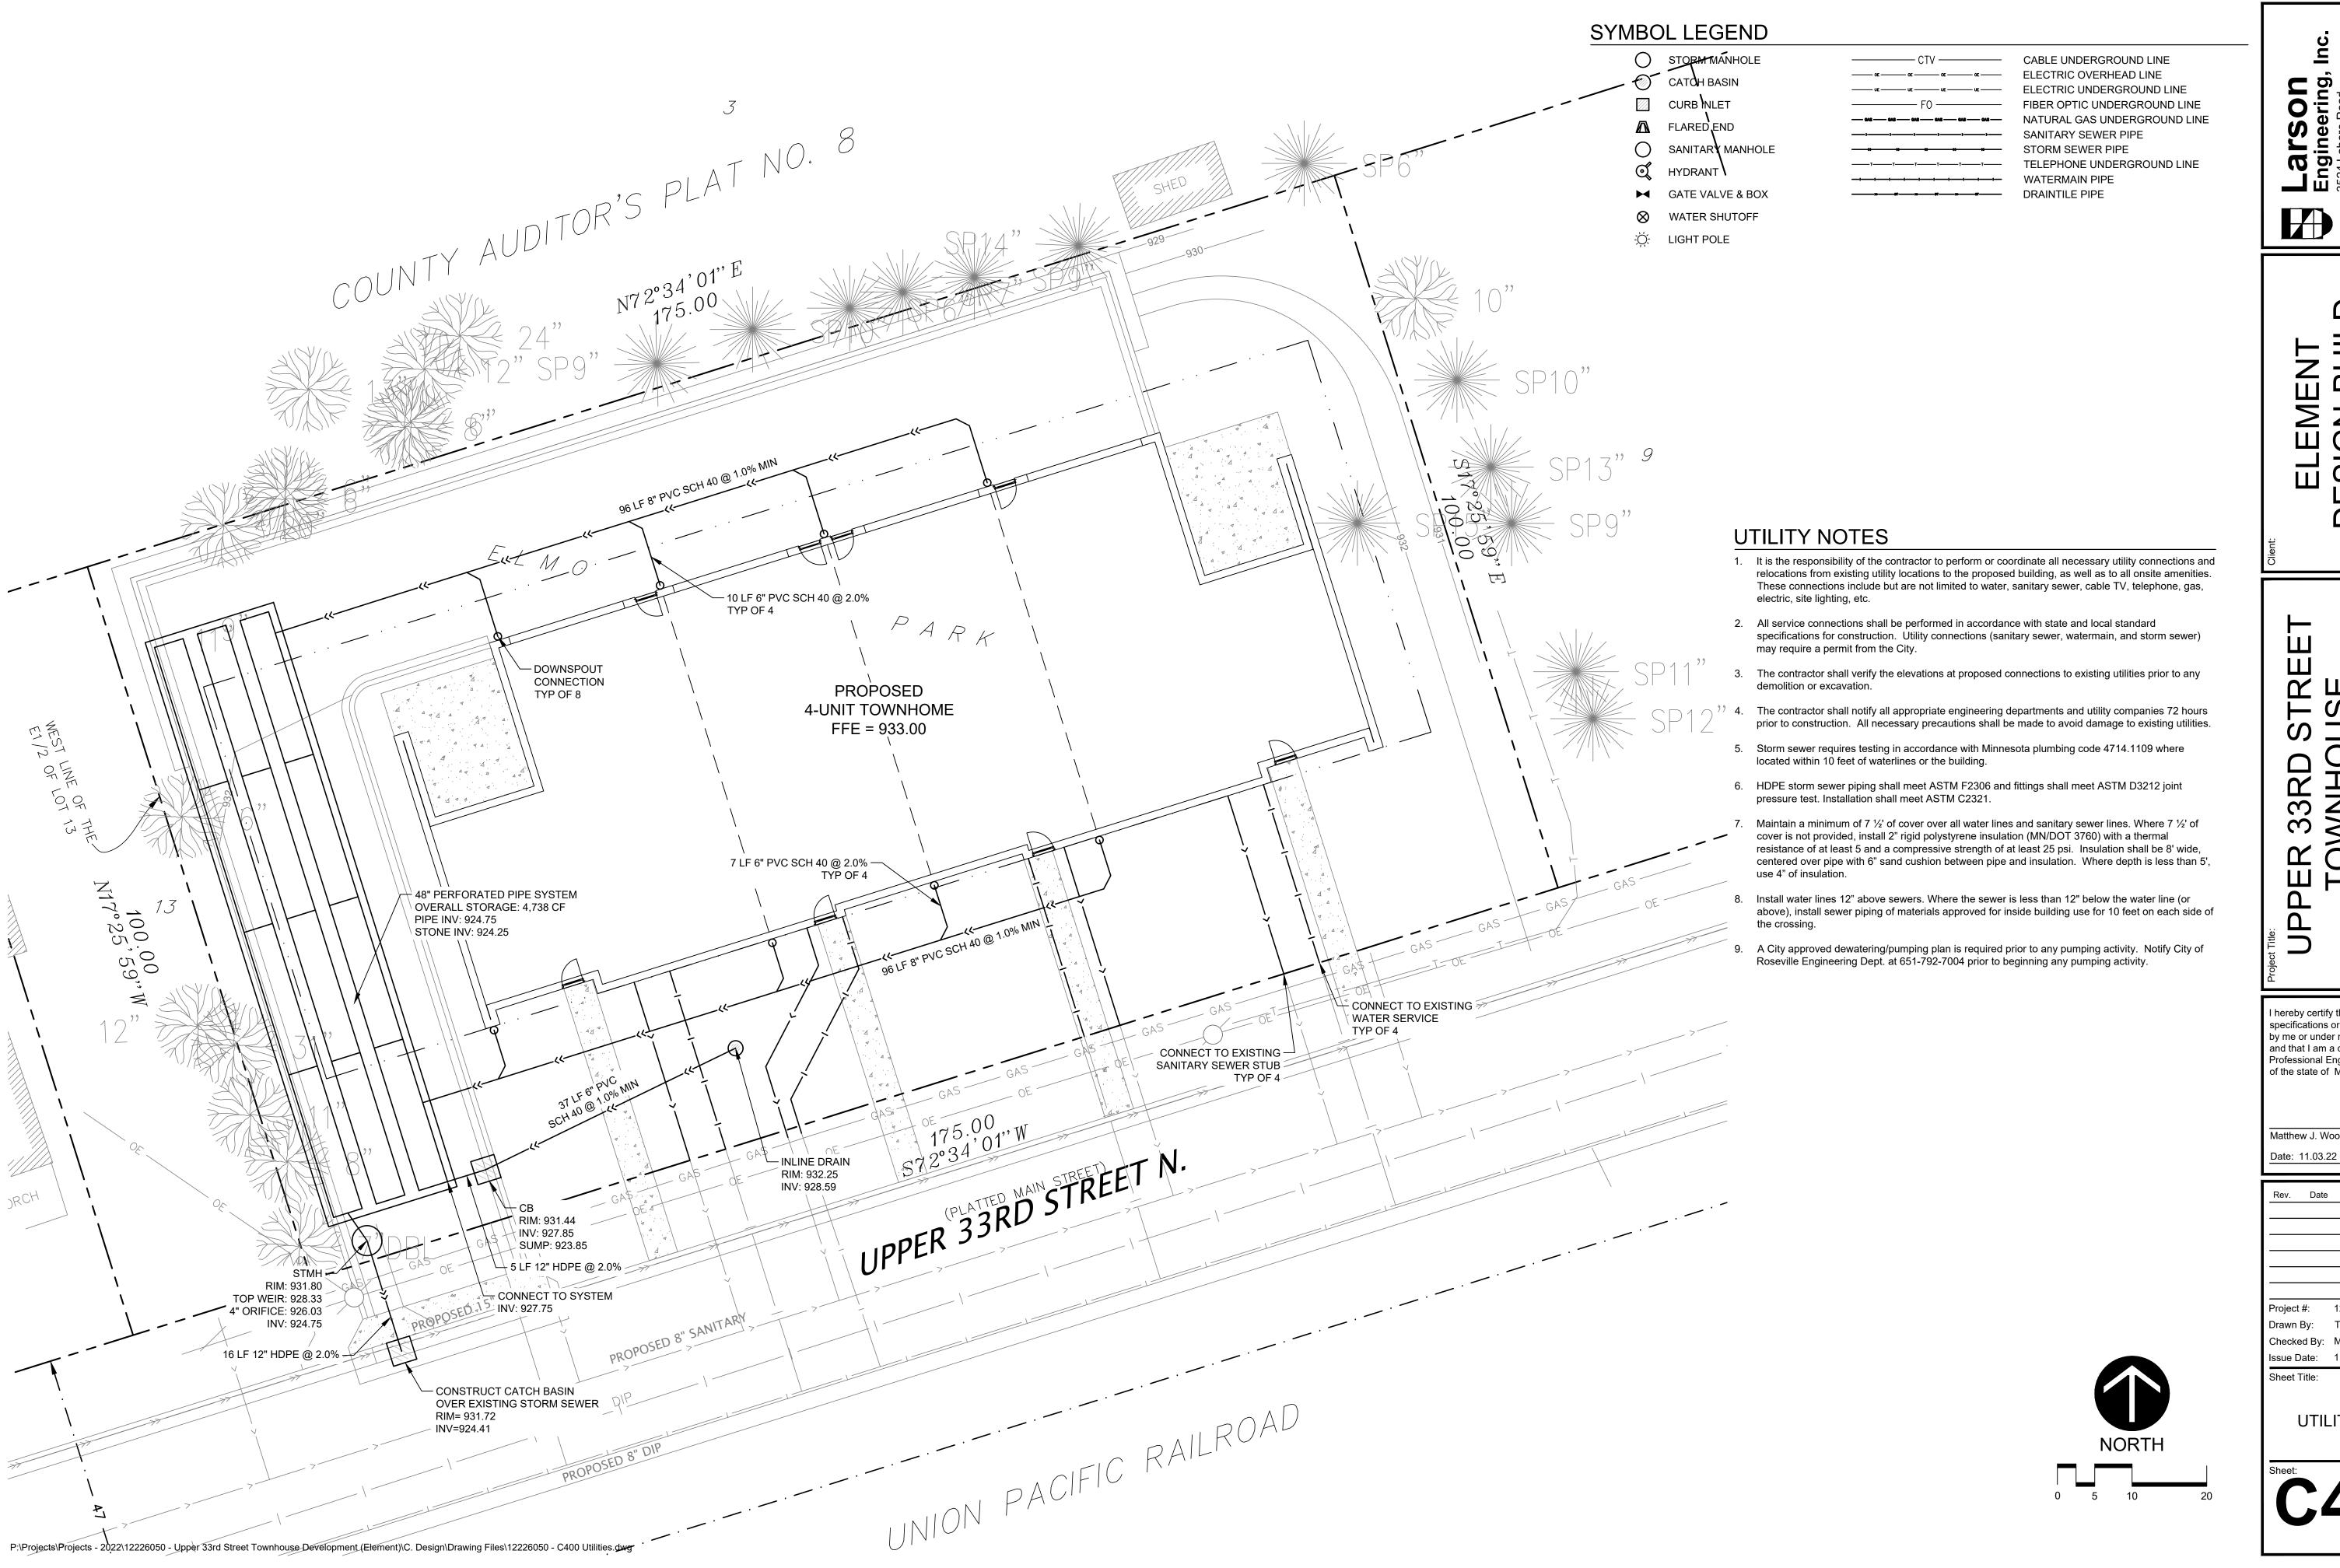

SON ering,



STRE


I hereby certify that this plan, specifications or report was prepared by me or under my direct supervision and that I am a duly licensed Professional Engineer under the laws of the state of Minnesota.

Matthew J. Woodruff, P.E. Date: 11.03.22 Lic. No.:


Description

| Project #: | 12226050 |
|----------------|----------|
| Drawn By: | TJR |
| Checked By: | MJW |
| Issue Date: | 11.03.22 |

UTILITY PLAN

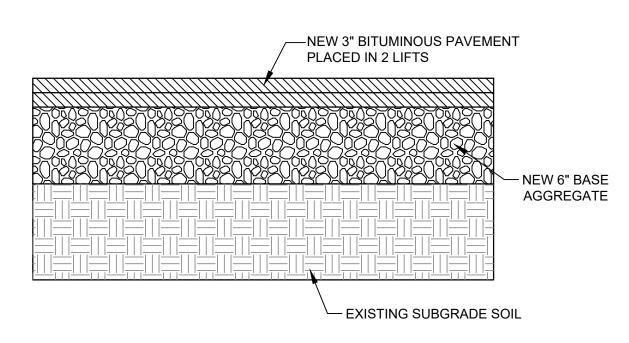


LIGHT-DUTY BITUMINOUS PAVEMENT SECTION NOT TO SCALE

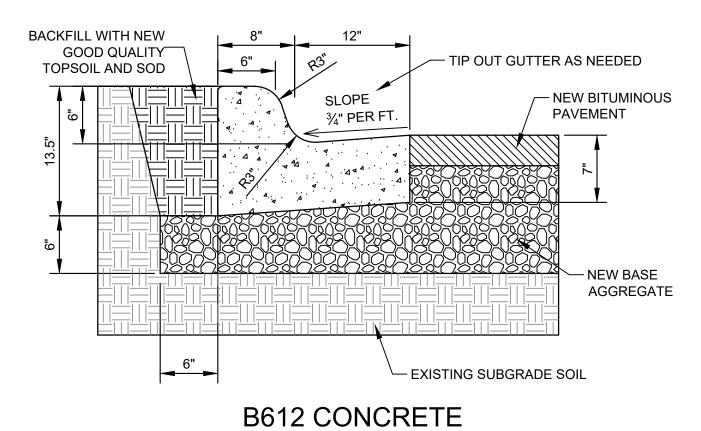


CURB & GUTTER DETAIL


NOT TO SCALE

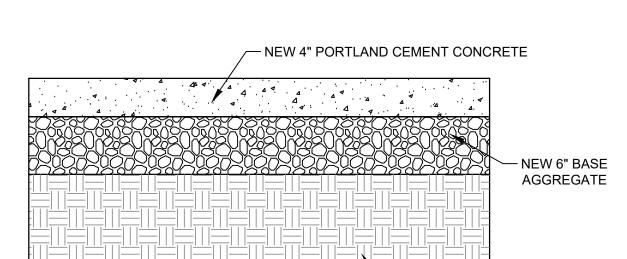


- APPROVED SUBGRADE SOIL

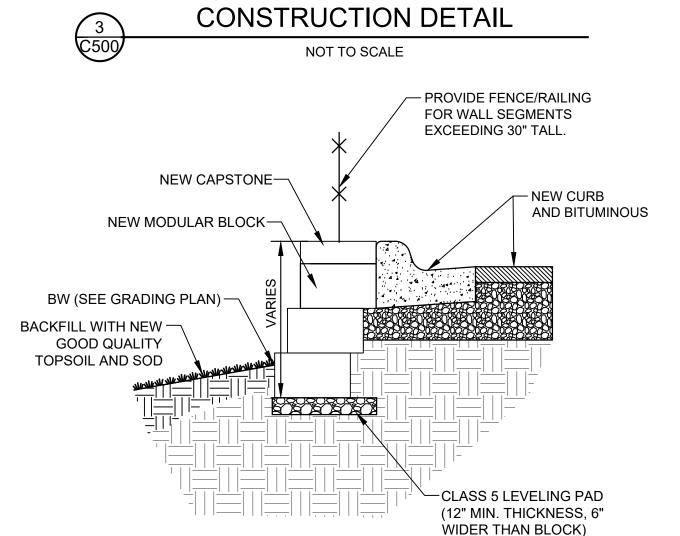

CONCRETE SIDEWALK

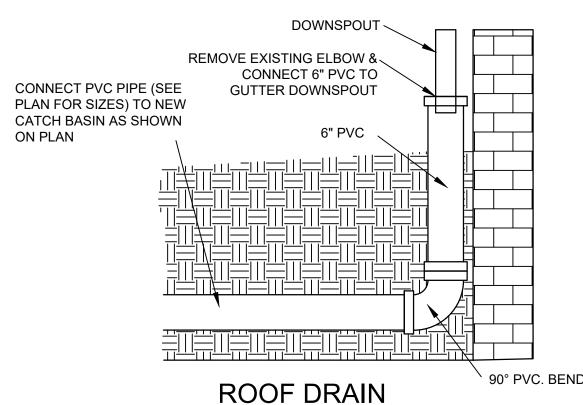

NOT TO SCALE

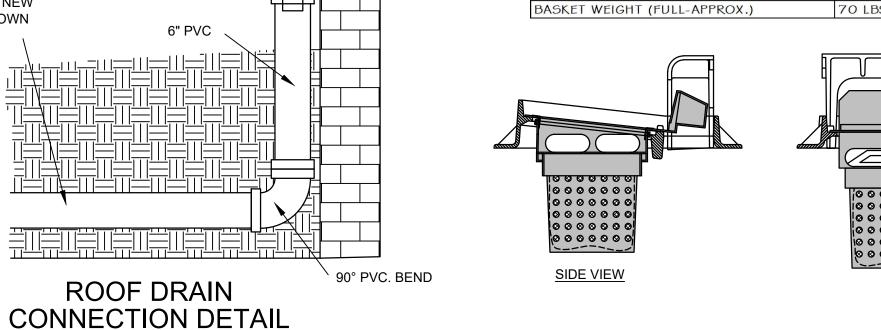


FILTER AREA


OVERFLOW AREA

BASKET WEIGHT (EMPTY)

MAXIMUM OVERFLOW RATE (@ 7" HEAD)

MAXIMUM OVERFLOW RATE (@ 13" HEAD) 4.00 CFS

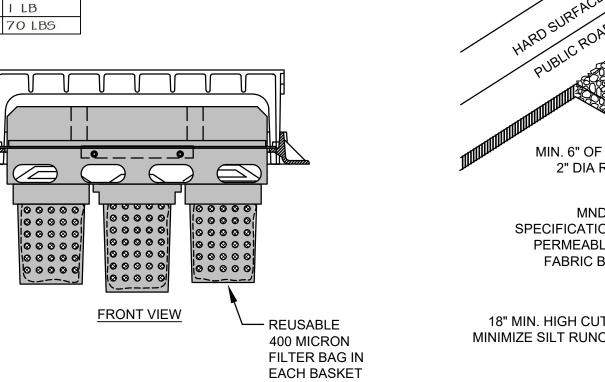

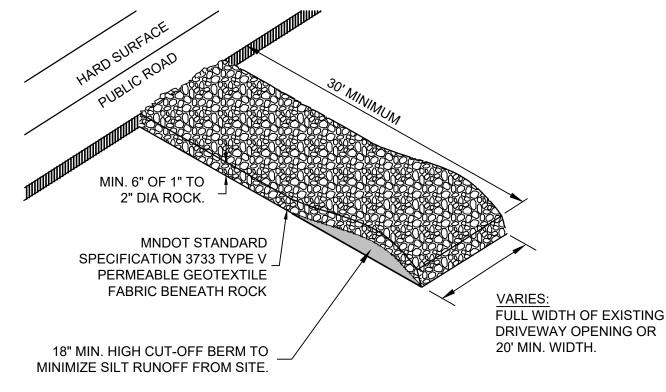

ROCK CONSTRUCTION ENTRANCE NOT TO SCALE


INFRASAFE INLET PROTECTION DEVICE (OR EQUAL)

6.5 FT²

0.6 FT²

3.00 CFS


C500 NOT TO SCALE

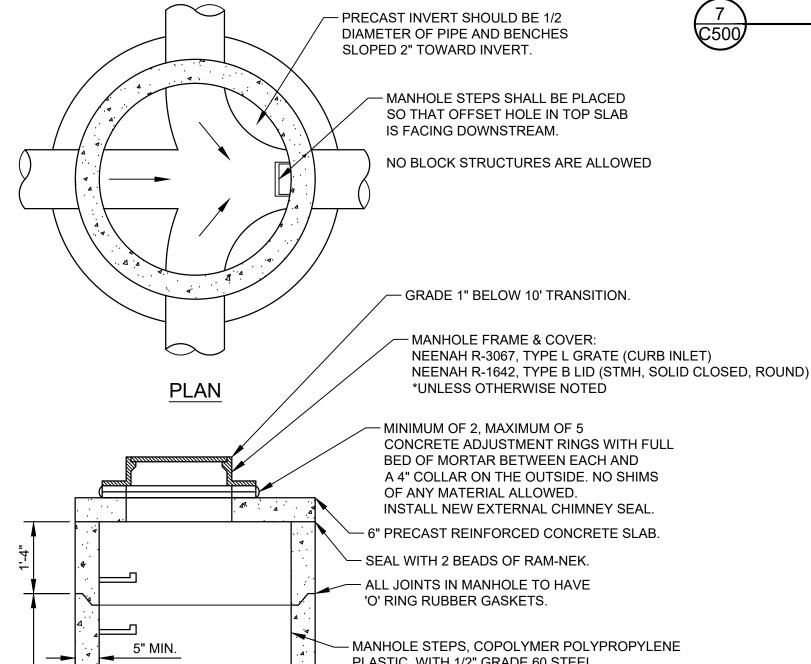

PLASTIC, WITH 1/2" GRADE 60 STEEL REINFORCEMENT OR EQUAL, 16" O.C. VARIABLE - PRECAST CONCRETE SECTION 8" PRECAST SEGMENTAL CONCRETE BLOCK TO TOP OF THE PIPE SHALL BE USED WITH SIZE AND DEPTH PROHIBIT THE FABRICATION OF PRECAST UNITS. - 8" MINIMUM SLAB THICKNESS, 6' MINIMUM DIAMETER PRECAST CONCRETE SLAB, REINFORCED WITH #4 REBAR @ 8" E.W. - GROUT BOTTOM WATERTIGHT CONNECTION SECTION (BOOT/GROUT RING, TYPICAL)


CATCH BASIN MANHOLE DETAIL 6 C500 NOT TO SCALE

. 4

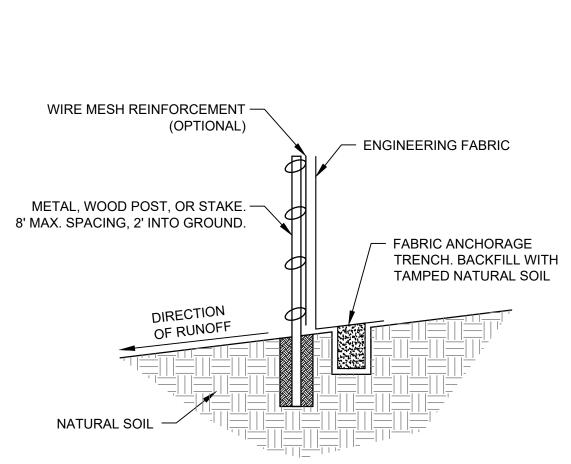

NOTE: DEPENDING UPON CONFIGURATION, ATTACH FABRIC TO WIRE MESH WITH HOG RINGS, STEEL POSTS WITH WIRES, OR WOOD POSTS WITH STAPLES.

SILT FENCE **INSTALLATION DETAIL** 9 C500 NOT TO SCALE

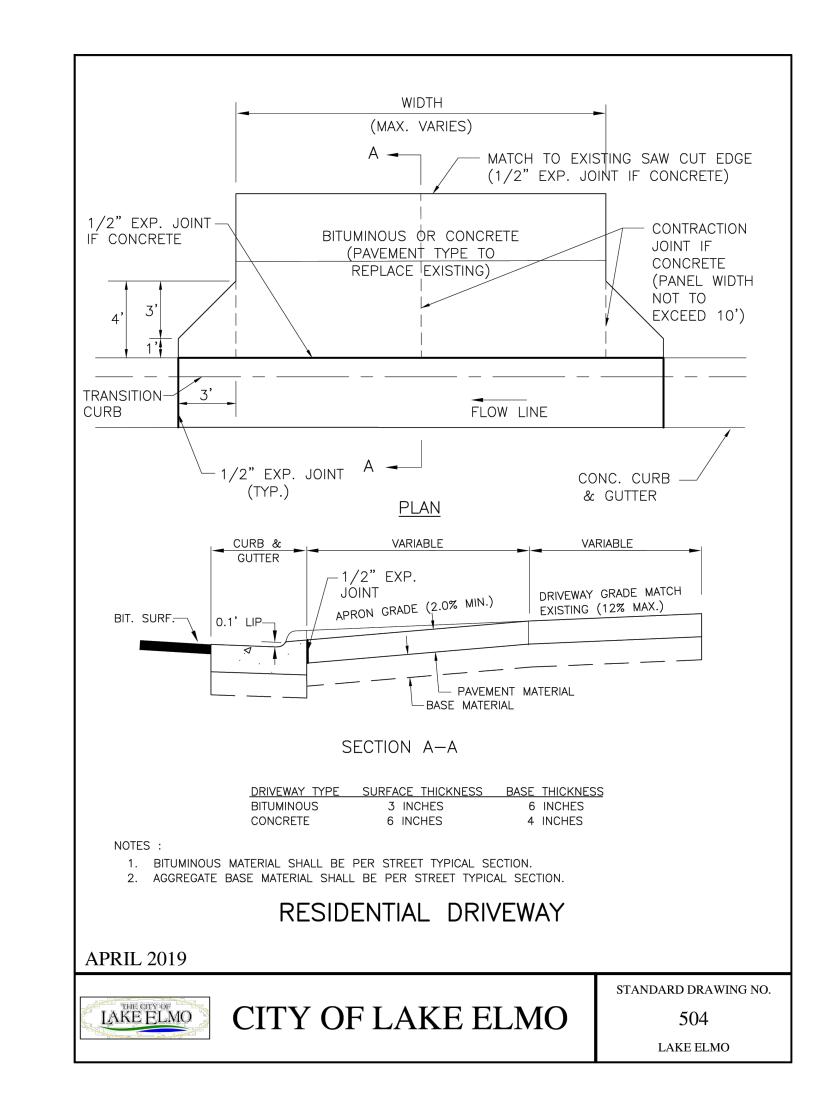





SIGN-BUII

TRE

I hereby certify that this plan, specifications or report was prepared by me or under my direct supervision and that I am a duly licensed Professional Engineer under the laws of the state of Minnesota.

Matthew J. Woodruff, P.E. Date: 11.03.22 Lic. No.:


Rev. Date Description

Project #: 12226050 TJR Drawn By: Checked By: MJW Issue Date: 11.03.22 Sheet Title:

DETAILS

RETAINING WALL DETAIL

NOT TO SCALE

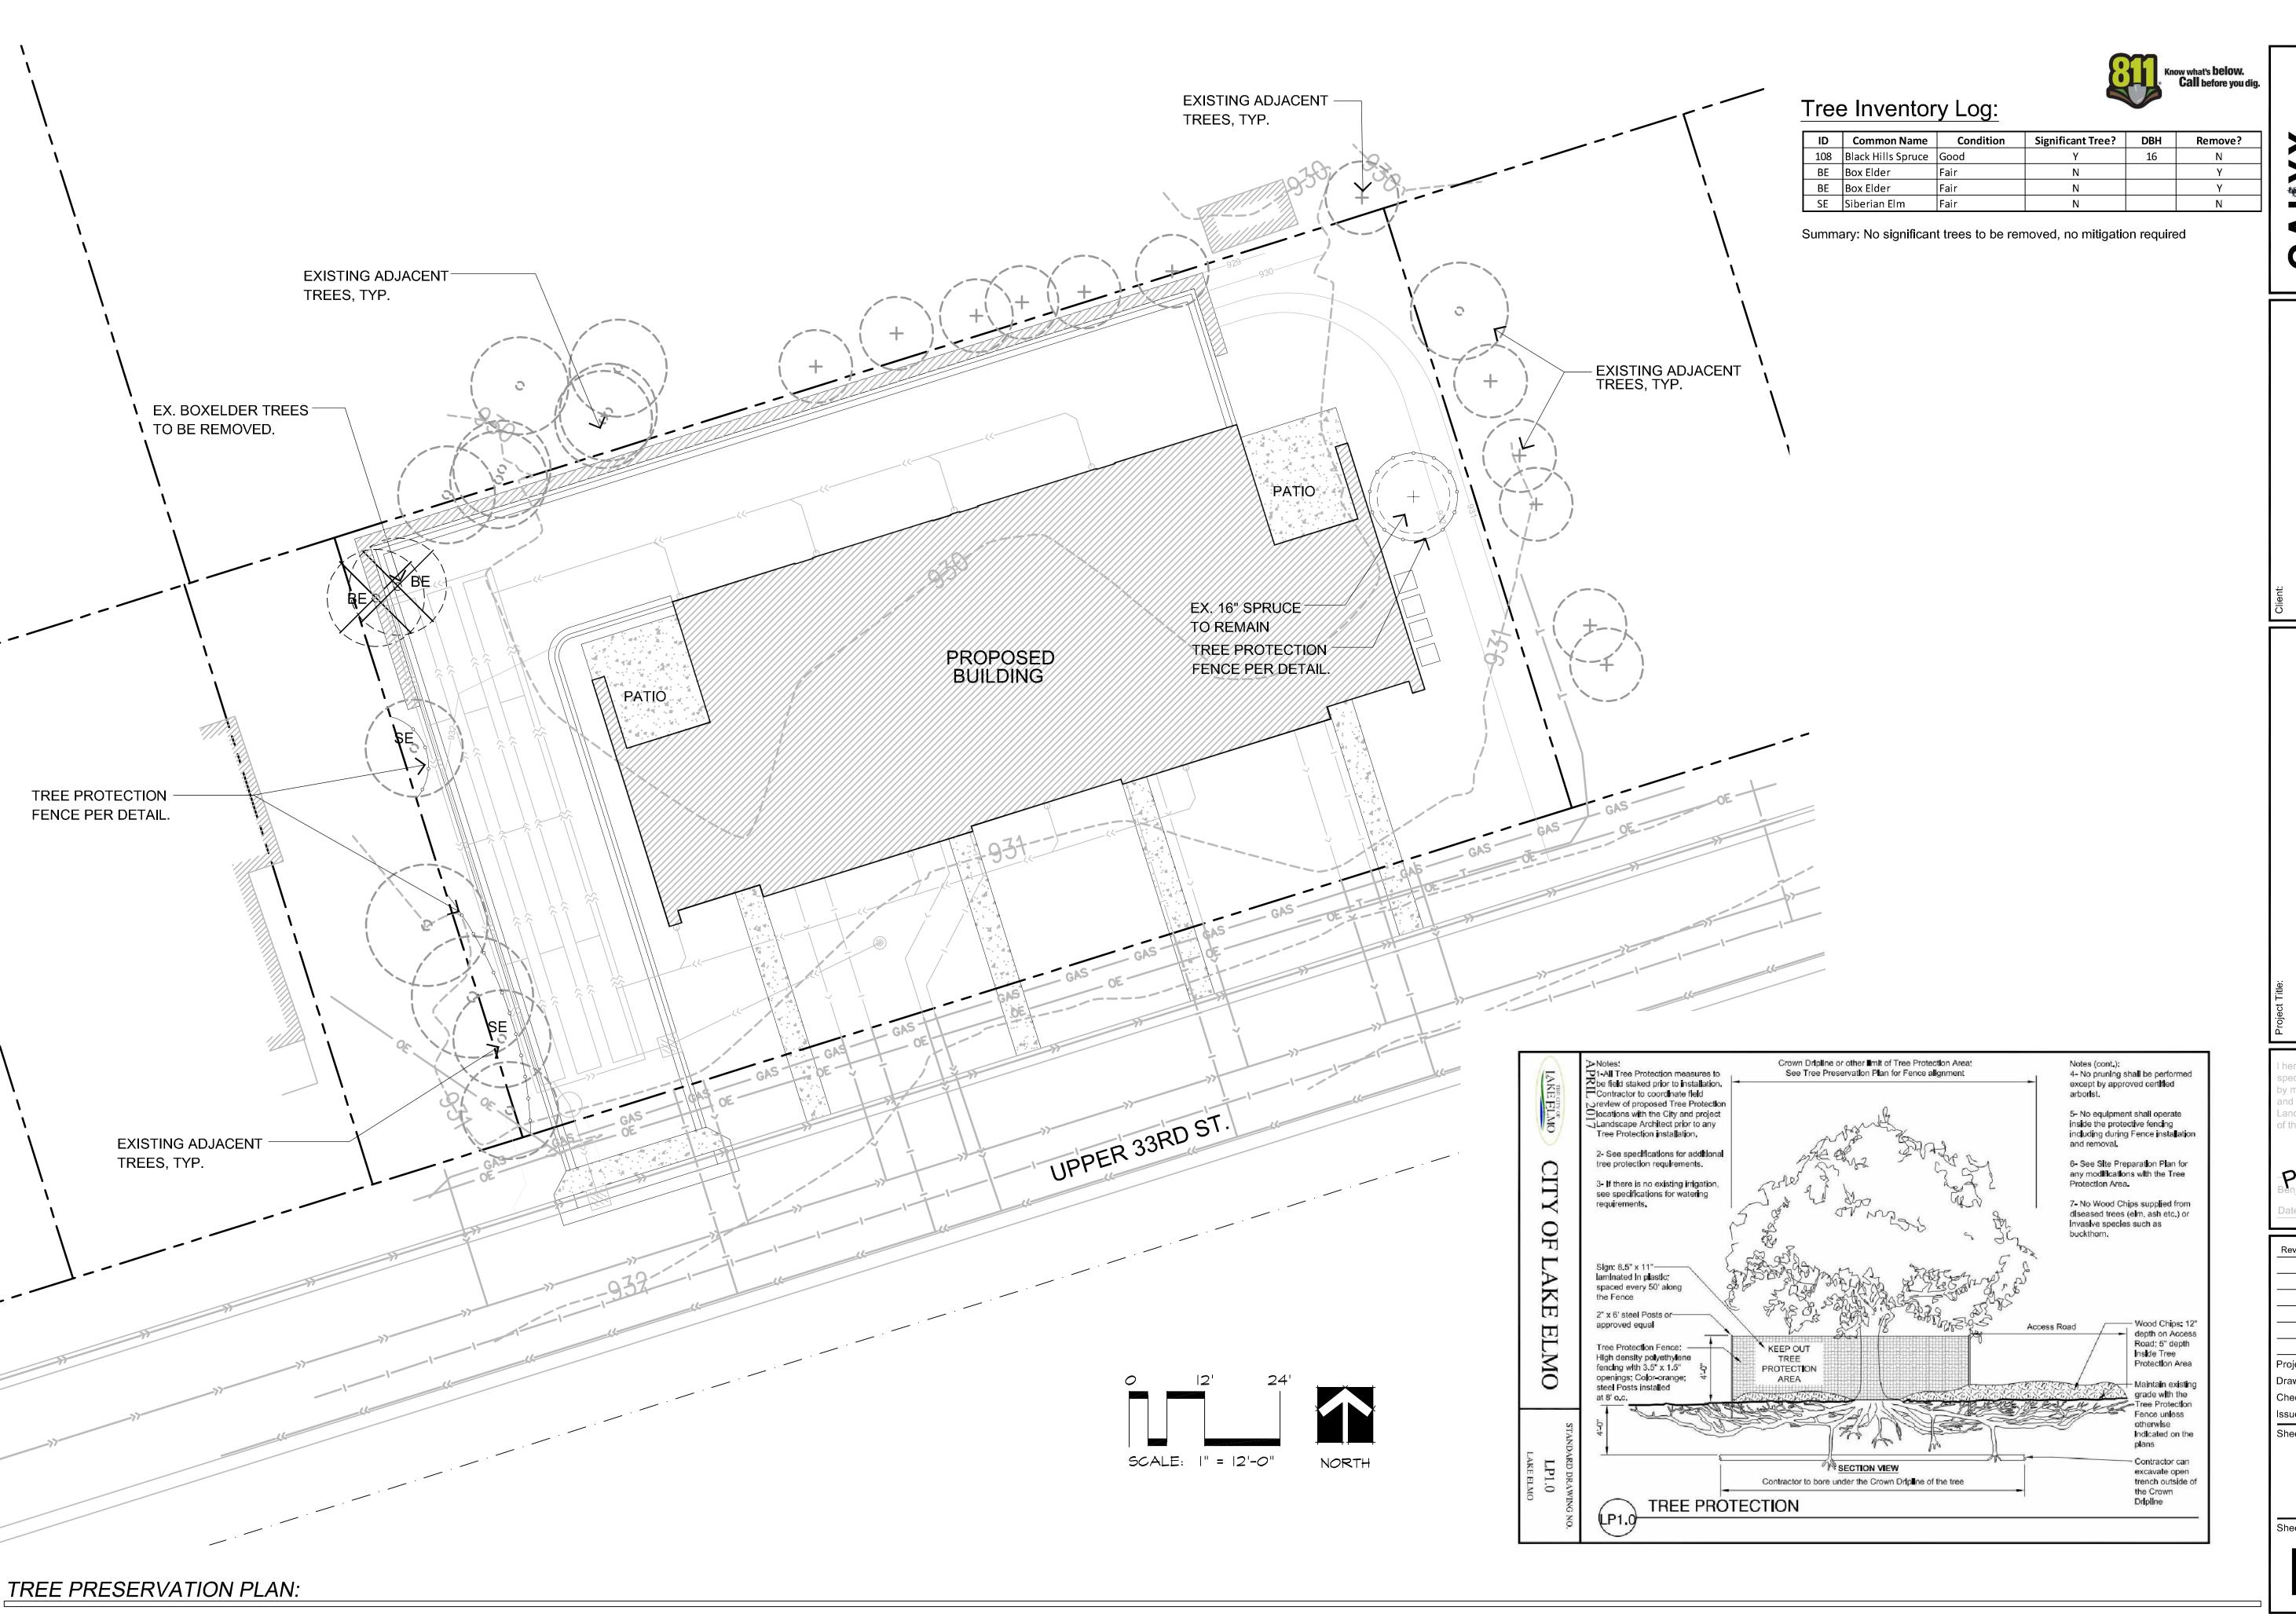


PER 33RD STREET
TOWNHOUSE
DEVELOPMENT

hereby certify that this plan andscape Architect under the laws of the State of MINNESOTA.

Rev. Date Description

Project # 12226050 Drawn By: HL Checked By: BH Issue Date: 11.22.2022 Sheet Title:

PRESERVATION PLAN

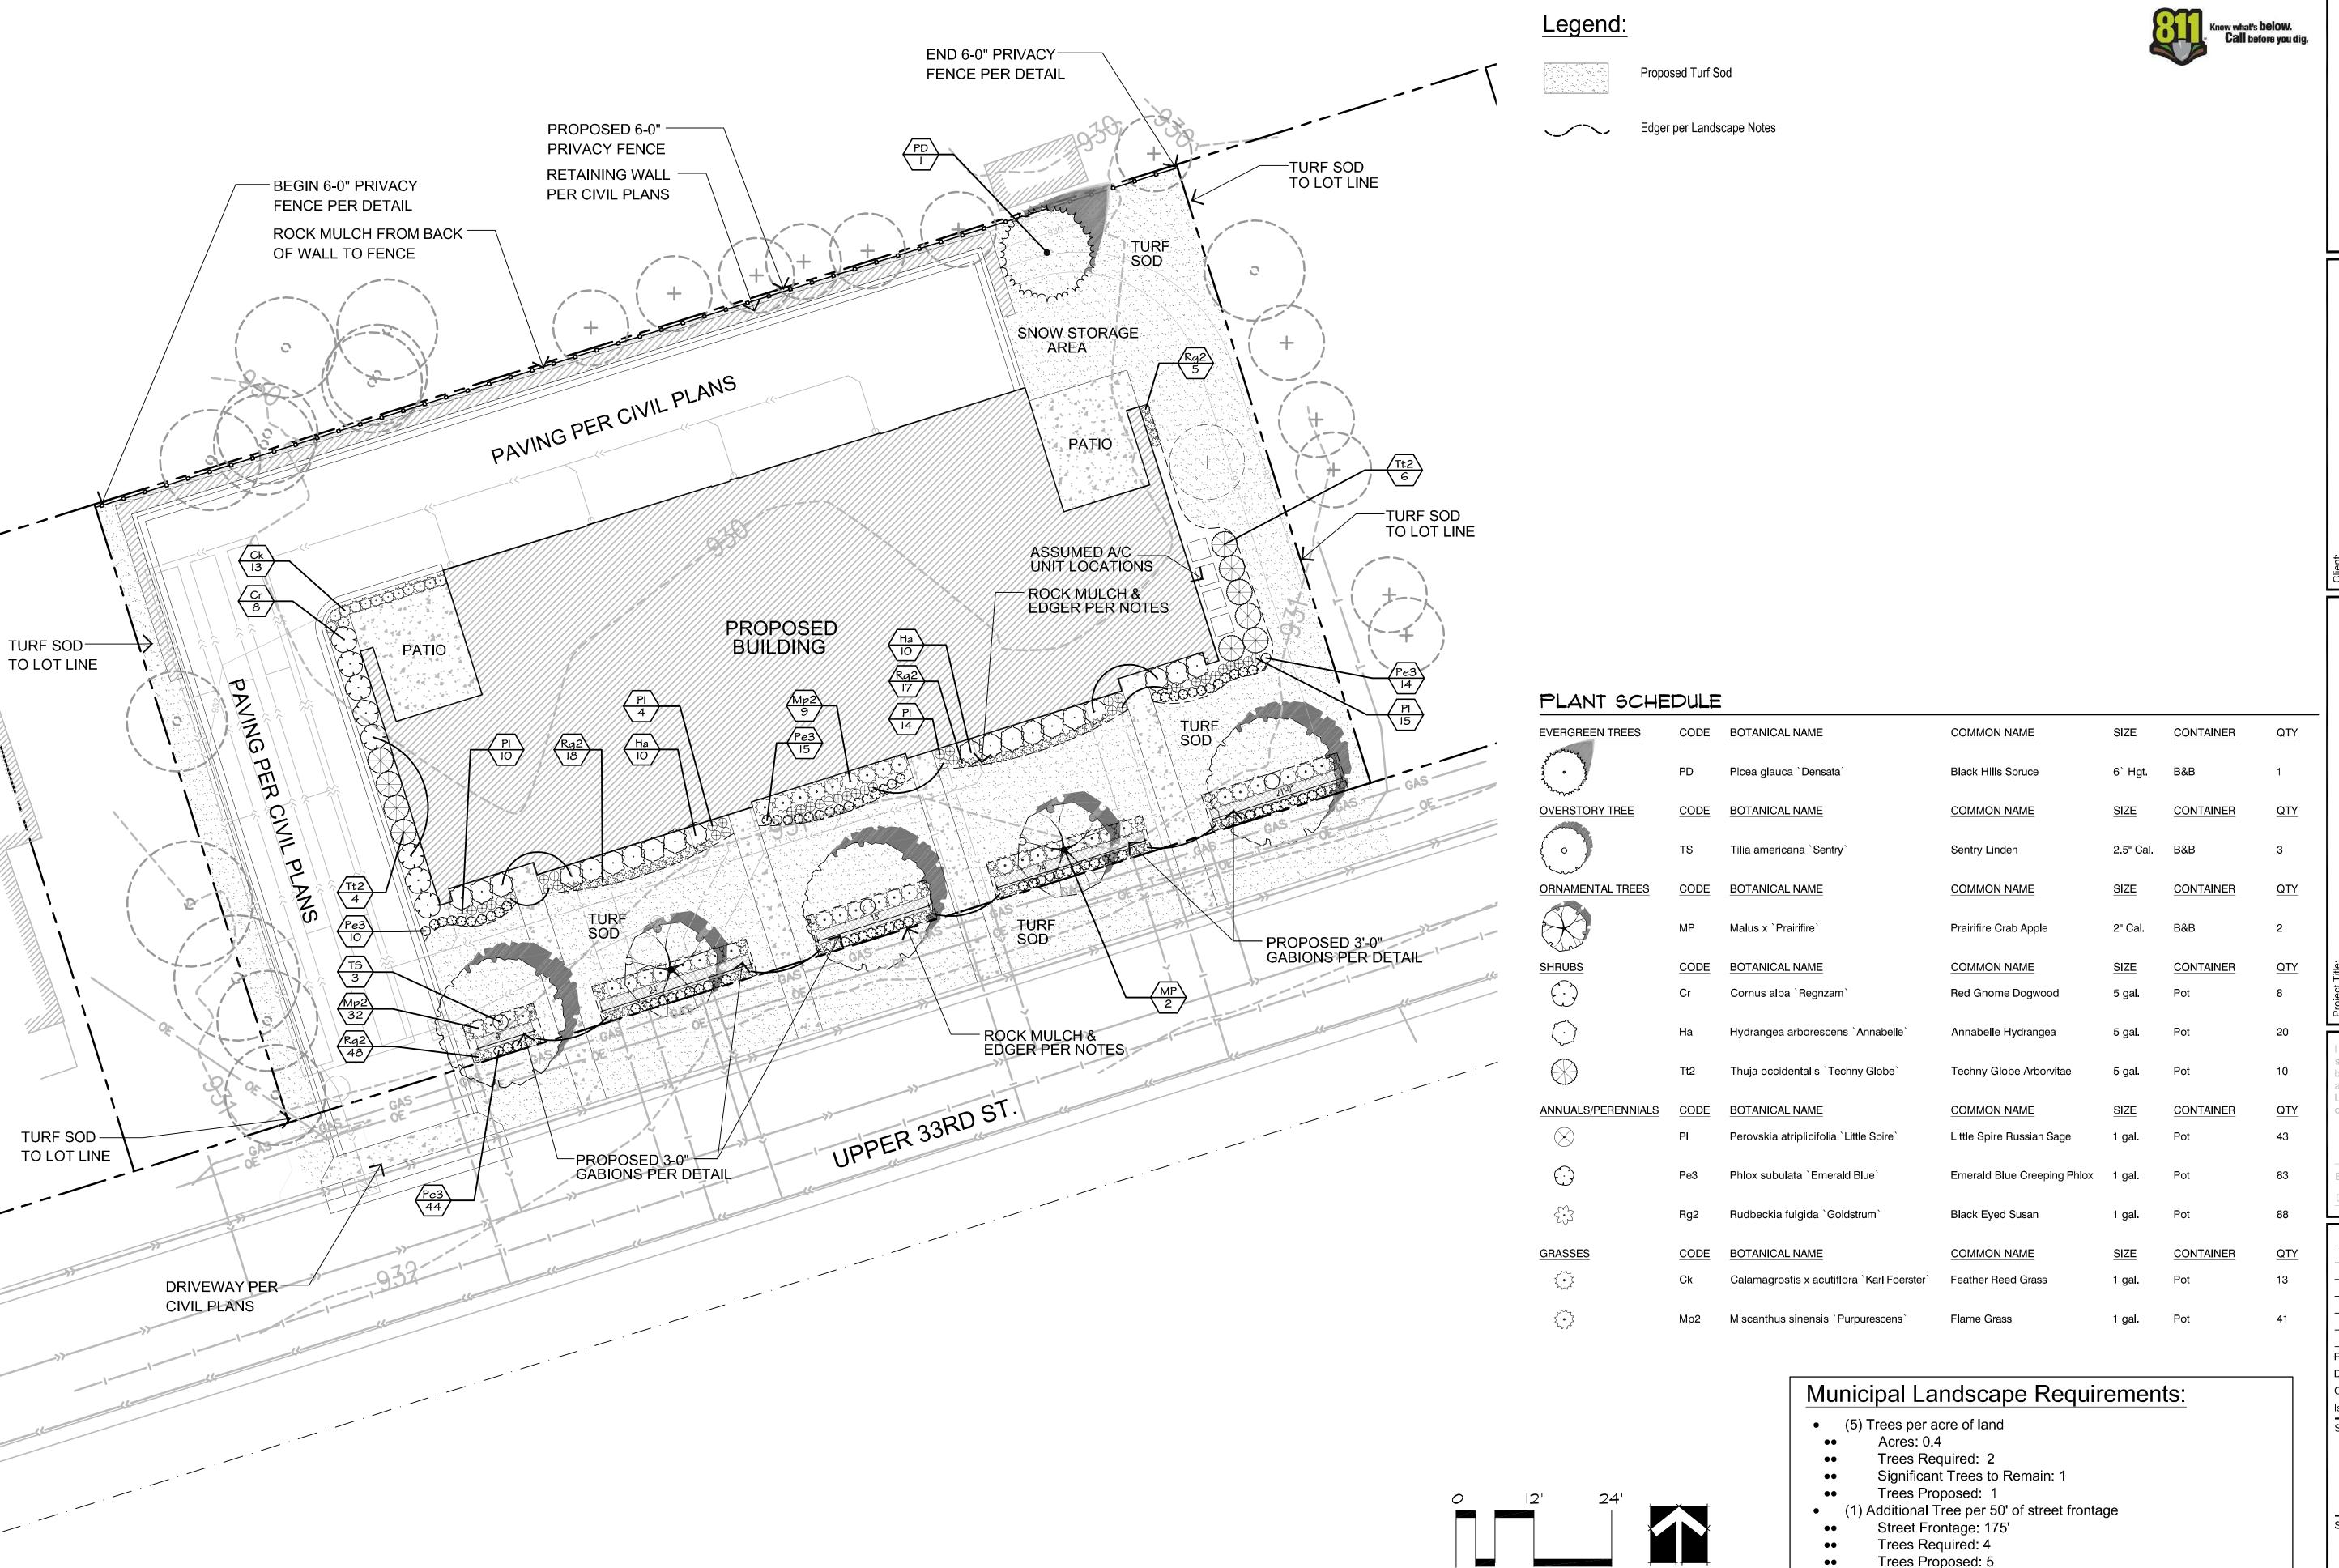

LANDSCAPE LAYOUT PLAN:

SCALE: |" = |2'-0"

NORTH

DESIGN GROUP

Landscape Architecture | Plan

ELEMENT
DESIGN-BUILD
110 RAYMOND AVENUE, UNIT 3

UPPER 33RD STREET
TOWNHOUSE
DEVELOPMENT

I hereby certify that this plan, specifications or report was prepare by me or under my direct supervision and that I am a duly licensed Landscape Architect under the laws of the State of MINNESOTA.

Benjamin Hartberg, PLA

Date: Lic. No.:

Rev. Date Description

Project#: 12226050
Drawn By: HL
Checked By: BH
Issue Date: 11.22.2022


Sheet Title:

LANDSCAPE PLAN


Sheet:

L200

1 TYP. MULCH DETAIL
1 200 NOT TO SCALE

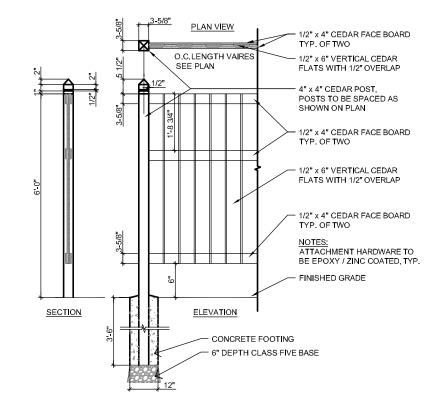



2 6'-0" WOOD PRIVACY FENCE

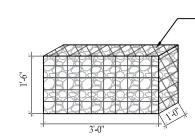

— 1' x 1.5' x 3' GALVANIZED WIRE GABIONS FILLED WITH 3"-6" TRAP ROCK. CONTRACTOR TO ENSURE ROCK IS A MINIMUM OF 2X LARGER THAN THE WIRE GABION HOLES SO THAT ROCK CANNOT BE REMOVED FROM THE GABIONS ONCE INSTALLED. GABIONS AND ROCK AVAILABLE LOCALLY THROUGH HEDBERG SUPPLY.
TOP OF WALL NOTE: OWNER'S OPTION TO HAVE A PRECAST CAP OR MANUFACTURED GABION FINISH

SINGLE GABION CAGE: AXONOMETRIC

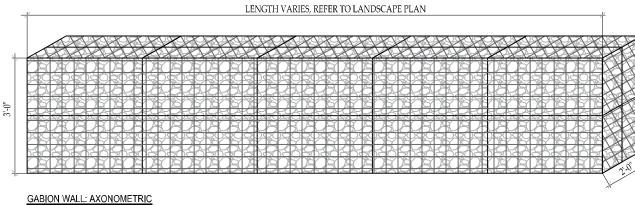

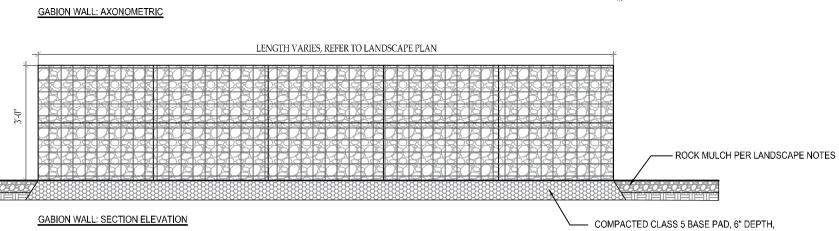



3 36" TALL ROCK-FILLED GABIONS
L200 NOT TO SCALE




General Notes:

- 1. See Civil Engineer's plans for site plan layout and dimensions.
- 2. Contractor to coordinate any work in the city right-of-way with City of Lake Elmo Public Works Department.
- 3. Refer to Sheet L100 for Tree Preservation Plan, L200 for Landscape Plan, and L300 for Landscape Details

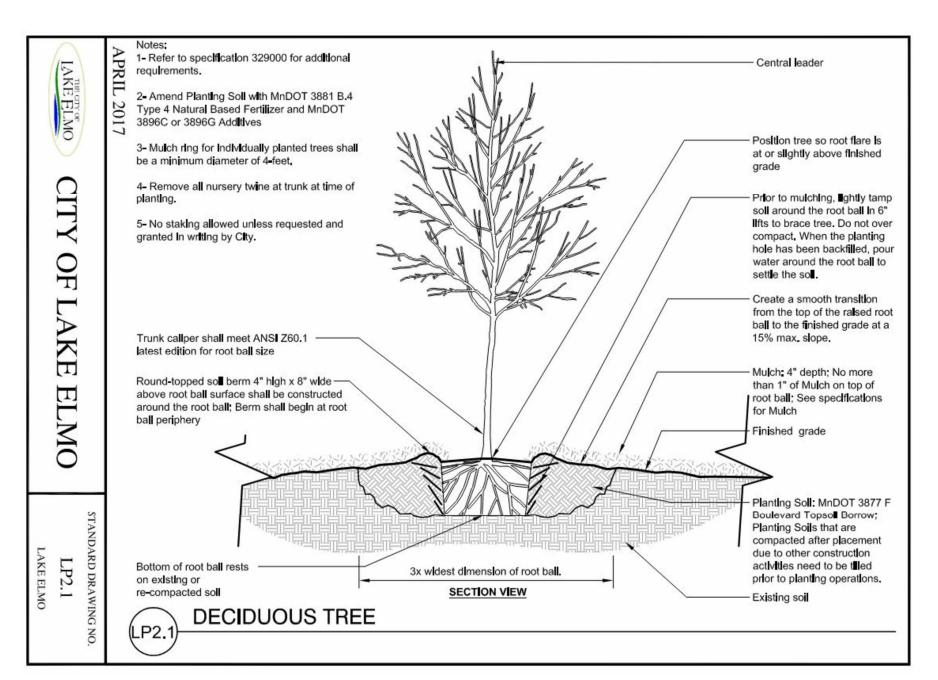

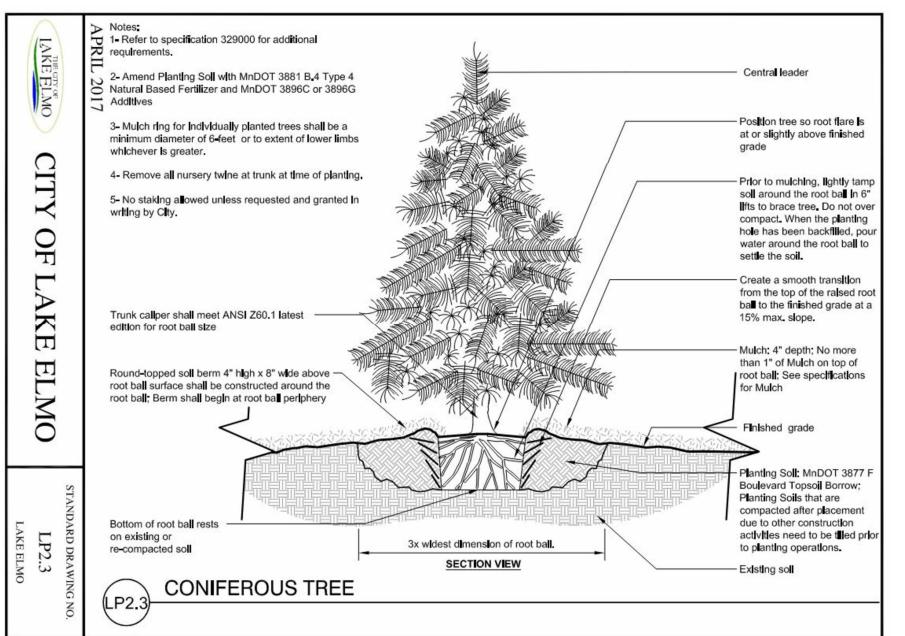

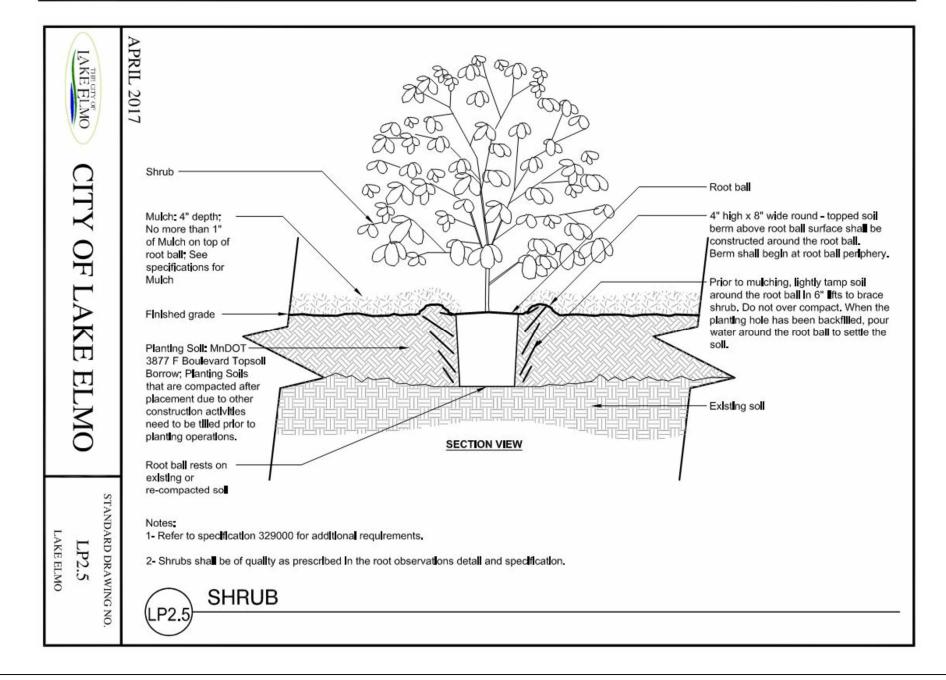

Landscape Notes and Requirements:

- 1. Tree saucer for individual trees outside of a plant bed to be four inches (4") depth natural Western Red Cedar mulch for trees outside of a plant bed. Install per tree planting detail. Do not place mulch against tree trunk. Remove wire and burlap from top third of root ball before final soil back-fill and mulch.
- 2. Refer to civil plan sheets for grading, drainage, site dimensions, survey, tree removal, proposed utilities & erosion control.
- 3. All plant material shall comply with the latest edition of the American Standard for Nursery Stock, American Association of Nurserymen. Unless noted otherwise, deciduous shrubs shall have at least 5 canes at the specified shrub height. Plant material shall be delivered as specified. All deciduous trees are measured at 48" from finished grade to determine tree diameter (DBH). All coniferous trees are measured from finished grade to the top of the central leader. If no central leader is present on coniferous trees, that plant is rejected and must be replaced immediately.
- 4. Plan takes precedence over plant schedule if discrepancies in quantities exist.
- 5. All proposed plants shall be located and staked as shown.
- 6. Adjustment in location of proposed plant material may be needed in field. Should an adjustment be required, the client will provide field approval. Significant changes may require city review and approval.
- 7. The project landscape contractor shall be held responsible for watering and properly handling all plant materials brought on the site both before and after installation. Schedule plant deliveries to coincide with expected installation time within 36 hours.
- 8. All plant materials shall be fertilized upon installation as specified.
- 9. The landscape contractor shall provide the owner with a watering schedule appropriate to the project site conditions and to plant material growth requirements.
- 10. If the landscape contractor is concerned or perceives any deficiencies in the plant selections, soil conditions, drainage or any other site condition that might negatively affect plant establishment, survival or guarantee, they must bring these deficiencies to the attention of the landscape architect & client prior to bid submission. Plant bed drainage concerns during plant installation shall be brought to the attention of the Owner and General Contractor immediately.
- 11. Contractor shall establish to his/ her satisfaction that soil and compaction conditions are adequate to allow for proper drainage at and around the building site.
- 12. Contractor is responsible for ongoing maintenance of all newly installed plant material for the duration of the warranty period. Landscape contractor is responsible for coordinating lawn mowing hand-off with the Owner after the first mowing. Any acts of vandalism or damage which may occur prior to owner acceptance shall be the responsibility of the contractor. Contractor shall provide the owner with a maintenance program including, but not limited to weed control, plant pruning, fertilization and disease/pest control beyond the first year of maintenance. See Note #22.
- 13. Warranty: The contractor shall guarantee newly planted material through one calendar year from the date of written owner acceptance. Plants that exhibit more than 20% die-back damage shall be replaced at no additional cost to the owner. The contractor shall also provide adequate tree wrap and deer/rodent protection measures for the plantings during the warranty period.
- 14. This layout plan constitutes our understanding of the landscape requirements listed in the ordinance. Changes and modifications may be requested by the city based on applicant information, public input, council decisions, etc.
- 15. The landscape contractor shall be responsible for obtaining any permits and coordinating inspections as required throughout the work
- 16. Plant size & species substitutions must be approved in writing prior to acceptance in the field.
- 17. Irrigation: The landscape contractor shall furnish an Irrigation Layout Plan for head-to-head coverage of all tree and turf planting areas. Use commercial grade irrigation equipment and provide cut-sheets and provide (3) copies of the proposed layout plan to the Civil Engineer for review and approval prior to installation. Coordinate irrigation connection point, controller, back-flow and valve locations with the architect and general contractor. Irrigation contractor to verify if a deduct meter is required and include in bid. Include (1) fall shut-down and (1) spring start-up in bid.
- 18. All edger shall be professional grade black steel edger, 1/8" thickness. Anchor every 18" on-center (minimum). Submit sample.
- 19. Landscape Contractor is responsible for coordination with the General Contractor, to protect the new improvements on and off-site during landscape work activities. Report any damage to the General Contractor immediately.
- 20. Rock mulch areas shall be $\frac{3}{4}$ " inch dia. local clean dark trap rock over weed mat. Install per detail. Submit mulch sample for approval.
- 21. All planting and sodded areas shall be prepared prior to installation activities with a harley power box rake or equal to provide a firm planting bed free of stones, sticks, construction debris, etc.
- 22. Turf Sodding shall conform to all rules and regulations as established in the MnDOT Seeding Manual, 2014 edition, for turf bed preparation, installation, maintenance, acceptability, and warranty. Turf Sod installation to include one year of maintenance in the bid price, which includes fertilization and weed control 3 times (2) applications in the first growing season and (1) application the following spring. Also, include mechanical plug aeration, which is to occur (1) time the spring following turf sod installation, including snow storage areas. An acceptable stand of turf is lush, full, and weed-free. See specifications for additional information and contractor mowing requirement.
- 23. The Landscape Contractor shall furnish samples of all landscape materials for approval prior to installation.
- 24. The Landscape Contractor shall clear and grub the underbrush from within the work limits to remove dead branches, leaves, trash, weeds and foreign materials.
- 25. The landscape contractor shall contact Gopher State One Call no less than 48 hours before digging for field utility locations.
- 26. The landscape contractor shall be responsible for the removal of erosion control measures once vegetation has been established to the satisfaction of the municipal staff. This includes silt curtain fencing and sediment logs placed in the landscape.
- 27. The landscape contractor shall be responsible for visiting the site to become familiar with the conditions prior to bidding and installation. Coordinate with the general contractors on matters such as fine grading, landscaped area conditions, staging areas, irrigation connection to building, etc.
- 28. See Site and Civil plans for additional information regarding the project, including infiltration area soils and sub-surface drainage requirements and performance.
- 29. Topsoil Requirements: All graded areas of the site that are designated on the plan set for turf sod shall have no less than 6" of imported top soil, areas designated for shrubs, trees, and perennials shall have no less than 12" of imported top soil, meeting MnDOT classifications for planting soil for trees, shrubs, and turf. Slope away from building.
- 30. Landscape contractor must prove the open sub-grade of all planting areas after their excavation is capable of infiltrating a minimum requirement of 1/4-inch of water per hour prior to installation of plant materials, topsoil, irrigation, weed mat, and mulch. Planting areas not capable of meeting this requirement shall have 4" diameter X 48" depth holes augured every 36" on-center and filled with MnDOT Free-Draining Coarse Filter Aggregate. Re-test sub-grade percolation for compliance to infiltration minimum requirement.
- 31. Landscape contractor to provide nursery pull list (bill of lading) including plant species and sizes shipped to the site. Additionally, the landscape contractor shall provide nursery stock traceability, proving none of the materials provided contain or are genetic strains of the neonicotinoid family including acetamiprid, clothianidin, imidacloprid, nitenpyram, nithiazine, thiacloprid and thiamethoxam.

32.Landscape contractor shall apply granular Preen pre-emergent herbicide in all wood mulch areas immediately following installation and again the following spring.

CAL**

DESIGN GROUP

Landscape Architecture | Plann

ELEMENT
DESIGN-BUILD
10 RAYMOND AVENUE, UNIT

UPPER 33RD STREE TOWNHOUSE DEVELOPMENT

I hereby certify that this plan, specifications or report was prepare by me or under my direct supervision and that I am a duly licensed Landscape Architect under the laws of the State of MINNESOTA.

PRELIMINA

Benjamin Hartberg, PLA

Date: Lic. No.:

| Rev. | Date | Description |
|------|------|-------------|
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| | | |
| | | |

Project #: 12226050
Drawn By: HL

Checked By: BH


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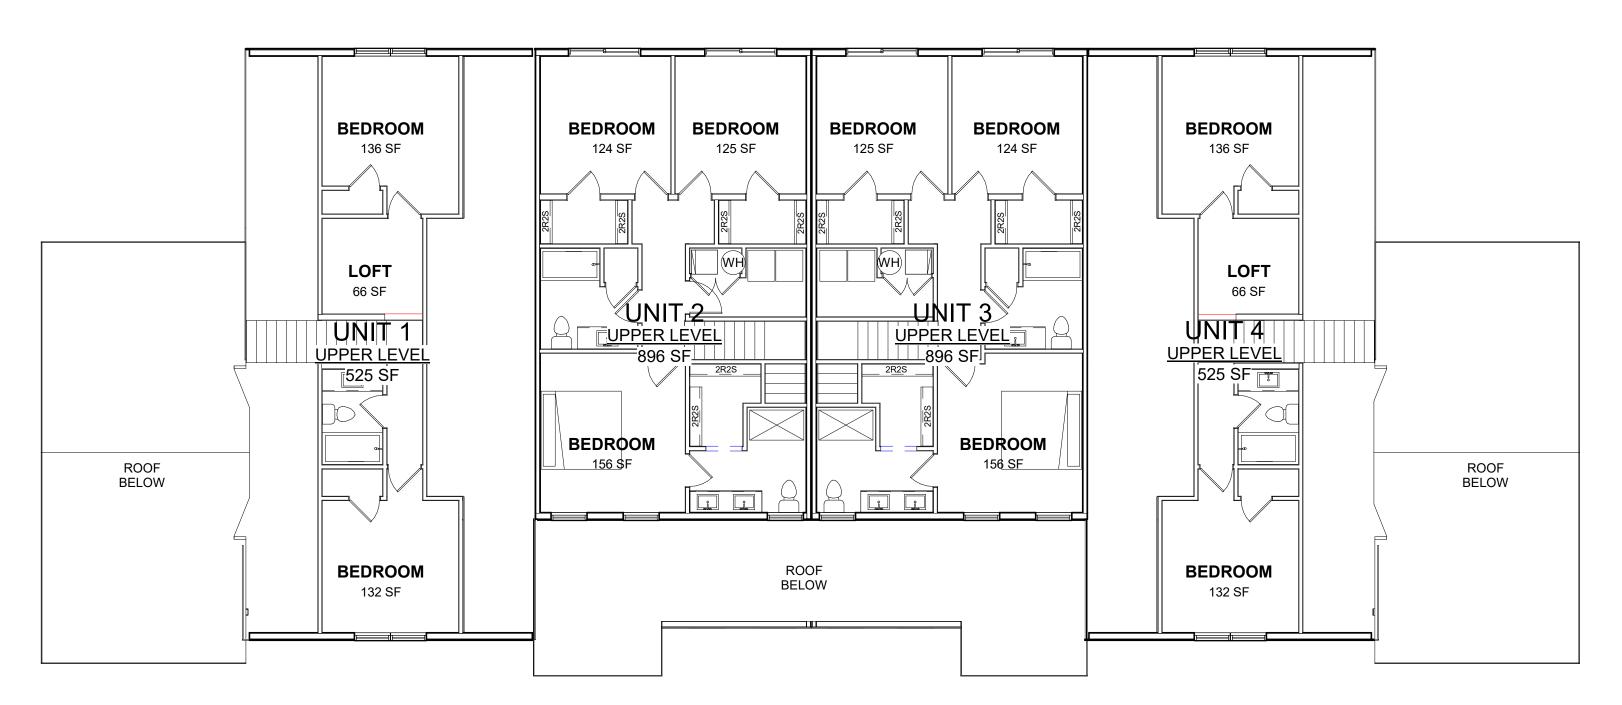
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LANDSCAPE DETAILS


Shoot:

L300





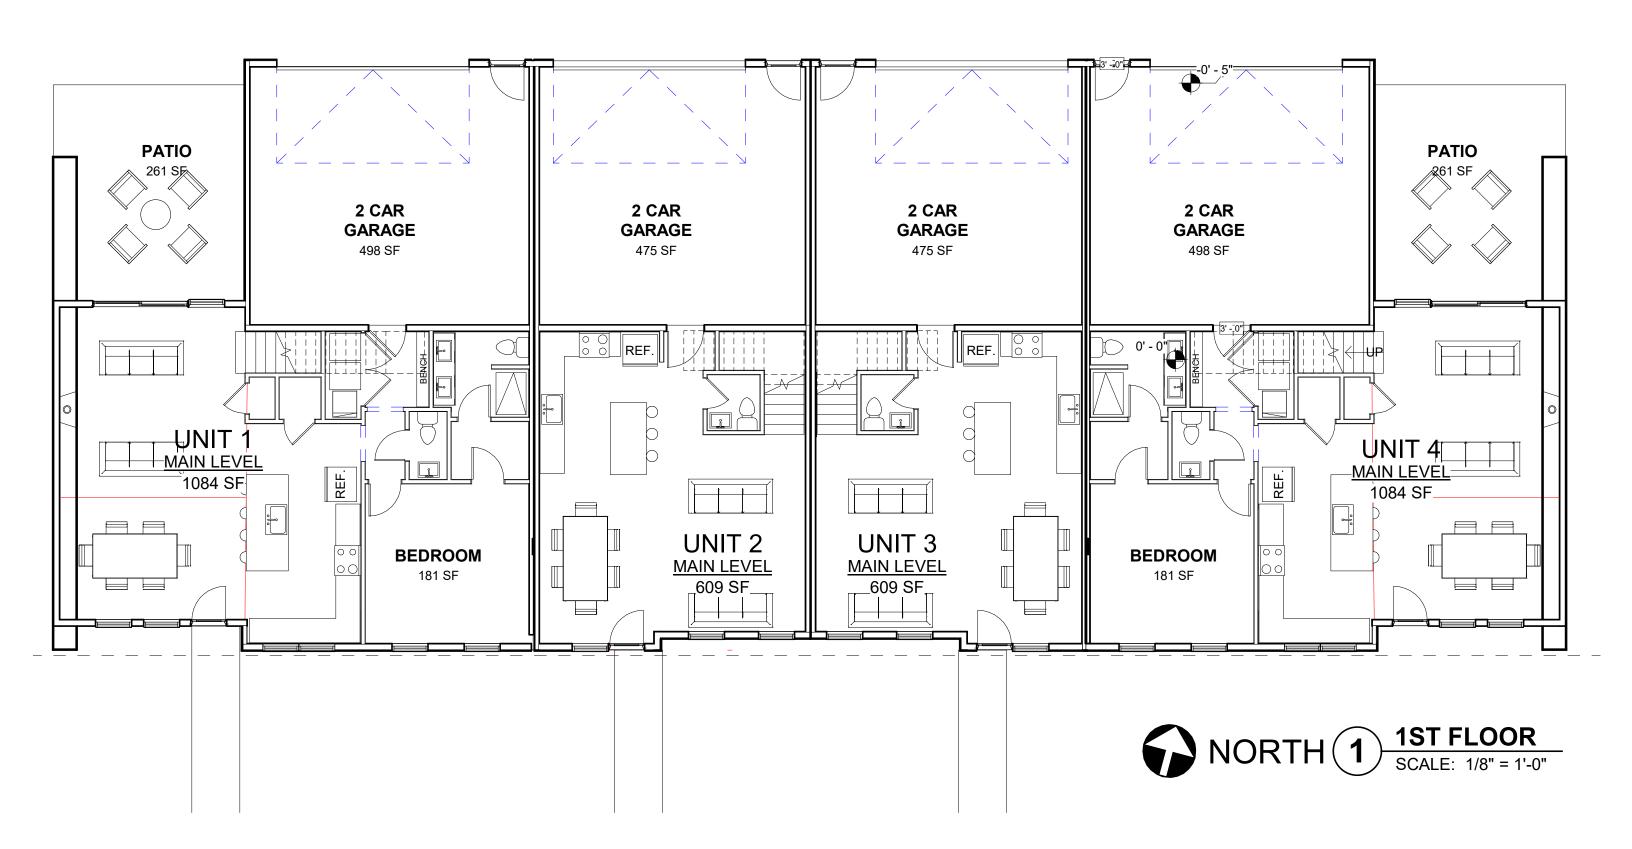

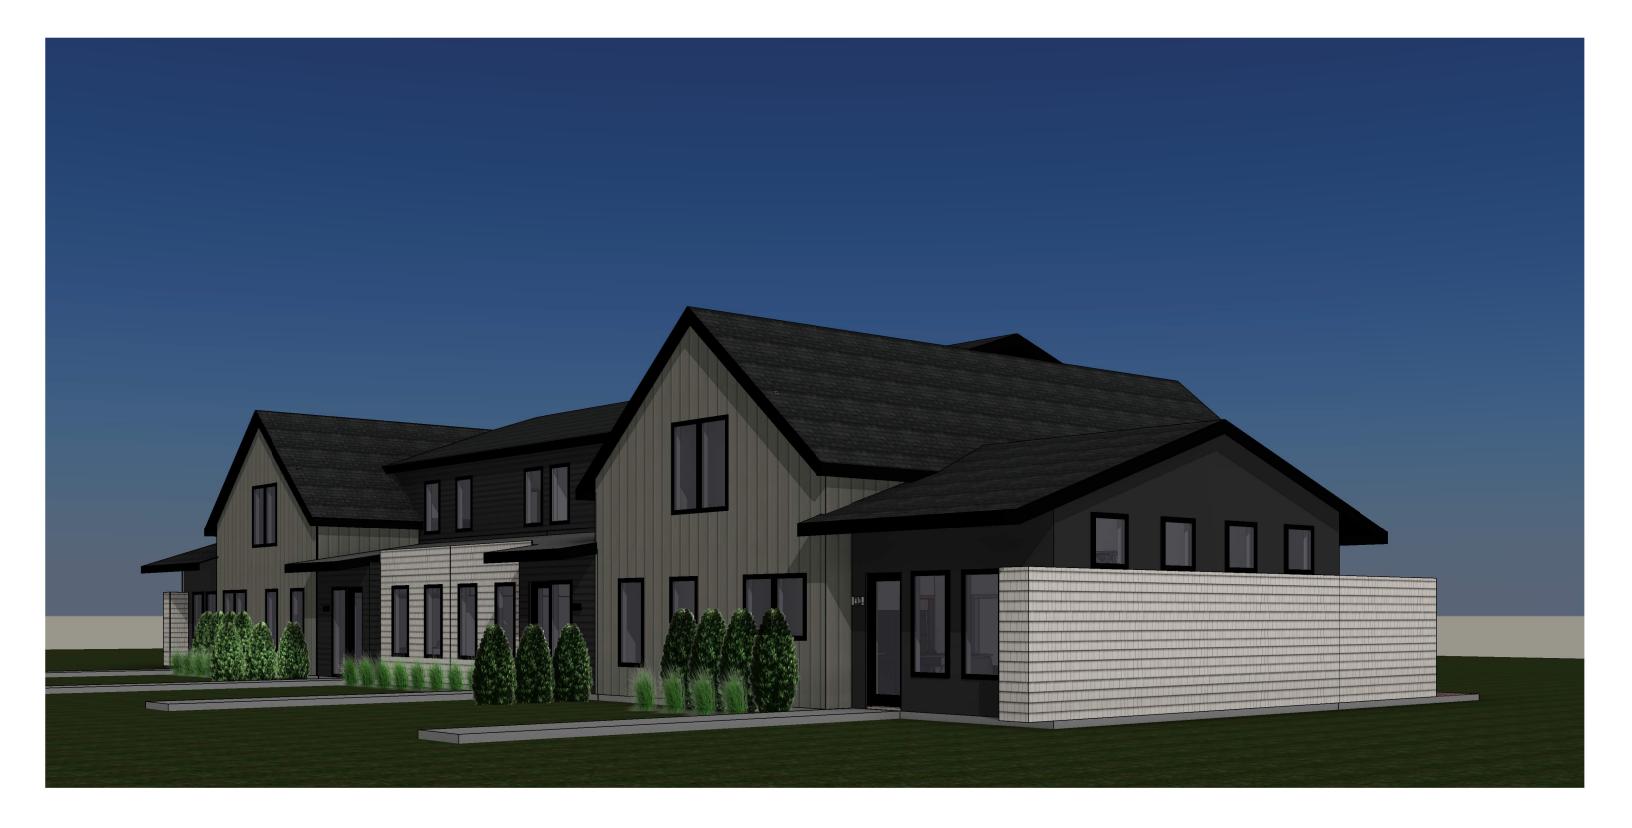












SOUTH ELEVATION

SCALE: 3/32" = 1'-0"

| MATERIAL SCHEDULE | |
|-------------------|--------------------------------------|
| Type Mark | Description |
| S1 | Fiber Cement Board and Batten Siding |
| S2 | Fiber Cement Lap Siding |
| S3 | Fiber Cement Shake Siding |

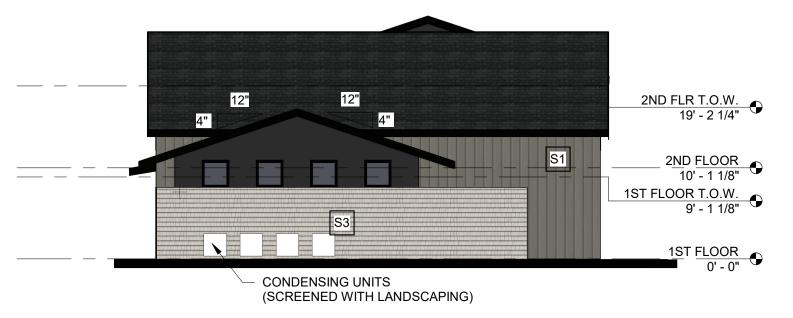

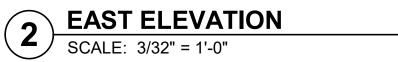


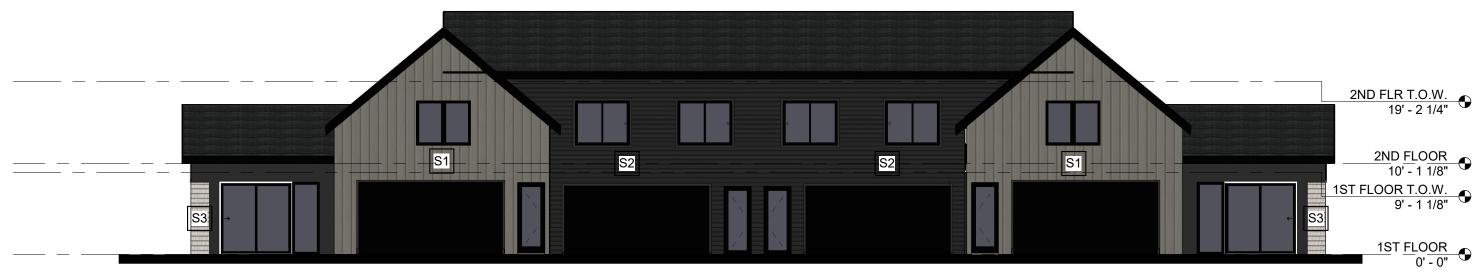

NORTH ELEVATION

SCALE: 3/32" = 1'-0"

| MATERIAL SCHEDULE | |
|-------------------|--------------------------------------|
| Type Mark | Description |
| S1 | Fiber Cement Board and Batten Siding |
| S2 | Fiber Cement Lap Siding |
| S3 | Fiber Cement Shake Siding |

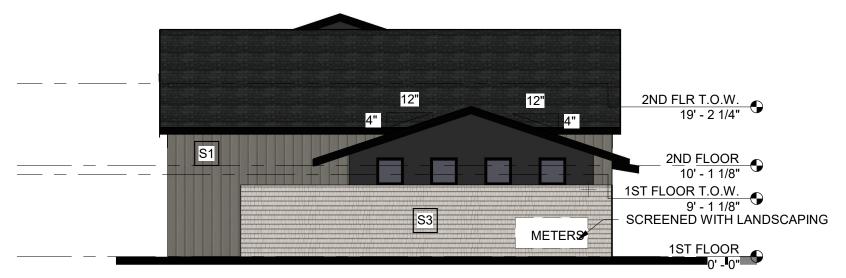

WEST ELEVATIONSCALE: 3/32" = 1'-0"

MEMORANDUM



Cara Geheren, P.E. 651.300.4261
Jack Griffin, P.E. 651.300.4264
Ryan Stempski, P.E. 651.300.4267
Chad Isakson, P.E. 651.300.4285

Date: November 15, 2022

To: Ben Hetzel, City Planner
Cc: Molly Just, Planning Director

Marty Powers, Public Works Director Chad Isakson, PE, Assistant City Engineer

From: Jack Griffin, PE, City Engineer

Re: Upper 33rd Street North Townhouse CUP

Site Plan review

PID 1302921320052 & 1302921320051

Engineering has reviewed the Upper 33rd Street North Townhouse CUP Site Plans received on November 4, 2022. The review consisted of the following documentation:

- Civil Site Plans dated November 3, 2022.
- Stormwater Calculations dated November 3, 2022.
- Lot Combination Survey dated November 2, 2022.
- 1. City approvals must be contingent upon the applicant revising the Final Construction Plans and Stormwater Management Plan as required by the City Engineer. Final Construction Plans and Specifications must be prepared in accordance with the latest version of the City Engineering Design Standards Manual, dated January 2022, using City details, plan notes and specifications and meeting City Engineering Design Guidelines and plan format requirements.
- 2. No construction on the Project may begin until the applicant has received City Engineer approval for the Final Construction Plans; the applicant has obtained and submitted to the City all applicable permits, easements and permissions needed for the project; and a preconstruction meeting has been held by the City's engineering department. All off-site permanent or temporary construction easements required to construct the project must be provided prior to scheduling a preconstruction meeting.
- 3. Site Access. The proposed townhome, including all four units, would access Upper 33rd Street North. Upper 33rd Street North is a local residential street, 24 feet wide within a 47 ft wide right-of-way. The street width and right-of-way do not meet minimum city standards (minimum 28 ft wide within 60 ft right-of-way). The street was recently reconstructed but maintained its existing width and right-of-way due to site constraints.
- 4. On-street Parking. At 24-feet-wide, no on-street parking is available along Upper 33rd Street North. The street is designated as no parking along both sides. All parking requirements must be met with all parking contained on the property.
- Pedestrian Connectivity. No sidewalk or trail currently exists along Upper 33rd Street. Due to the narrow street width (24 feet) pedestrian use of the paved roadway may be hazardous once Upper 33rd Street connects to the future development of Schiltgen Farms.
- 6. Drainage and Utility Easements. A 10-ft. drainage and utility easement should be provided along the property frontage to allow for future placement and relocation of small/dry utilities. Minimum lot easements should also be provided along the side and rear property lines. All easement areas must be free from all encroachments other than those approved by the City Engineer and upon execution of an easement encroachment agreement. Prohibited encroachments include, but are not limited to trees, landscaping, fences, retaining walls, and building structures.

- 7. The Site plan shows retaining walls along part of the west property line and most of the rear property line. The retaining walls should be a minimum of 5 ft from the property lines and outside of all lot easements, including retaining wall footings.
- 8. Existing conditions plan is incomplete. Existing conditions is required for a minimum distance of 150 feet from the proposed parcel and from any off-site improvements.
- 9. The proposed site plan is subject to a storm water management plan (SWMP) meeting State, Valley Branch Watershed District (VBWD) and city rules. The site plan as proposed does not meet stormwater management requirements. Post construction discharge rates and volumes must be equal or less than pre-existing discharge rates at all discharge locations and cumulative for the site.
- 10. The proposed stormwater management plan proposes an underground storm water infiltration chamber to mitigate 100% of the required rate and volume control. The infiltration chamber outfall pipe is proposed to connect directly to the existing storm sewer along Upper 33rd Street, thereby redirecting the existing site runoff from discharging to the north, and discharging the proposed condition runoff to the south. No storm sewer calculations have been provided to demonstrate available capacity in the city storm sewer system at this location.
- 11. No borings have been taken for to determine the feasibility of infiltration on site and to identify the design infiltration rate, if deemed feasible. Soil borings are required in accordance with the City Engineering Design Standards Manual dated January 2022.
- 12. The storm water management facilities constructed for this development should remain privately owned and maintained. The applicant will be required to execute and record a Stormwater Maintenance and Easement Agreement in the City's standard form of agreement. The stormwater drainage and utility easements must be shown on the site plans, utility plans and grading plans. A Homeowner's association would be required for the development to provide for the ongoing ownership and maintenance responsibilities.
- 13. Municipal water supply is available to the site. There are four (4) existing water service stubs available along the frontage of the property to provide an individual water service connection for each townhome. Connections to existing public watermain will be required, including all connection and permit fees.
- 14. Sanitary sewer service is available to the site. There are four (4) existing sanitary sewer service stubs available along the frontage of the property to provide an individual sewer service connection for each townhome. Connections to existing sewer will be required, including all connection and permit fees.

Lake Elmo Fire Department

Memorandum

To: Ben Hetzel, City Planner From: Dustin Kalis, Fire Chief

Date: 11/8/22

Re: Conditional Use Permit: Upper 33rd Street - 4 Unit Townhome



The Lake Elmo Fire Department has completed a Conditional Use Permit review for Upper 33rd Street - 4 Unit Townhome (PIDs 1302921320052 and 1302921320051) based on submittals dated 10/28/22 with the following comments:

- 1) The fire sprinkler system shall be installed compliant with provisions of 2016 NFPA Standard 13D, Installation of Sprinkler Systems in One- and Two-Family Dwellings or IRC P2904. City permit required prior to initiation of work.
- 2) Building address numbers shall be plainly visible from the street fronting the property and shall be a contrasting color from the background. Size and placement of address numbers shall be approved by the fire and planning departments.

Codes and Standards Used for this Review

This review is based on the following codes and standards as adopted and in effect in the State of Minnesota at the time of plan submittal.

- 2020 Minnesota State Fire Code
- 2020 Minnesota Residential Code
- Lake Elmo Fire Department Fire Code Policy
- NFPA 13D, 2016 edition

