Date Received:	
ReceivedBy:	
Permit#:	



651-747-3900 3880 LaverneAvenue North Lake Elmo, MN55042

CONDITIONAL USE PERMIT APPLICATION Property Owner: Davis Estates LTD Address: 6901 Jersey Ridge Rd Davenport IA 52807 Phone # (515) 288 - 2500 Email Address: ahubler@ Fee Owner: Same as Above Address:\_ Phone #\_ Email Address: Property Address: 8565 EAGLE POINT CIR, CITY OF LAKE ELMO PID#: 3302921430008 Engineer Name and Email: Convert Regnusces In signing this application, I hereby acknowledge that I have read and fully understand the applicable provisions of the Zoning

ordinance and current administrative procedures. I further acknowledge the fee explanation as outlined in the application procedures and hereby agree to pay all statements received from the City pertaining to additional application expense.

Signature of applicant:

Date: 2/12/2025

Signature of property owner:



Lake Elmo City Hall 651-747-3900 3800 Laverne Avenue North Lake Elmo, MN 55042

#### AFFIRMATION OF SUFFICIENT INTEREST

I hereby affirm that I am the fee title owner of the below described property or that I have written authorization from the owner to pursue the described action.

Name of applicant MEP Lino Lakes LLC	C Applicant
(Please Print	t)
Street address/legal description of subject property_8	565 Eagle Pt Circle Lake Elmo
· ·	
J5W-	2/20/2025
Signature	Date

**If you are not the fee owner**, attach another copy of this form which has been completed by the fee owner or a copy of your authorization to pursue this action.

If a corporation is fee title holder, attach a copy of the resolution of the Board of Directors authorizing this action.

**If a joint venture or partnership is the fee owner**, attach a copy of agreement authorizing this action on behalf of the joint venture or partnership.



Lake Elmo City Hall 651-747-3900 3800 Laverne Avenue North Lake Elmo, MN 55042

### ACKNOWLEDGEMENT OF RESPONSIBILITY

This is to certify that I am making application for the described action by the City and that I am responsible for complying with all City requirements with regard to this request. This application should be processed in my name and I am the party whom the City should contact regarding any matter pertaining to this application.

I have read and understand the instructions supplied for processing this application. The documents and/or information I have submitted are true and correct to the best of my knowledge. I will keep myself informed of the deadlines for submission of material and of the progress of this application.

I understand that this application may be reviewed by City staff and consultants. I further understand that additional information, including, but not limited to, traffic analysis and expert testimony may be required for review of this application. I agree to pay to the City upon demand, expenses, determined by the City, that the City incurs in reviewing this application and shall provide an escrow deposit to the City in an amount to be determined by the City. Said expenses shall include, but are not limited to, staff time, engineering, legal expenses and other consultant expenses.

I agree to allow access by City personnel to the property for purposes of review of my application.

Signature of applicantDateDateDate
Name of applicant Jeven Sparke Phone 612-501-1493
(Please Print) And MER Lino Lows
Name and address of Contact (if other than applicant)



Lake Elmo City Hall 651-747-3900 3800 Laverne Avenue North Lake Elmo, MN 55042

### AFFIRMATION OF SUFFICIENT INTEREST

I hereby affirm that I am the fee title owner of the below described property or that I have written authorization from the owner to pursue the described action.

Name of applicant Angelor & Habber Prosident Davis

(Please Print) Estates Utd.

Street address/legal description of subject property

8565 Eagle Pt Carcle

City Thabler Elmo

Angelor & Habber Data


Data

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If a joint venture or partnership is the fee owner, attach a copy of agreement authorizing this action on behalf of the joint venture or partnership.

Parcel Search: February 19, 2025 at 9:28 a.m. by SURVPUB 350 feet surrounding 3302921430008. 10 parcels, 8 labels.



### Signature Page to Real Estate Purchase and Sale Agreement

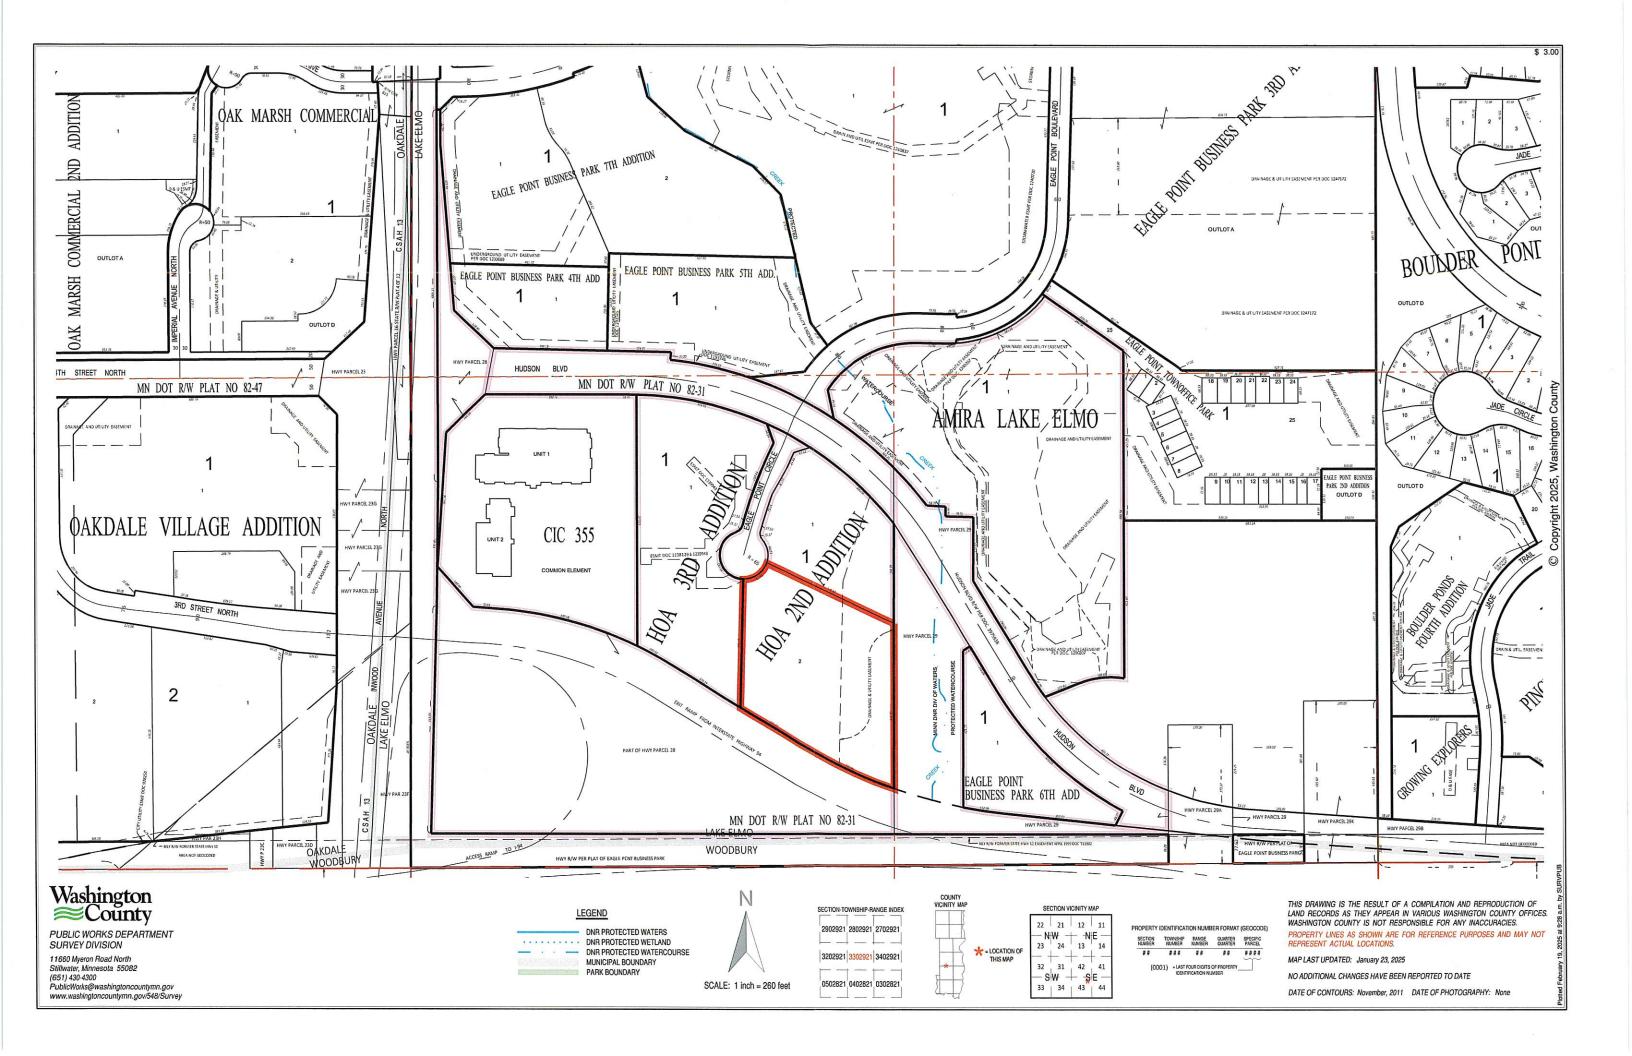IN WITNESS WHEREOF, the parties hereto have caused this Agreement to have been executed and delivered as of the date indicated by each signature below.

#### Purchaser:

MEP LINO LAKES LLC, a Minnesota limited

liability company

By: Name: Jerethy Spaude

Title: Managing Director

Date: February 19 , 2025

#### Purchaser:

DAVIS ESTATES LTD., an Iowa corporation

By: angela E. Hubler
Name: Angela E. Hutoler
Title: President

#### **Milestones Written Statements**

2.A. Applicant - Jeremy Spaude (612) 501-1493, Jeremy\_nslc@yahoo.com

6004 Pelican Way College Grove TN 37046

Owner - Davis Estates LTD <u>ahubler@ksu.edu</u>

6901 Jersey Ridge Rd. Davenport, IA 52807

Architect Michael Thomas (651) 245-2346 <u>mjtallc2520@gmail.com</u>

4918 S Tri Oak Circle NE East Bethel MN 55092

2B. **Address**: 8565 EAGLE POINT CIR, CITY OF LAKE ELMO

Acres: 4.1

Square Footage: 178,904

Parcel ID: 3302921430008

Class Code 1: 300 Commercial

Plat Name: HOA 2ND ADD

Block: 1

**Lot:** 2

2C. - The current building is vacant but was previously used by Rasmussen as a satellite location for their college. We have discussed the project with city staff previous to application and childcare fits as a conditional use on the site.

2D:

i. The site/building is a great use for early childhood. The current site has an abundance of parking and with our design we will replace sections of paving with playground as shown in the plans. There will be no change to the flow of traffic on the site as the bulk of the parking will remain in place with plenty of room to do turnarounds. In removing some of the parking, we will create some additional green areas and reduce the overall impervious surface on the site. We will be removing 3 trees and 4 shrubs as part of the playground

layouts but plan to replant 3 trees in place of the 3 removed on the south side of the property.

We will have no impact on the surrounding wetlands or buildings as we are not adding any additional buildings to the site. If anything, we will be removing some of the runoff to the wetlands which will be an improvement over the current set up.

ii. The daycare will operate from 7am-6pm similar to our other location in Lake Elmo. We will have north of 30 staff at one time on site teaching upwards of 220 kids. We do not create a lot of disruption as our prime drop off time is from 7-9am and pick up 4-6 with limited traffic at any given time as traffic is consistent but not significant at any given time.

#### 2E.

- i. Our programs are a benefit to the community and in this location is a perfect use as we are a destination as well as this site is set back from roadways and off the normal track of traffic.
- ii. This site is in a School district with this use as a conditional use in the district. We are supporting the growth of Lake Elmo and surrounding communities by bringing in a key need in the market for more affordable care that is higher in quality.
- iii. The use is a compliment to the area with office and other uses around it as people can drop off near work. This location is also near main roadways that families travel to get to work.



Existing East Exterior Elevation

SCALE: 1/8" = 1'-0"



- DEMO AND PATCH EXISTING BRICK AS REQ'D FOR NEW DOOR


Existing West Exterior Elevation

SCALE: 1/8" = 1'-0"



Existing North Exterior Elevation

SCALE: 1/8" = 1'-0"

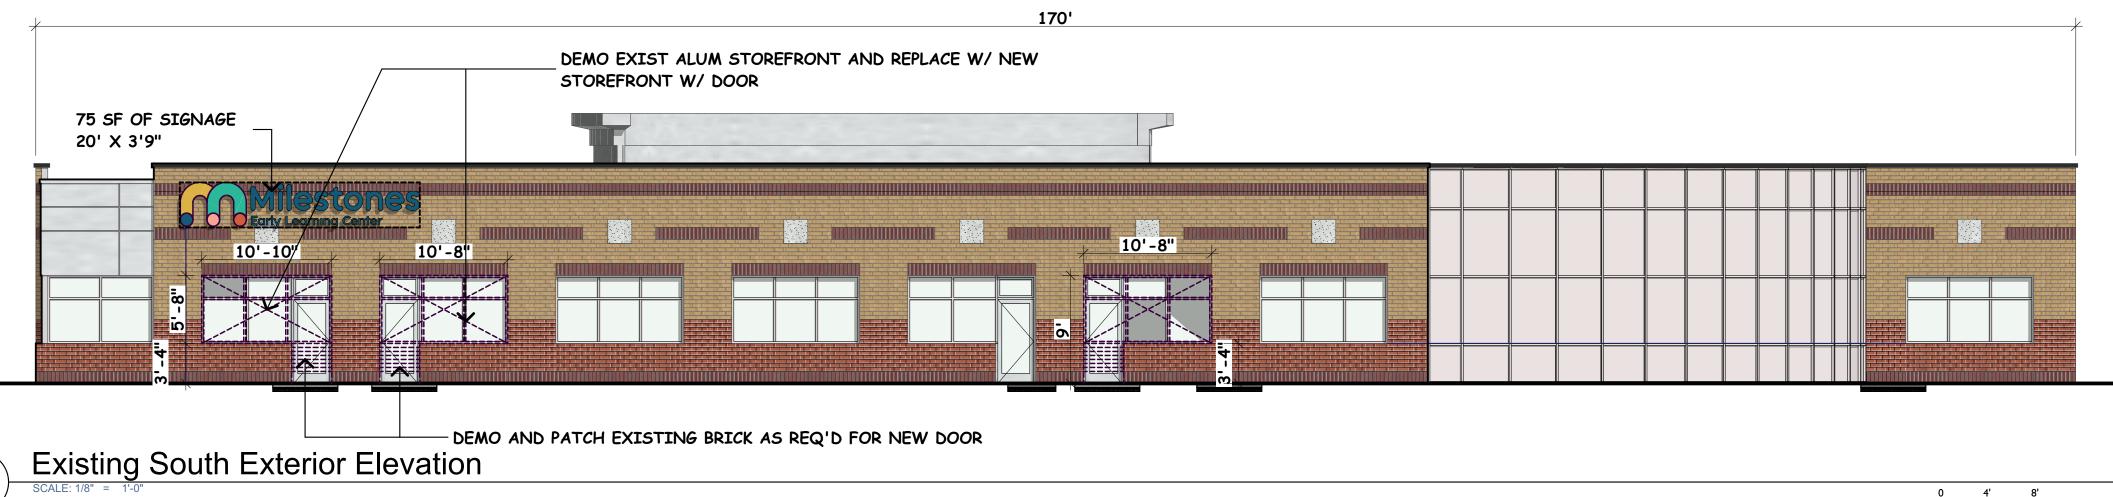

	SHEET INDEX	Date Issued
Cover Si	neet	
A0.0	Cover Sheet	04-02-25
A0.1	Exist Site Survey	04-02-25
A0.2	Existing Site Plan	04-02-25
A0.3	Proposed Site Plan	04-02-25
A0.4	Lanscape & Turf Plan	04-02-25
Architec	tural General	
A0.5	Code Information	04-02-25
A0.6	Room Finish Schedule	Not Issued
A0.7	Door Schedule & Types	Not Issued
A0.8	Outline Specifications	Not Issued
Architec	tural Plans	
A1.0	First Story Demolition Plan	04-02-25
A1.1	First Story New Floor Plan	04-02-25
A1.2	Frist Story Demo & New	Not Issued
A1.3	Enlarged Floor Plan - North Wing	Not Issued
A1.4	Enlarged Plans - Reception Area	Not Issued
A1.5	Enlarged Floor Plan - Sport Court Area	Not Issued
A1.6	Enlarged Floor Plan - West Wing (South)	Not Issued
A1.7	Enlarged Floor Plan - West Wing (North)	Not Issued
Architec	tural Reflected Ceiling Plans	
A7.0	Existing Ceiling Plan	Not Issued
A7.1	Reflected Ceiling Plan - First Story - New	Not Issued
Interior	Details	
A8.1	Interior Elevations	Not Issued
A8.2	Interior Elevations	Not Issued
A8.3	Interior Elevations	Not Issued
A8.4	Interior Elevations	Not Issued
A8.5	First Story FFE & Floor Finish Plan	Not Issued
Mechani	cal, Electrical, & Plumbing (MEF	<b>'</b> )
E1.0	First Story Elec Power & Low Voltage Plan	Not Issued

## **GENERAL NOTES**

I. This is an invited, general contractor, open-book, lump sum contract/

2. This is a Design/Build Mechanical Electrical & Plumbing (ME) project. The applicable subcontractor will include the design, materials, and labor for their work per the outline specifications and plans herein. The GC's bid must include will be clear narrative for the Design/Build MEP scopes of work.

### **DEFERRED MEP SUBMITTALS LIST:**


- a. Plumbing Fixture List/ Cut Sheets
- b. Plumbing Isometric Plan(s)
- c. Electrical Light Fixture Cut Sheets d. HVAC Plans, Specifications, Equipment Cut Sheets
- e. Fire Supression/ Spinkler System Shop Drawings

# **PROJECT TEAM**

ARCHITECT Michael J. Thomas Architect, LLC 4918 S. Tri Oak Circle NE East Bethel, MN 55092 651-245-2346 mjtallc2520@gmail.com www.michaeljthomasarchitect.com

Milestones Early Learning Cenger Jennifer Schultz: 612-501-8255 Jeremy Spaude: 612-501-1493

**GENERAL CONTRACTOR GDS** Design Build Gail Schuette 612-616-2616

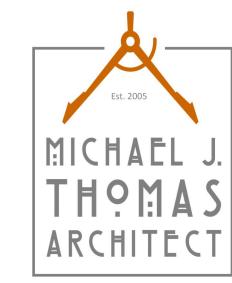

4918 S. Tri Oak Circle NE East Bethel, MN 55092 Phone: 651-245-2346 Email: mjtallc2520@gmail.com Web:michaeljthomasarchitect.com



Project No:

**Date Last Revised:** 02-11-25, 02-18-25, 02-19-25, 02-20-25, 02-24-25, 02-26-25, 02-27-25, 03-25-25, 03-29-25, 04-02-25

File Name: 25004 Milestones Woodbury\_Lake Elmo 04-02-25 A0.0.pln **Drawn By:** 

Minnesota License No.: 23592

**Date Signed:** 02-27-25

MJT

I hereby certify that this plan, specification, or report was prepared by me or under my direct supervision and that I am a duly Licensed Architect under the laws of the State of

<u>Signature</u>



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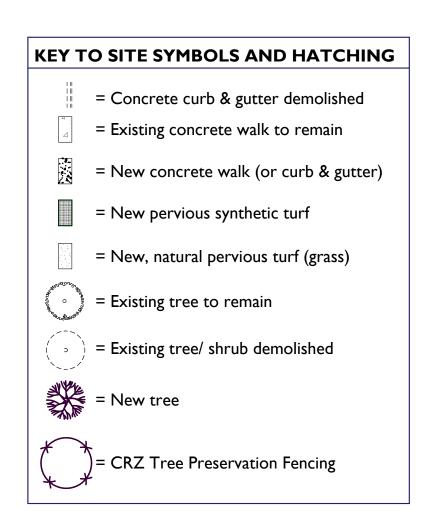


agreement to the contrary, is limited to a onetime use on the site indicated on these plans.

**COVER SHEET** 

Building **filestones Early Learning Cente** daptive Reuse - Rebalitation f the Existing Rasmussen University


**A0.0** 






# Milestones\_Branding Guide



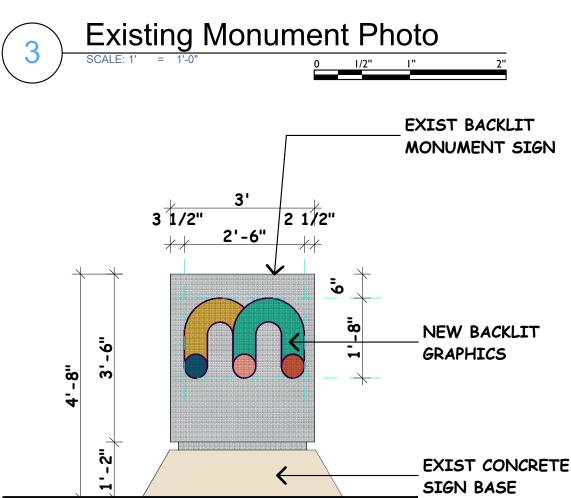

Existing Monument Sign

SCALE: 1/2" = 1'-0"

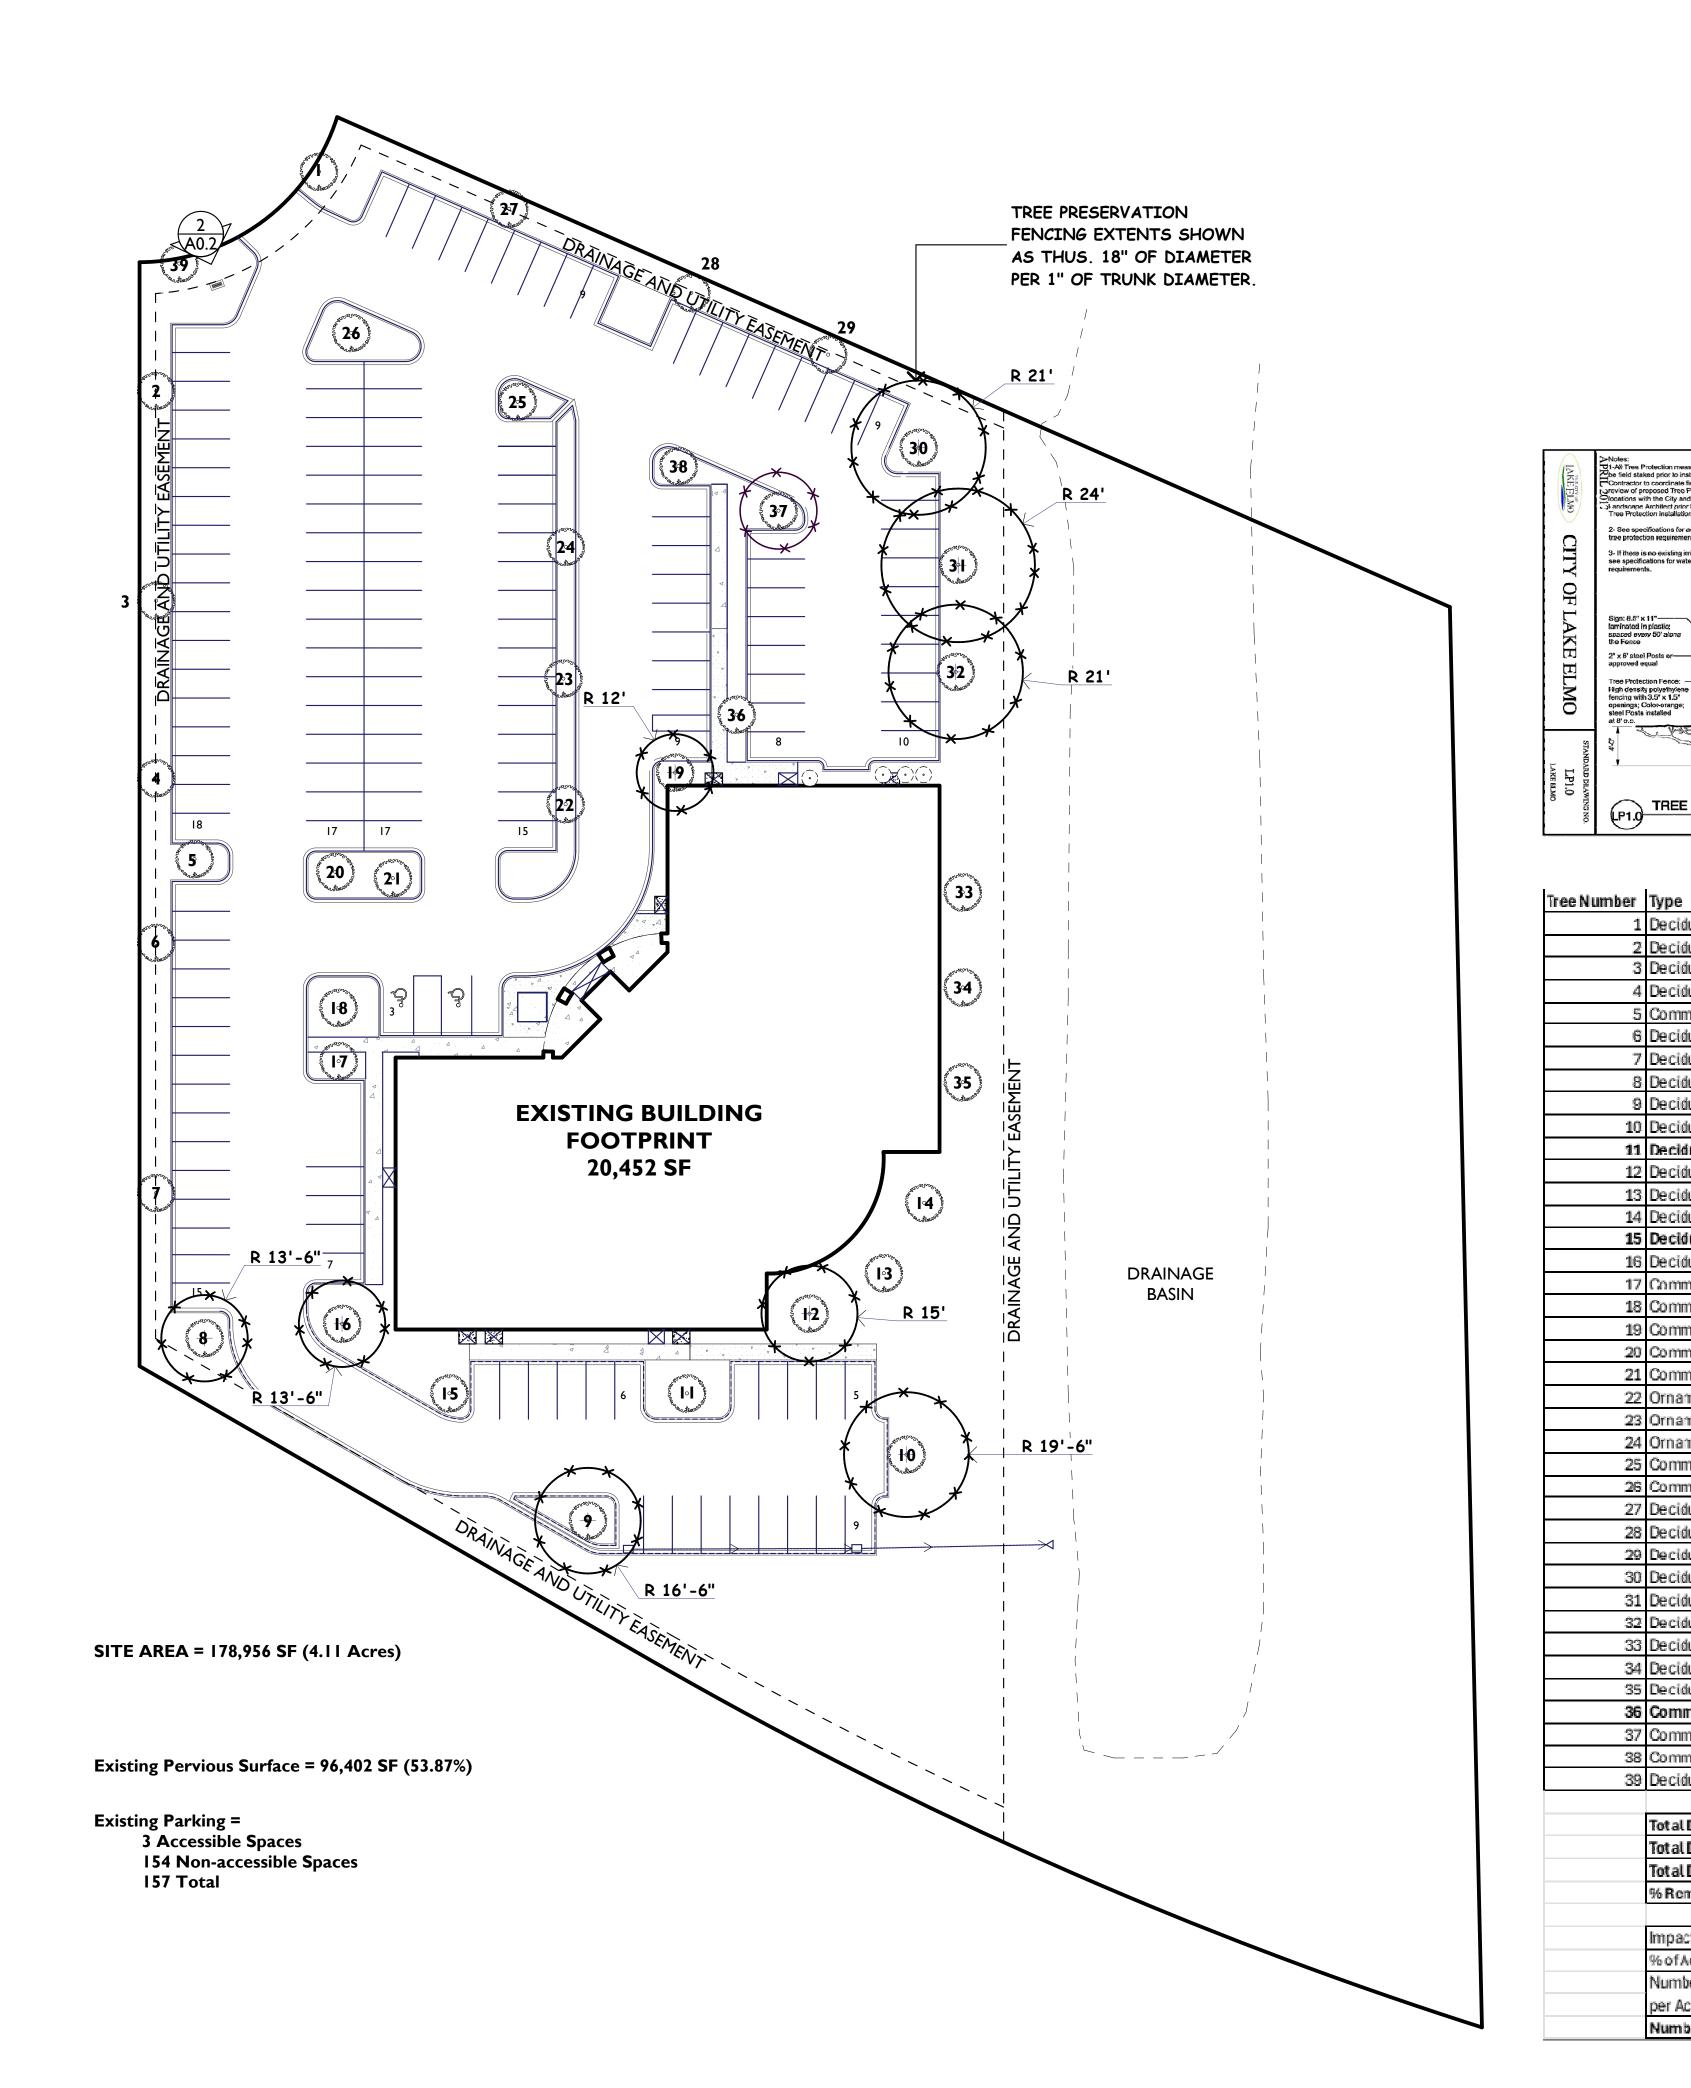



9- If there is no existing imgalion see specifications for watering requirements.

ligh density polyethylene encing with 3.5" x 1.5" openings; Color-orange; sleel Posts installed

TREE PROTECTION

Deciduous

2 De ciduo us

3 Deciduous

4 Deciduous

6 Deciduous

7 Deciduous

8 Deciduous

9 Deciduous

10 Deciduous

12 Deciduous

13 Deciduous

14 Deciduous

15 Deciduous

16 Deciduous

17 Common

18 Common

19 Common

20 Common

21 Common

22 Ornamental

23 Ornamental

24 Ornamental

25 Common

26 Common

27 Deciduous

28 Deciduous

29 Deciduous

30 Deciduous

31 Deciduous

32 Deciduous

33 Deciduous

34 Deciduous

35 Deciduous

36 Common

37 Common

38 Common

39 Deciduous

Total DBH

% Removed

Impacted Area

%ofAcre

per Acre

Total DBH Significant Trees

Number of Trees Required at 5

Number of Trees Proposed

Total DBH Removed

11 Deciduous

Silver Maple

ocust, Honey

ilver Maple

ilver Maple

ilver Maple

Bur Oak

Bur Oak

ocust, Honey

ocust, Honey

ocust, Honey

ocust, Honey

.oc ust, Honey

Locust, Honey

ocust, Honey

Silver Maple

Silver Maple

ilver Maple

ilver Maple

ilver Maple

Silver Maple

Silver Maple

ilver Maple

Silver Maple

.oc ust, Honey

odust, Honey

Locust, Honey

Silver Maple

Notes (cont.): 4- No pruning shall be performe except by approved certified arborist.

6- See Site Preparation Plan for any modifications with the Tree Protection Area.

7- No Wood Chips supplied from diseased trees (clim, ash etc.) or invasive species such as bucktors.

Condition Keep/Remove

Keep

Kelep

Keep

Keep

Keep

Kelep

Keep

Keep

Kelep

Keep

Kelep

Keep

Kelep

Keep

Keep

Kelep

Keep

Keep

Kelep

Kelep

Keep

Keep

Keep

Kelep

Keep

Keep

Remove

Remove

Remove

14 Good

16 Good

17 Good

9 Good

10 Good

9 Good

11 Good

13 Good

13 Good

10 Good

9 Good

6 Good

15 Good

9 Good

8 Good

7 Good

8 Good

9 Good

7 Good

8 Good

8 Good

9 Good

7 Good

9 Good

15 Good

16 Good

17 Good

14 Good

16 Good

14 Good

10 Good

12 Good

9 Good

9 Good

8 Good

7 Good

15 Good

434

401

9.23%

14,895 sq ft

0.3422564

14 Good

Wood Chips: 1: depth on Acces Road; 5" dopth inside Tree Protection Area



4918 S. Tri Oak Circle NE East Bethel, MN 55092 Phone: 651-245-2346 Email: mjtallc2520@gmail.com Web:michaeljthomasarchitect.com



Project No:

04-02-25

**Date Last Revised:** 02-11-25, 02-18-25, 02-19-25, 02-20-25, 02-24-25, 02-26-25, 02-27-25, 03-25-25, 03-29-25,

File Name: 25004 Milestones Woodbury\_Lake Elmo 04-02-25.pln Drawn By:

Minnesota License No.: 23592

**Date Signed:** 02-27-25

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<u>Signature</u>

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Milestones
Early Learning Center

agreement to the contrary, is limited to a onetime use on the site indicated on these plans.

**EXISTING SITE PLAN** 

**Early Learning** (se - Rebalitation gramms and secondary)

Existing



8565 Lake





4918 S. Tri Oak Circle NE East Bethel, MN 55092 Phone: 651-245-2346 Email: mjtallc2520@gmail.com Web:michaeljthomasarchitect.com



# Project No:

**Date Last Revised:** 02-11-25, 02-18-25, 02-19-25, 02-20-25, 02-24-25, 02-26-25, 02-27-25, 03-25-25, 03-29-25, 04-02-25

File Name: 25004 Milestones Woodbury\_Lake Elmo 04-02-25.pln Drawn By: MJT

Minnesota License No.: 23592

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<u>Signature</u>



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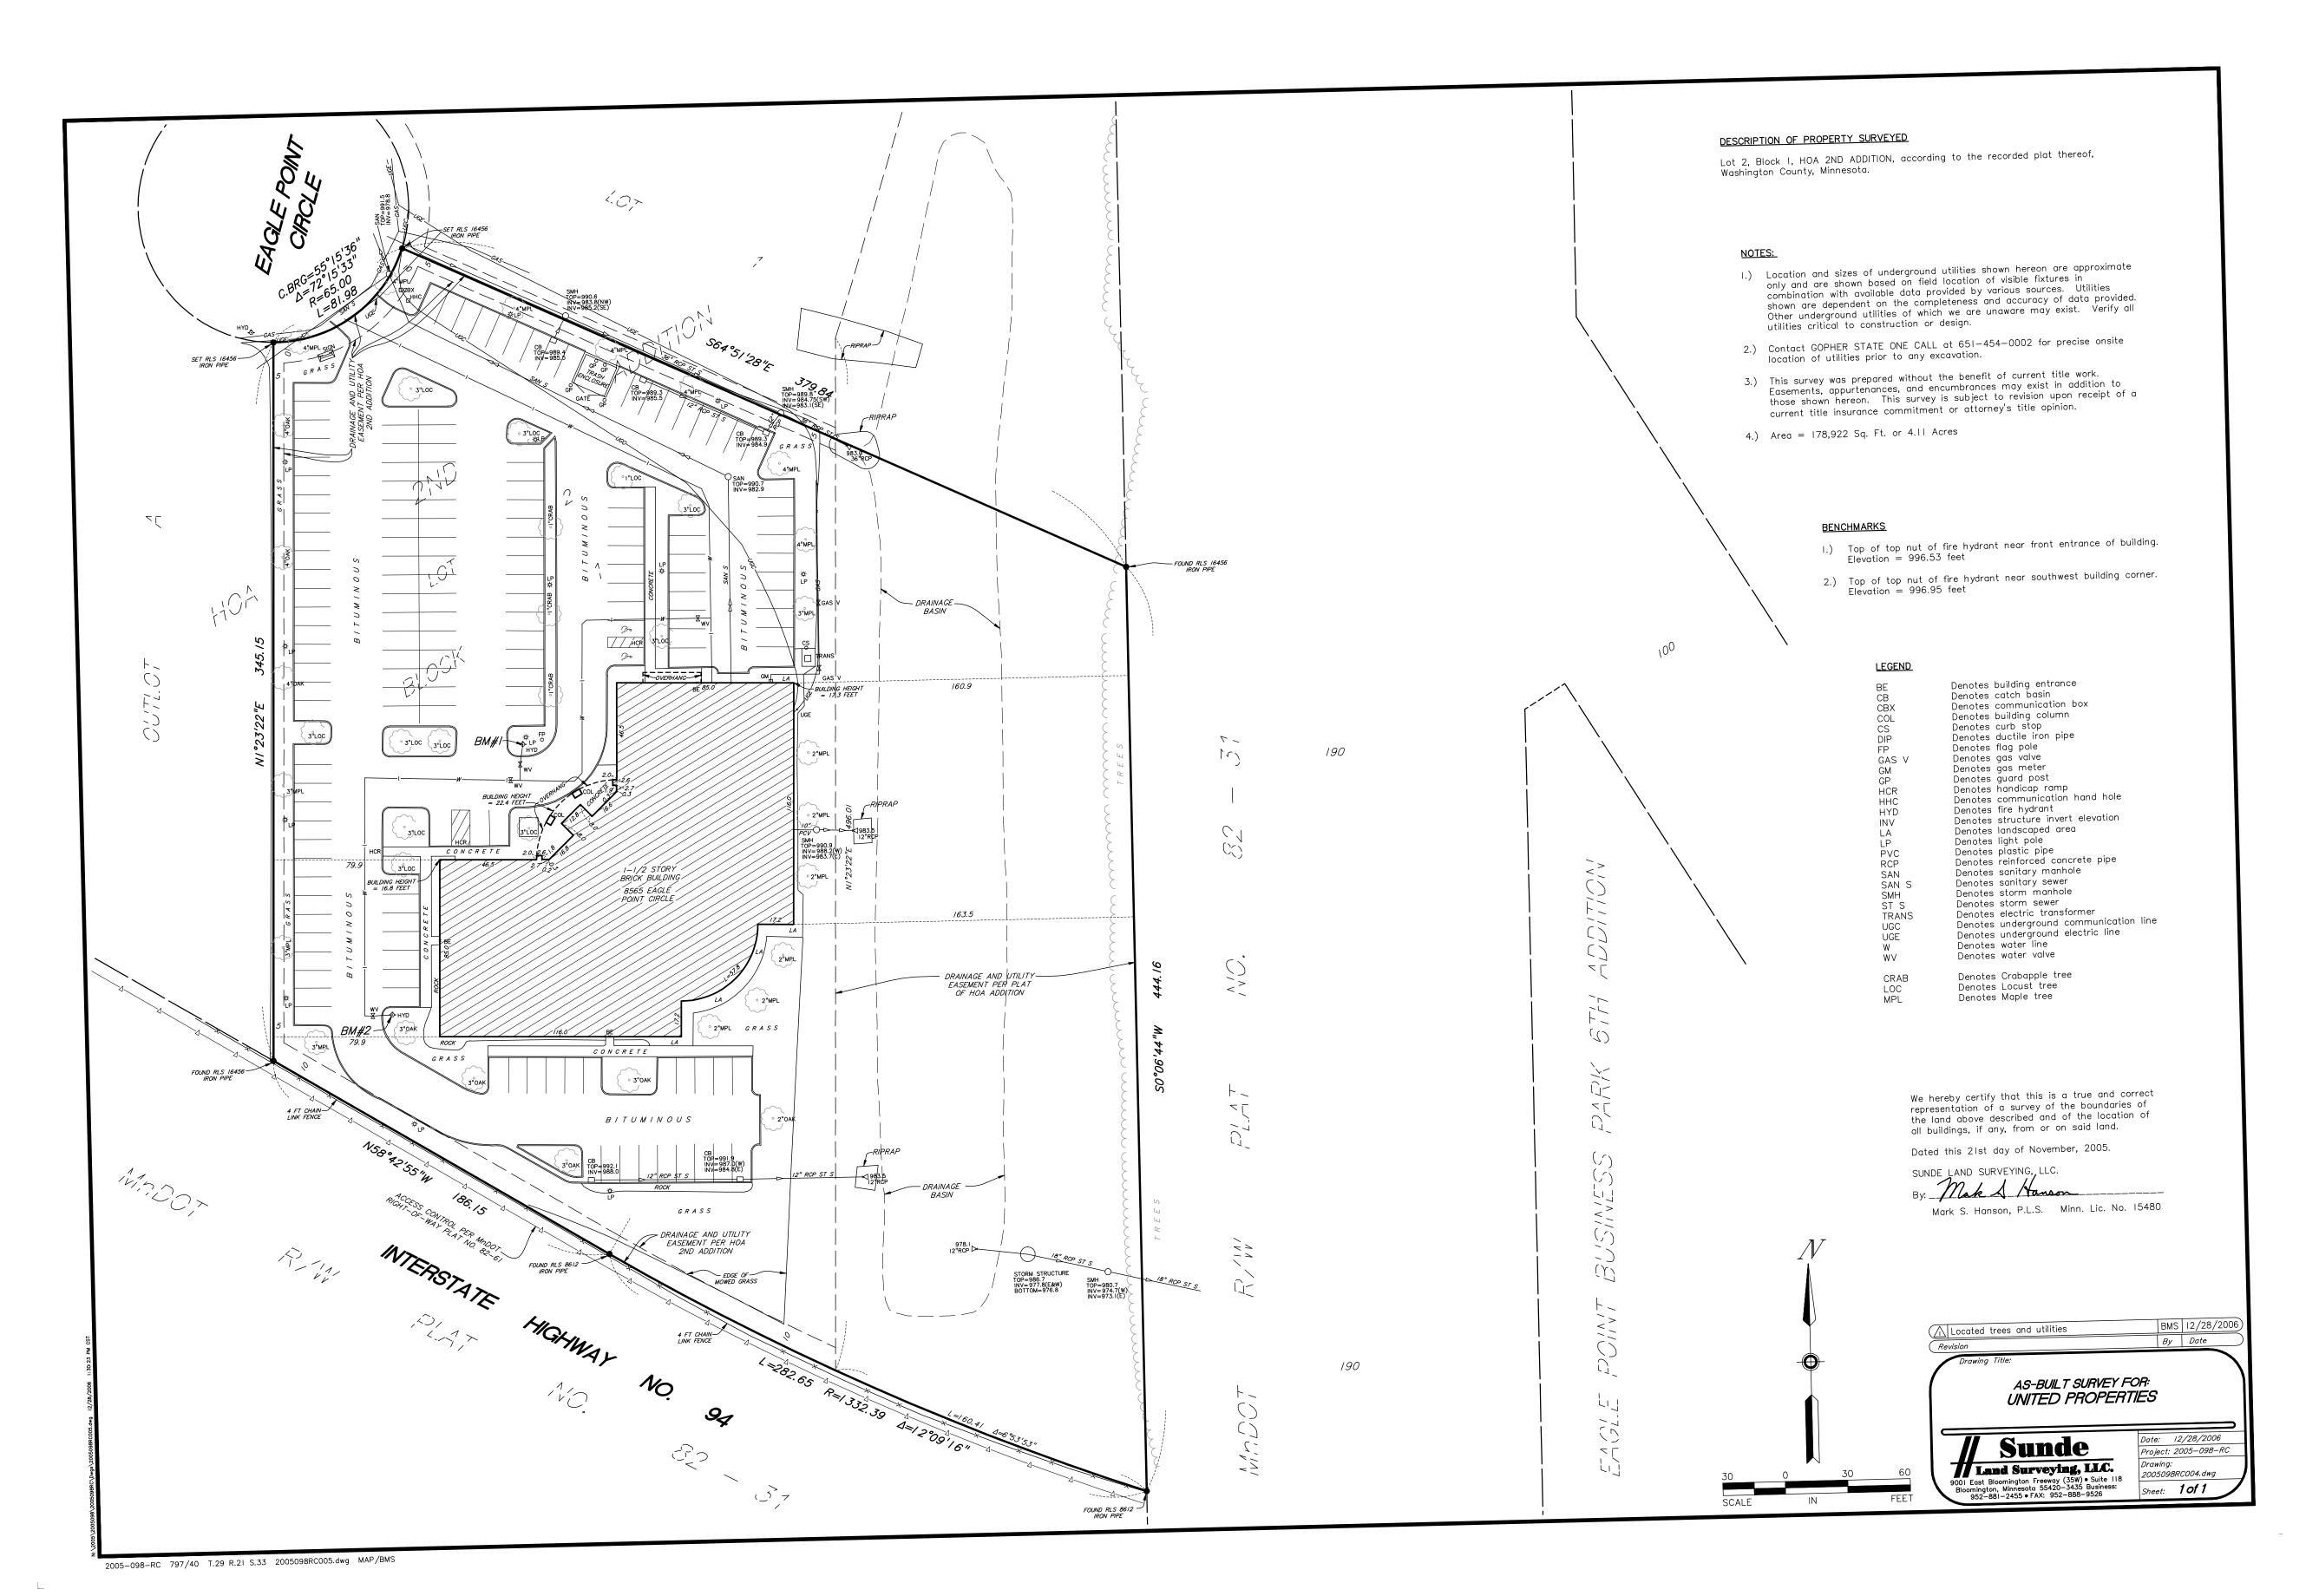



**EXISTING SITE SURVEY** 

**Early Learning (**se - Rebalitation
g Rasmussen Univ

8565 Lake

Existing



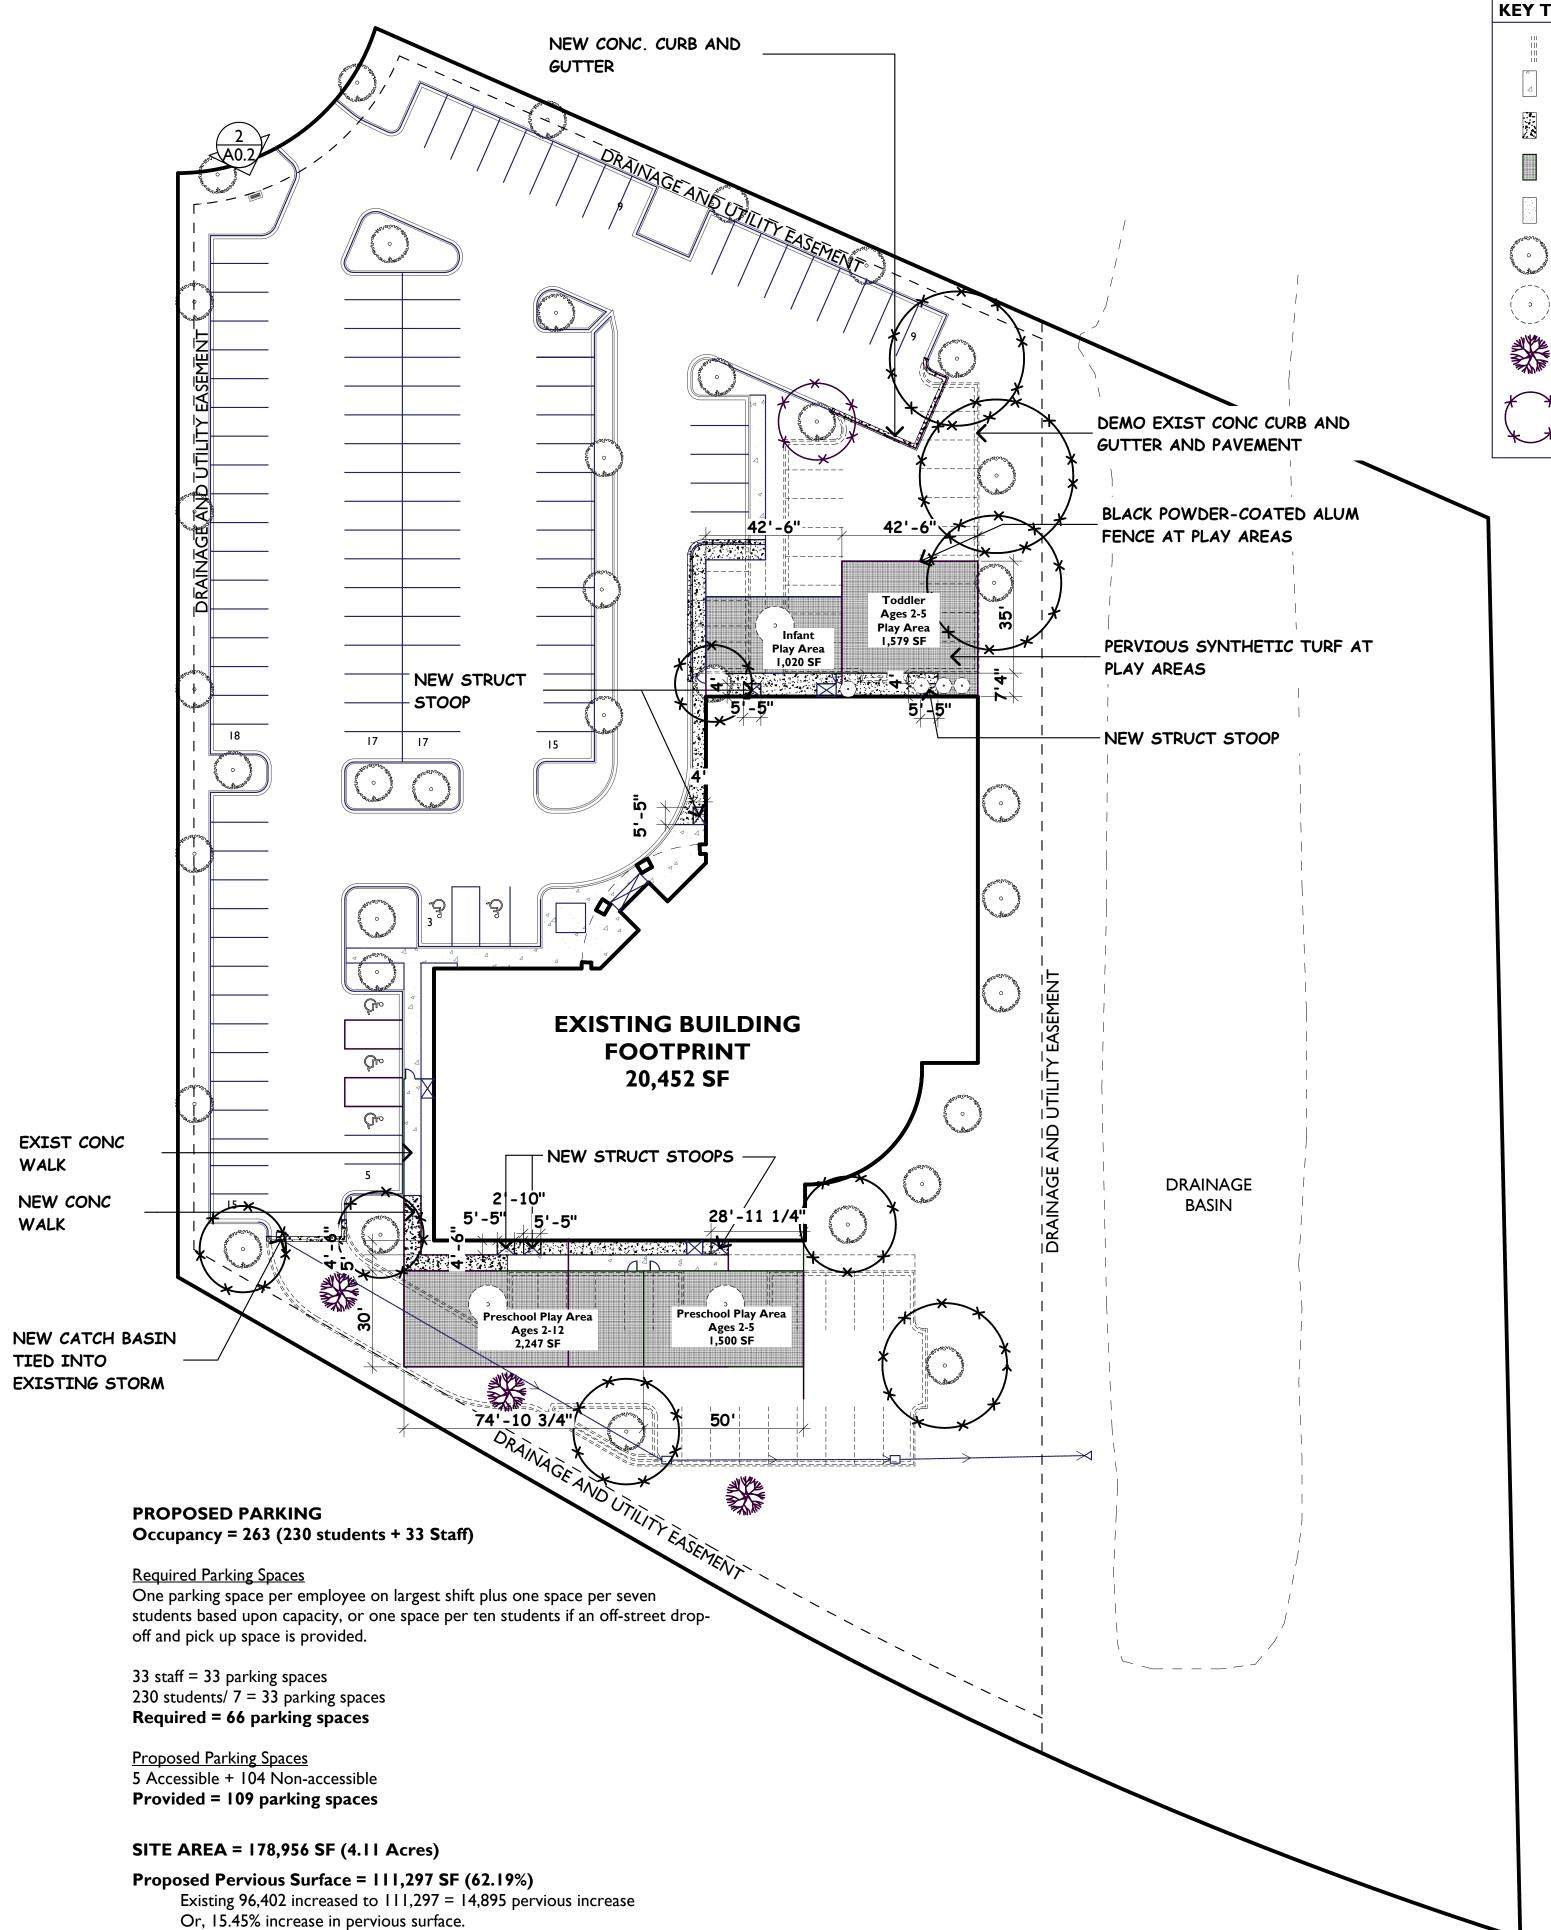

**KEY TO SITE SYMBOLS AND HATCHING** = Concrete curb & gutter demolished = Existing concrete walk to remain = New concrete walk (or curb & gutter) = New pervious synthetic turf = New, natural pervious turf (grass) = Existing tree to remain = Existing tree/ shrub demolished = New tree

= CRZ Tree Preservation Fencing

**NEW SITE PLAN NOTES:** 

I. ALL NEW TREES MUST RECIEVE IRRIGATION/ WATERING **THROUGH THE 2-YEAR** WARRANTY PERIOD

2. ALL NEW TREES SHALL BE PLANTED TEN FEET AWAY FROM **UTILITIES INCLUDING WATER** AND SEWER STUBS.

3. ALL NEW SITE WORK WILL MATCH EXISTING GRADES

4. TREE AVOIDANCE PRACTICE Contractor to keep equipment as far as planted."

possible from the trees when removing the pavement. Contractor should only scrape back the curb and pavement away from the tree and not dig near the trees. Markings should be made on the pavement area prior to demolition to show the critical root zone of the trees to help contractor understand the area of impact. Once the pavement and curb is removed, the contractor should dump and hand place the topsoil where grass is to be

> 6" MIN STRUC CONC -SLAB, SEE ARCH FOR -EXIST WALL BEYOND SLOPE #4 @ 12" O.C. -4" MIN SLAB BRG COORD W/ ARCH DWGS #5 @ 12" O.C. BOT -EXIST CONC SLAB EXT GRADE OR -ON GRADE PAVING, SEE ARCH & EXIST FFE CIVIL CONTR OPTION: TEMP FORM OR #4 @ 24" O.C. DWL, GALV CONFORM DRILL & EPOXY DK OR EQ INTO EXIST FDN DESIGNED BY WALL 2'-0" DO NOT FILL DK MFR THUS: VOID W/ CONC **EMBED** 12"Ø CONC FTG W/-(2) #4 @ DWLS (4) #5 VERT & #3 EXIST FDN @ EA SLAB TIES @ 12" O.C. WALL CORNER THUS: 2'-0" 2'-0" -EXIST CONC



POUR'D CONC. STOP AT

STOP ABUTS EXIST. OR

NEW CONC. WALK


LOCATIONS WHERE NEW

New Struct Stoop



Typical Play Area Fence



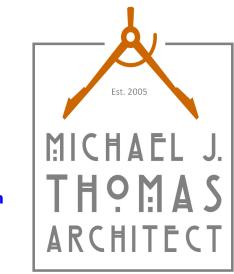

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Minnesota License No.: 23592

**Date Signed:** 02-27-25

Drawn By:

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**Signature** 



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PROPOSED SITE PLAN

**A0.3** 

Notes: 1- Refer to specification 329000 for additional

2- Amend Planting Soil with MnDOT 3881 B.4

3- Mulch ring for individually planted trees shall

4- Remove all nursery twine at trunk at time of

5- No staking allowed unless requested and

Trunk caliper shall meet ANSI Z60.1

Round-topped soil berm 4" high x 8" wide ----

above root ball surface shall be constructed around the root ball; Berm shall begin at root

**DECIDUOUS TREE** 

3x widest dimension of root ball.

SECTION VIEW

latest edition for root ball size

ball periphery


Bottom of root ball rests


on existing or re-compacted soil

3896C or 3896G Additives

granted in writing by City.

be a minimum diameter of 4-feet.

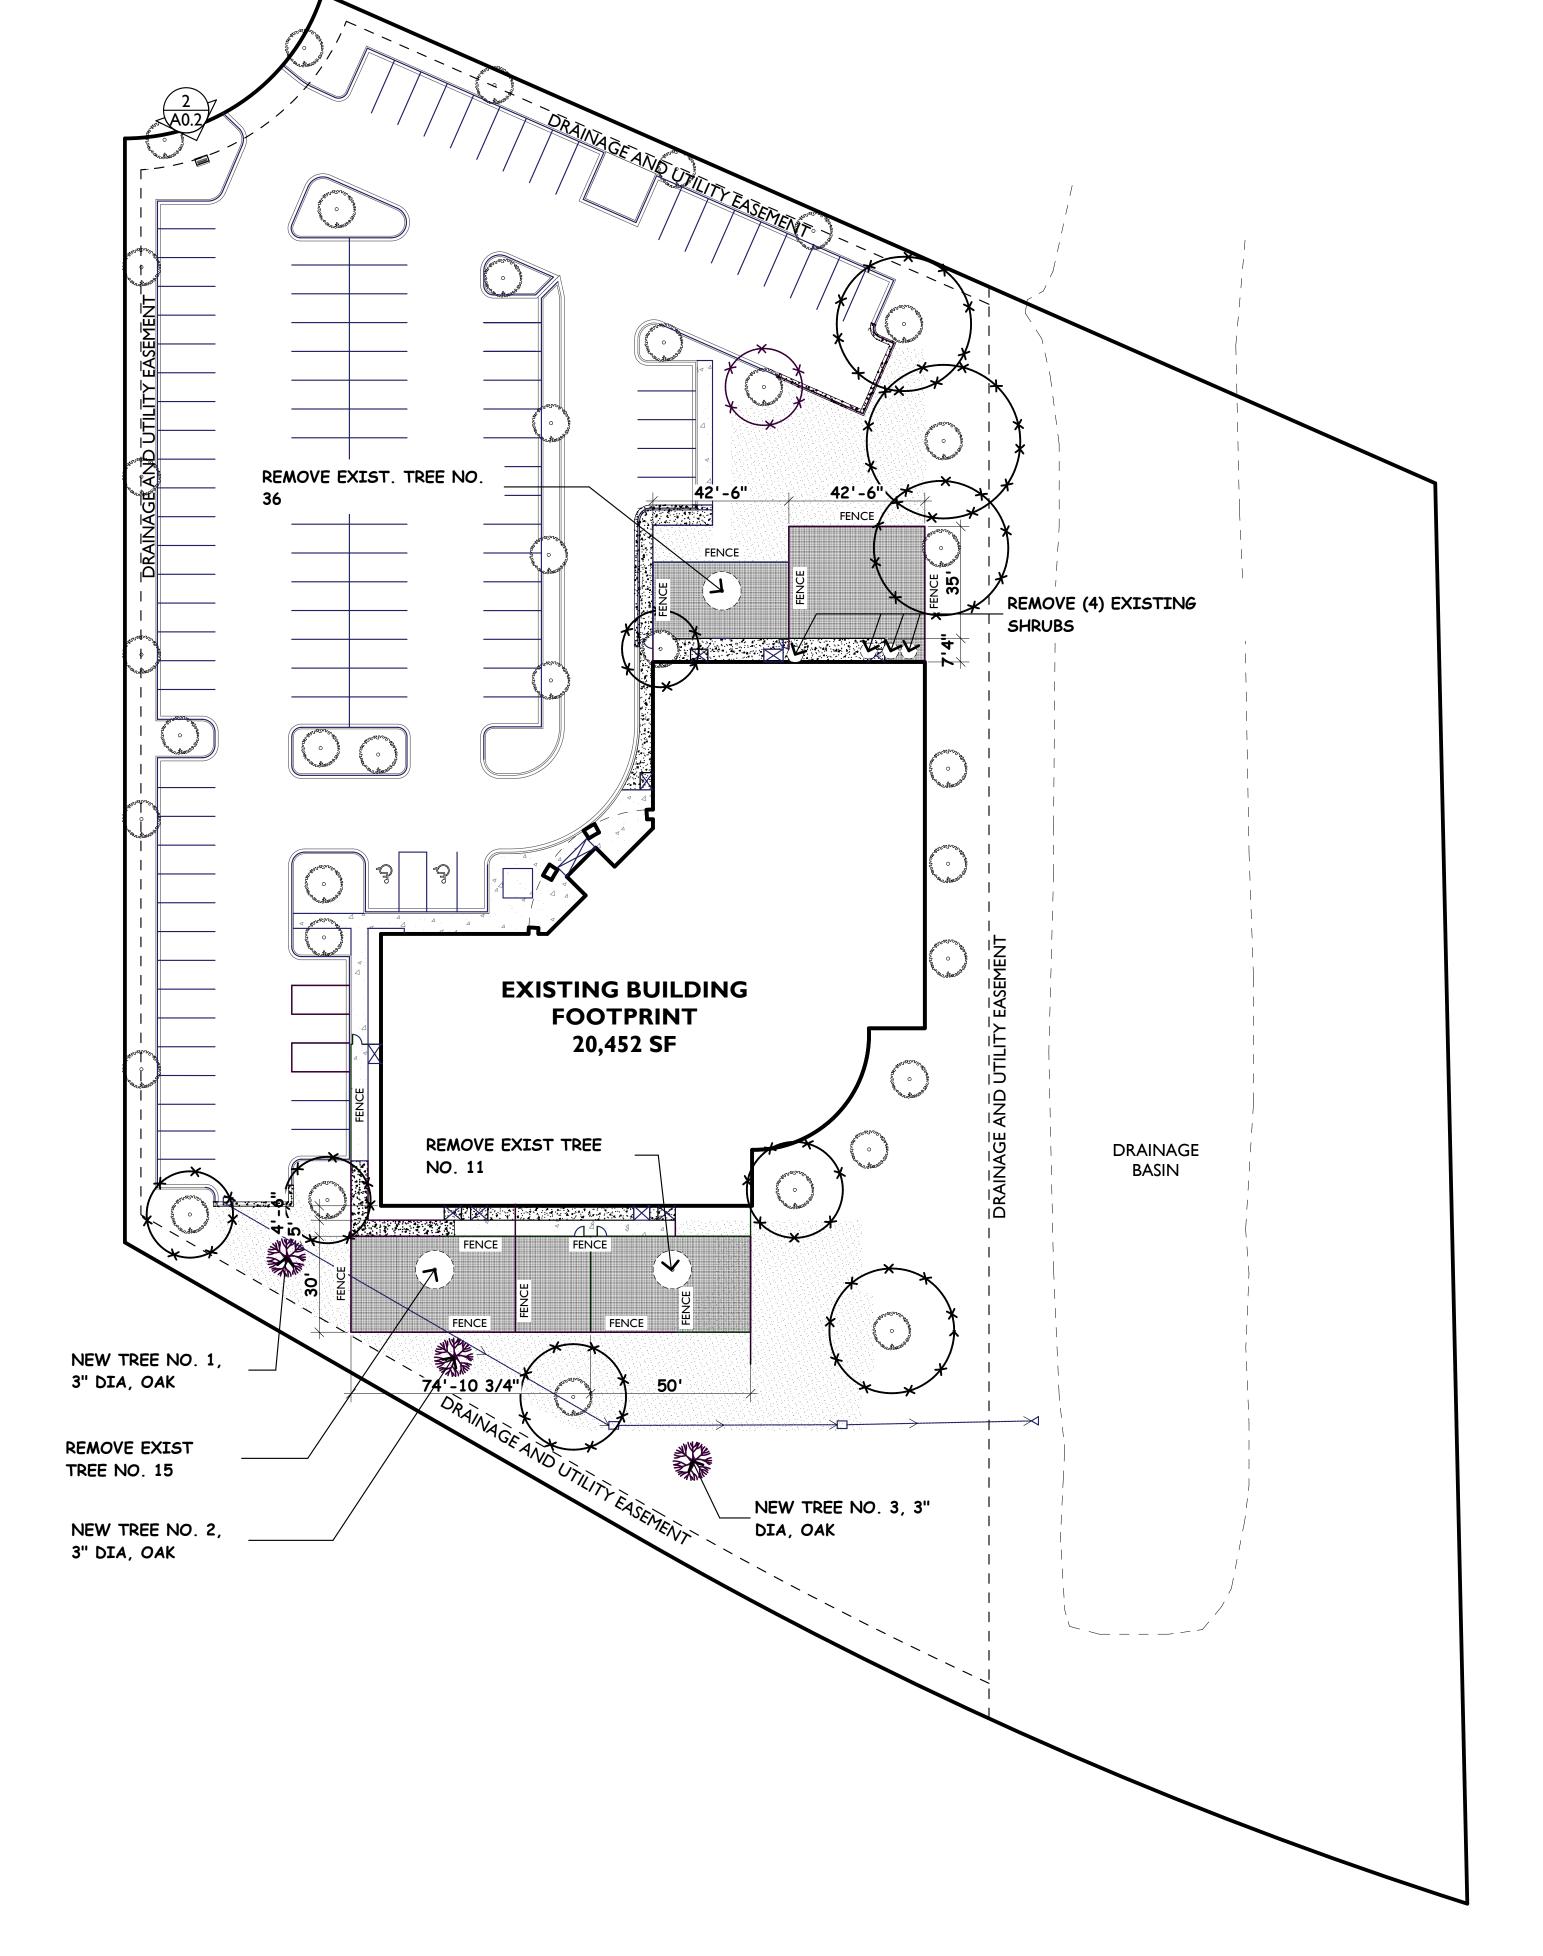

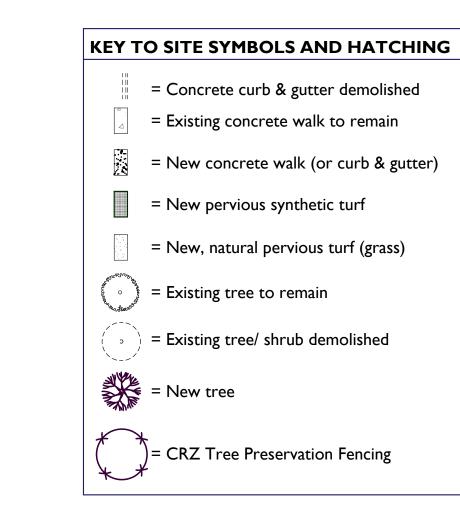



4918 S. Tri Oak Circle NE East Bethel, MN 55092 Phone: 651-245-2346 Email: mjtallc2520@gmail.com Web:michaeljthomasarchitect.com



Project No: 25004

Date Last Revised:
02-11-25, 02-18-25, 02-19-25,
02-20-25, 02-24-25, 02-26-25,
02-27-25, 03-25-25, 03-29-25,
04-02-25

File Name:
25004 Milestones Woodbury\_Lake
Elmo 04-02-25.pln
Drawn By:
MJT

Minnesota License No.: 23592

**Date Signed:** 02-27-25

I hereby certify that this plan, specification, or report was prepared by me or under my direct supervision and that I am a duly Licensed Architect under the laws of the State of Minnesota.

<u>Signature</u>

Michael j. Homes

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time use on the site indicated on these plans.

LANDSCAPE & TURF

ly Learning Center
Rebalitation

of the Existing Rasmus 8565 Eagle Point Circle Lake Elmo, MN 55042

Milestones Early L
Adaptive Reuse - Ret

- Position tree so root flare is

at or slightly above finished

- Prior to mulching, lightly tamp soil around the root ball in 6"

lifts to brace tree. Do not over

compact. When the planting hole has been backfilled, pour

water around the root ball to

- Create a smooth transition

- Mulch: 4" depth; No more

than 1" of Mulch on top of

root ball; See specifications for Mulch

Planting Soil: MnDOT 3877 F

Boulevard Topsoil Borrow; Planting Soils that are compacted after placement due to other construction

activities need to be tilled

Existing soil

prior to planting operations.

from the top of the raised root ball to the finished grade at a

settle the soil.

15% max. slope.

Chapter 3 Use and Occupancy Classification

Table 302.2 Care Facilities Child Care Center <24 hours per day

Actual = 22 feet 6 inches

Actual = 1 Story

More than 5 children </= 2.5 years of age and not classified as E. Occupancy Classification I-4

Section 308, Item 308.5.1.3 Child day care.

This building does not meet item "c.". Not all rooms providing day care have an exit door directly to the exterior. Therefore, it shall not be classified as Group E.

Chapter 5 General Building Heights and Areas

<u>Table 504.3 Allowable Building Height In Feet Above Grade Plane</u> Occupancy Class I-4 Group. Type VB, Sprinklered = 40 feet

Table 504.4 Allowable Number of Stories Above Grade Plane Occupancy Class I-4 Group. Type VB, Spinklered = 2 Stories

Table 506.2 Allowable Area Factor In Square Feet

Occupancy Class I-4 Group. Type VB, Sprinklered, Single Story = 36,000 SF Actual = 20,452

Chapter 6 Types of Construction

<u>Table 601.</u>

O Hour Fire-resistance Rating required for all elements. Type VB

<u>Table 602.</u>

All exterior walls are equal or greater than 30' from property lines. Therefore not fire-resistive rating required.

Chapter 9 Fire Protection Systems

Section 903.2.6 Group I

An automatic sprinkler system shall be provided throughout. This I-4 building does not meet Exception 2.

Chapter 10 Means of Egress

Table 1004.5 Maximum Floor Area Allowances per Occupant.

Day care = 35 net Occupant Load Factor Infants = 32 Toddlers = 67 Early Preschool = 21 Preschool = 152 By Room Area Per Code Plan = 272 Exercise rooms (Indoor Play Area) = 50 gross Occupant Load Factor

 $1.847 \, sf/50 = 36.9$ , or round down to **36** Occupants

Total Per Code = 308 Occupants

<u>Section 1004.5, Exception:</u> Where approved by the building official, the actual number of occupants for whom each occupied space, floor of building is designed, although less than those determined by calculation shall be permitted to be used in the determination of the design occupant load.

Actual Occupant Load based upon state day care license and intended building use.

Infants = 24 Toddlers = 56 Early Preschool = 20 Preschool = 150

Infant & Children Occupants = 230. Actual Based Upon Licensing

Note: Sport Court Area occupancy not included in licensed occupant load. Children will either be in classroom, outside, or Indoor Play Area.

Staff Occupancy

Infant = 1:4 Ratio = 24/4 = 6 staff Toddler = 1:7 Ratio = 56/7 = 8 staff Preschool = 1:10 Ratio = 150/10 = 15 staff Support Staff Administrative = 3 staff Food Service/ Custodian = 1 Staff Total Staff = **33** 

Total Actual Occupant Load 230 + 33 = 263 Occupants

Section 1006.2.2.4 Group E and I-4 means of egress

Rooms or spaces where care is provided for more than 10 children that are 2 1/2 years of ages or less, shall have access to not less than two exits or exit access doors. All care rooms have two exits. Either to corridor or directly to exterior.

Table 1020.1 Corridor Fire-Resistance Rating I-4 Occupancy, with sprinkler system = 0.

Section 1005.3.2 Minimum Width Other Egress Components

310 occupants  $\times$  0.2 = 62" Required. Main Entry pair of 3' doors = 6' West Building Exit door = 3' South Building Exit door = 3' Total = 12' or 144"

Table 1017.2 Exit Travel Distance

I-4 With Sprinkler System = 200' See Code Plan for actual distances

Section 1020.4 Dead Ends Shall not exceed 20'

Chapter 29 Plumbing Systems

Table 2902.1 Minimum Plumbing Fixtures Institutional.

308 Occupants by Table 1004.5

283 Occupants by Licensing and Actual Use.

Subtract 24 Infants, because infants do not use plumbing fixtures. Therefore the load used for plumbing fixture count will be 283-24 = 259

Do to use and licensing requirements, all child toilet and lavatories are shown to be unisex. A separate Men's and separate Women's toilet room will be provided for adult staff and visitors.

Water Closets Required = 259/15 = 17.27, round up to 18Provided = 18 Child Unisex = 15 Men's = 1Women's = 1

Unisex = 1

Lavatories

Required = 259/15 = 17.27, round up to 18

(not inleuding Warming Kitchen or classroom counter sinks) Unisex Hand Washing Lavatories = 21 Men's Lavatory = 1 Women's Lavatory = 1

Unisex = 1

Bathtub/ Shower = 0 Required. Propose to provide 0.

Drinking Fountains = 259/100 = 2.59 or round up to <u>3</u> Required. Provided = 3

Service Sink = 1 Required. 1 Provided.

Urinals = 1 provided at existing Mens

2020 Minnesota Provisions to the Minnesota State Building Code

1303.1500 Recycling Space, Table 1-A. Children's homes and homes for the aged = .0025 factor. 20,452 SF x .0025 = 51.13 SF required. 129 SF provided.

2020 MINNESOTA ENERGY CODE

Table C301.1 Climate Zone.

Washington, Minnesota = 6A (Moist).

Section C402 Building Envelope Requirements Prescriptive. Prescriptive Method for compliance proposed.

Table 402.1.3 Opaque Thermal Envelope Insulation Component Minimum Requirements, R-Value Method

Roof, Insulation Entirely Above Deck = R-30 CI Walls Above Grade, Wood Framed (walls) = R-20 + R-3.8 CI Below Grade Walls = R-7.5 CI Unheated Slab-on-grade Floors = R-10 for 24" below.

Table C402.4 Building Envelope Fenestration Maximum U-Factor and SHGC Requirements

Fixed Fenestration = 0.36 U-factor or less Operable Fenestration = 0.43 U-factor or less Entrance Doors = 0.77 U-factor or less SHGC (PF < 0.2) = SEW 0.40 / N 0.53

Section C402.5.1 Air Barrier Compliance Options

Continuous Air Barrier with air permeability no greater than 0.004 cfm/ft2 under pressure differential of 0.3 inches w.g..

Building Mechanical and Electrical Systems will be Design/Build by applicable subcontractor. It shall be said subcontractor's responsibility to design their system to meet all applicable energy code (and other codes) requirements.

### 2020 MINNESOTA ACCESSIBILITY CODE

Chapter 11 of the 2018 IBC w/MN Amendments Section 1104.4 Accessible Route Multilevel Buildings and Facilities. This is a single story building.

Section 1105 Accessible Entrances.

The main entrance is the accessible route. However, all classroom exterior play area doors are designed to be accessible as well.

Section 1106 Parking and Passenger Loading Facilities See Conceptual Architectural Site Plan

<u>Table 1106.1</u>

101 to 150 parking spaces requires 5 to be accessible. Actual existing = (5) accessible parking spaces + (104) standard parking spaces = (109) total provided.

1109.2.2 Water closet compartment

At least 5% of water closet compartments in each toilet room shall be accessible. If two or more water closets are provided, at least 5% shall be ambulatory accessible. Therefore, all locations where toilet rooms have toilet compartments, all will have one child accessible and one child ambulatory accessible compartments.

Section 1109.5 Drinking Fountains

Not fewer than two drinking fountains shall be provided. Existing = One drinking fountain complies with the requirements for people who use a wheel chair and one drinking fountain complies with requirements for standing persons.

Section 1109.12.3 Point of sale and service counters. The main entry/lobby service counter is accessible.

Section 1109.13 Controls, operating mechanisms and hardware All door hardware is lever handle or stationary puch/pulls.

Section 1111 Signage

To be by Owner, but will comply.

Chapter 4

Section 406 Curb Ramps. The main entry and access from accessible parking access isle includes curb ramp to comply.

Chapter 5

Section 502 Parking Spaces. (4) accessible parking spaces 9' wide x 19' deep with an 8' minimum wide access isle provided.

<u>Chapter 6</u>

Section 602.4 Spout outlet heights for drinking fountains. (1) at 36" max. for wheel chair use and (1) between 38"-43" for standing persons provided.

Section 603.1

Clearances, door swings, mirrors, operable parts at all adult accessible toilet rooms and child accessibble toilet rooms comply.

Section 604 Water Closets and Toilet Compartments. Clearances an grab bars shown to comply with Adult and Child accessible requirements.

Section 606 Lavatories and Sinks

All adult and child accessible toilet rooms include lavatories at 34" height, 27" clearance, & 30" widths.

Section 804.3 Kitchens and Kitchenettes. Work surface. At the infant feeding kitchen and at the employee break room, there is no cooktop or conventional range, therefore these spaces are not designed to comply with clearance or work surface heights.

Section 804.4 Sinks.

All counter sinks comply with Section 606. 34" Height. Removable sink base or open space to comply with Section 306.

APPLICABLE CODES:

2020 Minnesota Building Code

2024 Minnesota Energy Code

2020 Minnesota Accessibility Code

2020 Minnesota Mechanical and Fuel Gas Code

2020 Minnesota Plumbing Code


2020 Minnesota Fire Code

Minnesota Electrical Coded

Note: Due to the adaptive reuse of this building where the E occupancy is changed to an I-4 occupancy and the amount of space reconfiguration, the MN Conservation Code is not used.

2020 Minnesota Provisions to the State Building Code

NFPA 13 Standard for the Installation of Sprinkler Systems

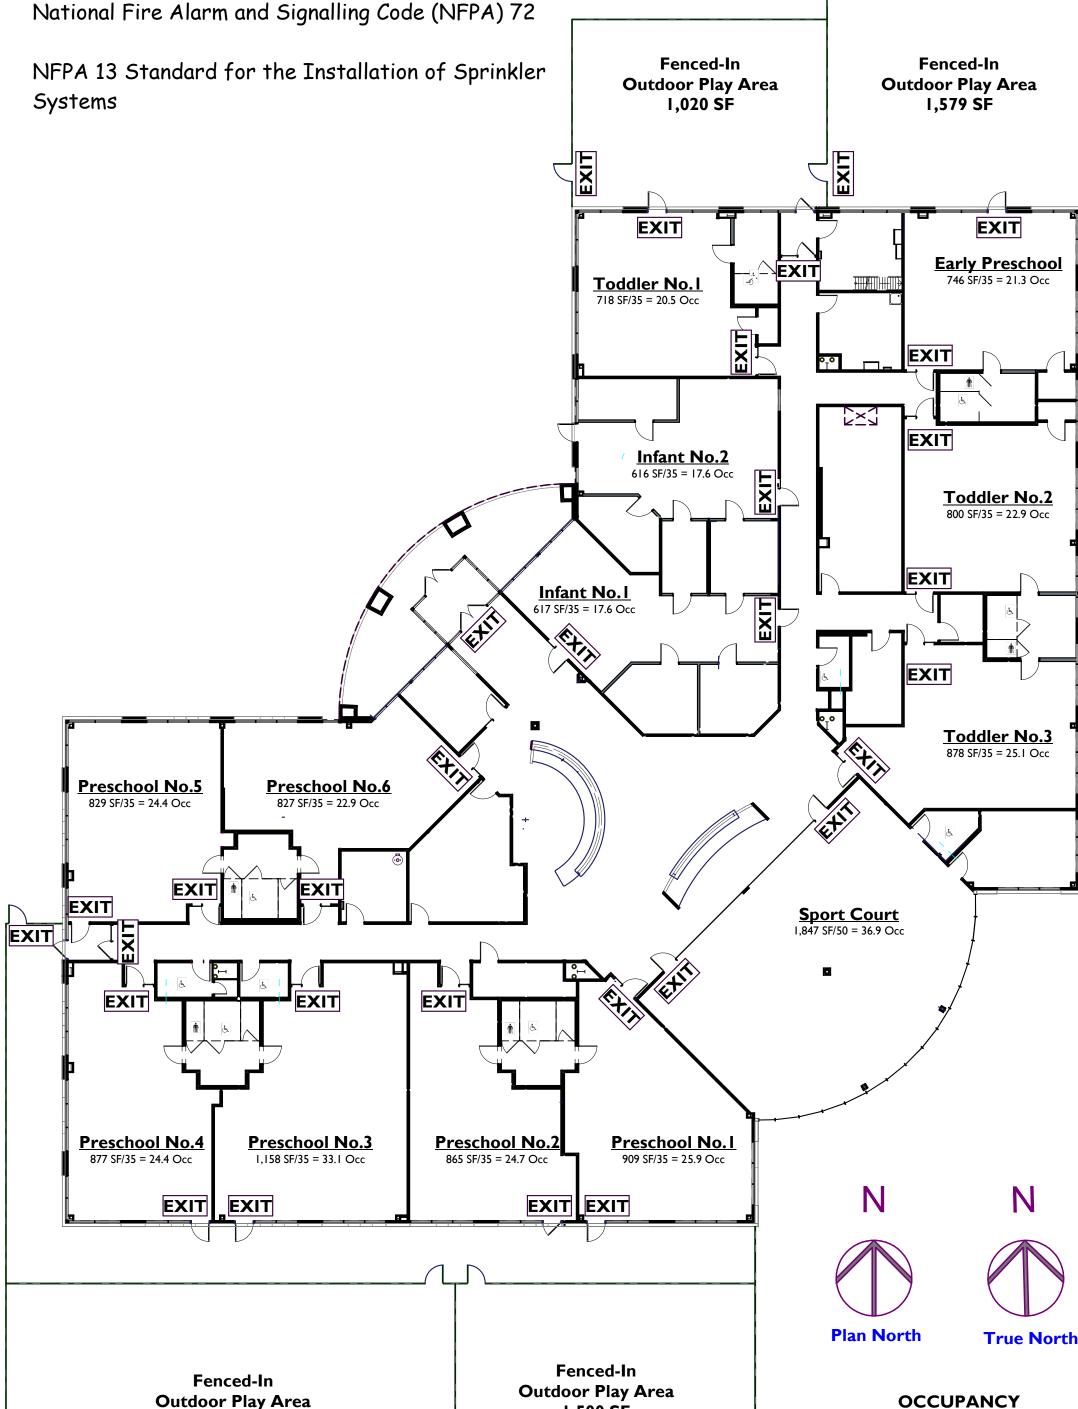



4918 S. Tri Oak Circle NE East Bethel, MN 55092 Phone: 651-245-2346 Email: mjtallc2520@gmail.com Web:michaeljthomasarchitect.com



**Project No:** 

**Date Last Revised:** 02-11-25, 02-18-25, 02-19-25, 02-20-25, 02-24-25, 02-26-25, 02-27-25, 03-25-25, 03-29-25, 04-02-25

File Name: 25004 Milestones Woodbury\_Lake Elmo 04-02-25.pln **Drawn By:** 

Minnesota License No. 23592

**Date Signed:** 02-27-25

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**Signature** 

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conditioned on the full and timely payment of al

**CODE INFORMATION** 

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**A0.5** 

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56 ak

1,500 SF

2,247 SF

**INSTITUTIONAL I-4** 

20,452 Gross sq ft





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# <u>**Project No:**</u> 25004

<u>Date Last Revised:</u> 02-11-25, 02-18-25, 02-19-25, 02-20-25, 02-24-25, 02-26-25, 02-27-25, 03-25-25, 03-25-25

File Name:
25004 Milestones Woodbury\_Lake
Elmo 04-02-25.pln
Drawn By:
MJT

Minnesota License No.: 23592

**Date Signed:** 02-27-25

I hereby certify that this plan, specification, or report was prepared by me or under my direct supervision and that I am a duly Licensed Architect under the laws of the State of Minnesota.

<u>Signature</u>



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FIRST STORY
DEMOLITION PLAN

nter ity Building


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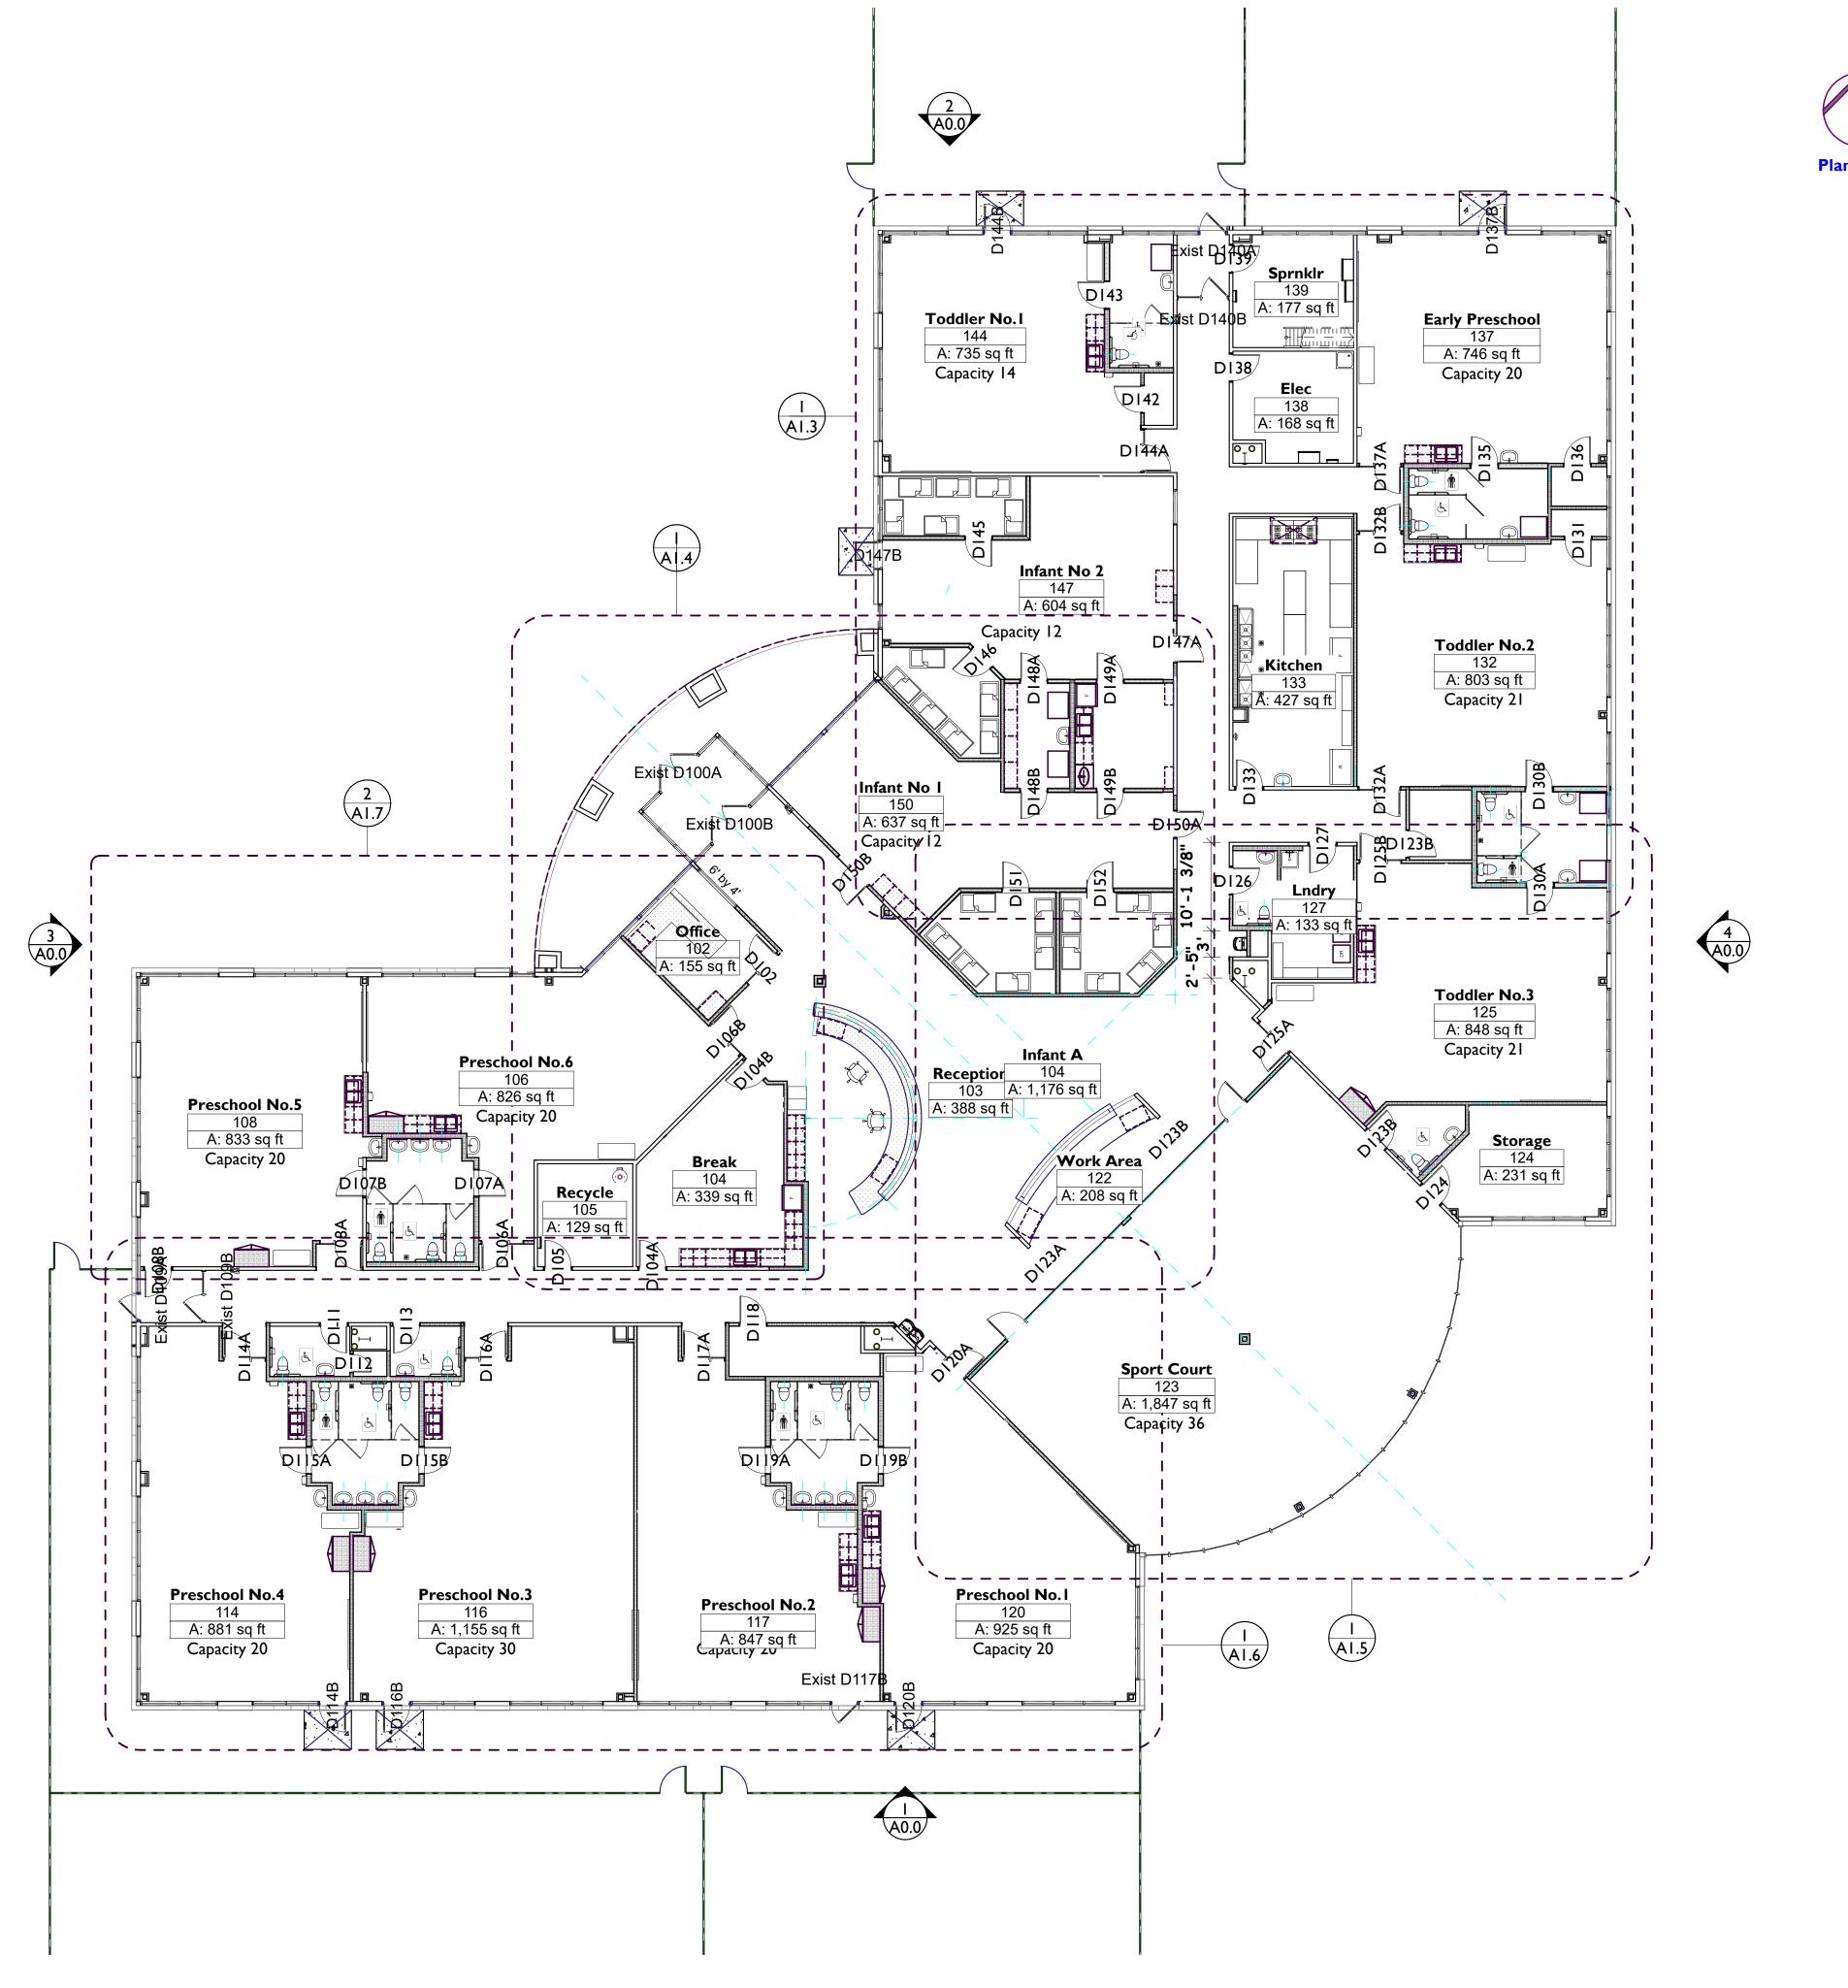
565 Eagle Point Circle

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# Project No: 25004

<u>Date Last Revised:</u> 02-11-25, 02-18-25, 02-20-25, 02-24-25, 02-26-25, 02-27-25, 03-25-25, 03-29-25, 04-02-25

File Name: 25004 Milestones Woodbury\_Lake Elmo 04-02-25.pln <u>Drawn By:</u> MJT

Minnesota License No.: 23592

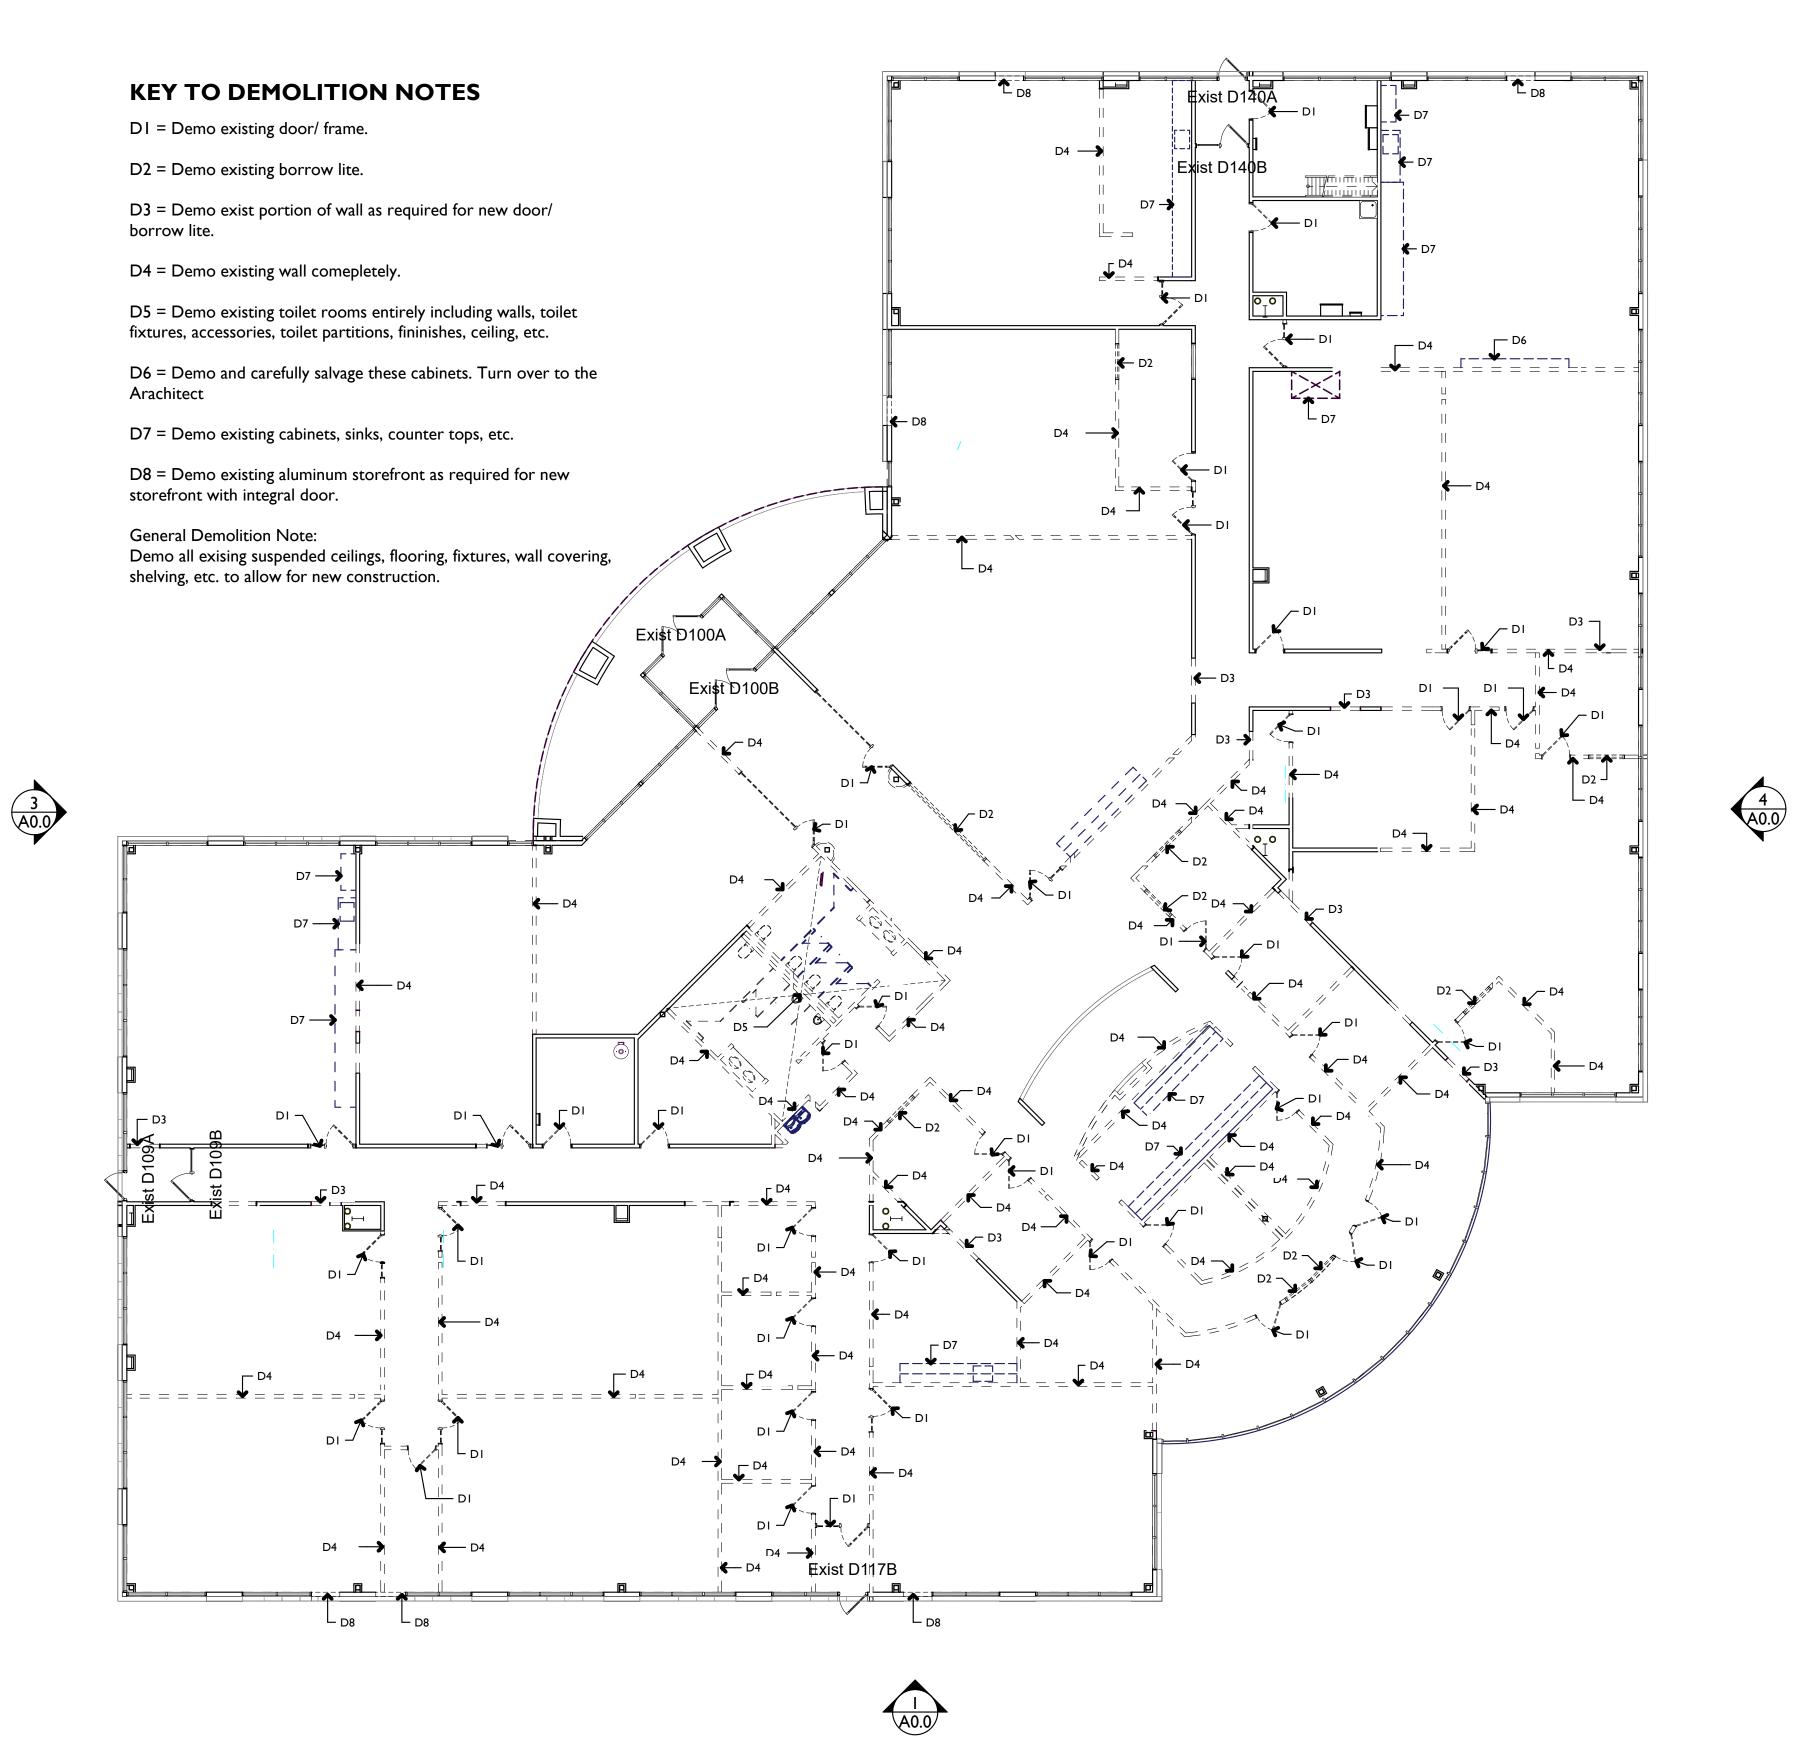**Date Signed:** 02-27-25

I hereby certify that this plan, specification, or report was prepared by me or under my direct supervision and that I am a duly Licensed Architect under the laws of the State of

<u>Signature</u>

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FIRST STORY NEW FLOOR PLAN

**Milestones Early Learning** Adaptive Reuse - Rebalitation of the Existing Rasmussen Uni

8565 Lake

AI.I